Community Services Department Planning and Development SPECIAL USE PERMIT APPLICATION



Washoe County Development Application

Your entire application is a public record. If you have a concern about releasing personal information, please contact Planning and Development staff at 775.328.3600.

Project Information	s	Staff Assigned Case No.:				
Project Name:						
Project Description:						
Project Address:						
Project Area (acres or square fe	et):					
Project Location (with point of re	ference to major cross	streets AND area locator):				
Assessor's Parcel No.(s):	Parcel Acreage:	Assessor's Parcel No(s):	Parcel Acreage:			
Section(s)/Township/Range:						
Indicate any previous Washo Case No.(s).	e County approval	s associated with this applicat	ion:			
Applicant	Information (atta	ch additional sheets if necessary	/)			
Property Owner:		Professional Consultant:				
Name:		Name:				
Address:		Address:				
	Zip:		Zip:			
Phone:	Fax:	Phone:	Fax:			
Email:		Email:				
Cell:	Other:	Cell:	Other:			
Contact Person:		Contact Person:				
Applicant/Developer:		Other Persons to be Contacted:				
Name:		Name:				
Address:		Address:				
	Zip:		Zip:			
Phone:	Fax:	Phone:	Fax:			
Email:		Email:				
Cell:	Other:	Cell:	Other:			
Contact Person:		Contact Person:				
	For Office	Use Only				
Date Received:	Initial:	Planning Area:				
County Commission District:		Master Plan Designation(s):				
CAB(s):		Regulatory Zoning(s):				

Property Owner Affidavit

Applicant Name:
The receipt of this application at the time of submittal does not guarantee the application complies with all requirements of the Washoe County Development Code, the Washoe County Master Plan or the applicable area plan, the applicable regulatory zoning, or that the application is deemed complete and will be processed.
STATE OF NEVADA
COUNTY OF WASHOE)
I,(please print name)
(please print name)
being duly sworn, depose and say that I am the owner* of the property or properties involved in this application as listed below and that the foregoing statements and answers herein contained and the information herewith submitted are in all respects complete, true and correct to the best of my knowledge and belief. I understand that no assurance or guarantee can be given by members of Planning and Development. (A separate Affidavit must be provided by each property owner named in the title report.)
Assessor Parcel Number(s):
Printed Name
Cianad
Signed
Address
Subscribed and sworn to before me this day of, (Notary Stamp)
Notary Public in and for said county and state
My commission expires:
*Owner refers to the following: (Please mark appropriate box.) Owner Corporate Officer/Partner (Provide copy of recorded document indicating authority to sign.) Power of Attorney (Provide copy of Power of Attorney.)
 Owner Agent (Provide notarized letter from property owner giving legal authority to agent.) Property Agent (Provide copy of record document indicating authority to sign.) Letter from Government Agency with Stewardship

Special Use Permit Application Supplemental Information

(All required information may be separately attached)

Chapter 110 of the Washoe County Code is commonly known as the Development Code. Specific references to special use permits may be found in Article 810, Special Use Permits.

1.	What is the type of project being requested?
2.	What currently developed portions of the property or existing structures are going to be used with this permit?
3.	What improvements (e.g. new structures, roadway improvements, utilities, sanitation, water supply, drainage, parking, signs, etc.) will have to be constructed or installed and what is the projected time frame for the completion of each?

4.	What is the intended phasing schedule for the construction and completion of the project?
5.	What physical characteristics of your location and/or premises are especially suited to deal with the impacts and the intensity of your proposed use?
3.	What are the anticipated beneficial aspects or effects your project will have on adjacent properties
).	and the community?
7.	What will you do to minimize the anticipated negative impacts or effects your project will have or adjacent properties?

	project special use permit to address community impacts:
	How many improved parking spaces, both on-site and off-site, are available or will be provide (Please indicate on site plan.)
	What types of landscaping (e.g. shrubs, trees, fencing, painting scheme, etc.) are proposed? (Plea indicate location on site plan.)
,	What type of signs and lighting will be provided? On a separate sheet, show a depiction (heig width, construction materials, colors, illumination methods, lighting intensity, base landscaping, et of each sign and the typical lighting standards. (Please indicate location of signs and lights on splan.)

☐ Yes	□ No	
Community Sewer		
☐ Yes	□ No	
ommunity Water		
☐ Yes	□ No	

PROJECT SUPPORT STATEMENT

DEVEPLOMENT APPLICATION FOR VERIZON SITE "WEST ZOLEZZI"

APN 152-021-03

2905 ARROWCREEK PARKWAY, RENO, NV 89511

INTRODUCTION

Verizon Wireless is seeking to improve communications service in the Reno Nevada region north of Highway 431 and west of Interstate 580, and for purposes of this application specifically in the Arrowcreek community. Verizon would like to increase coverage and capacity in the area by locating a new telecommunications facility in order to increase and improve coverage and capacity for both current and potential customers. Additionally, this network development will increase public safety within these areas and bring wireless service to areas that currently have poor capacity service.

This tower will help alleviate an area of poor coverage within this service area, which causes reoccurring lost calls, ineffective service, and slow data speeds. To remedy these problems, Verizon proposes to develop a wireless facility at 2905 Arrowcreek Parkway. The proposed location of the tower is set within an unutilized portion of this parcel and will be designed to comply with Washoe County wireless design guidelines. The proposed Verizon communications facility will be located within a 30' x 30' fenced compound including: outdoor equipment cabinets and a 56' monopine that will accommodate (4) sectors with (2) antennas per sector, (8) remote radio units (RRU's) and (2) microwave dishes. The tower will also accommodate (1) future carrier's antenna centerline.

This unmanned facility will provide service to area travelers, residents and businesses 24 hours a day, 7 days a week. This site will also serve as a back up to the existing landline service in the area and will provide improved mobile communications, essential to modern day commerce, recreation, and public safety.

SAFETY BENEFITS OF IMPROVED WIRELESS SERVICE

Mobile phone use has become an extremely important system for public safety. Along roads and highways without public call boxes, mobile phones are often the only means for emergency roadside communication. Motorists with disabled vehicles (or worse) can use their phone to call in and request appropriate assistance. With good cellular coverage along important roadways, emergency response is just a phone call away. Furthermore, as a back up system to traditional landline phone service, mobile phones have proven to be extremely important during natural disasters and other catastrophes.

CONVENIENCE BENEFITS OF IMPROVED WIRELESS SERVICE

Modern day life has become increasingly dependent on instant communications. Whether it is a parent calling their child, spouse calling a spouse, or general contractor ordering materials to the jobsite, wireless phone service is no longer just a convenience. It has become a way of life and a way of business.

COMPLIANCE WITH COUNTY DEVELOPMENT STANDARDS

This project has been carefully designed to comply with applicable standards. Verizon Wireless is requesting approval of their proposed facility without further landscaping requirements, as landscape is already present at the edges of the proposed location. The location of the facility is at a remote area of

the Arrowcreek Country Club parking lot in the middle of the 149 ac. parcel adjacent a golf course maintenance building, uphill, non-visible from the closest public right of way approx. 430' away, making ground-level and bottom-half of the proposed monopine invisible to the public. Existing landscape and trees similarly shield the ground level from view or dwellings 200' away to the south. Verizon is proposing to use a stucco-faced equipment wall to better blend with the established buildings on the parcel and surroundings.

COMPLIANCE WITH FCC STANDARDS

This project will not interfere with any TV, radio, telephone, satellite, or any other signals. Any interference would be against the Federal Law and would be a violation Verizon Wireless' FCC License. In addition, this project will conform to all FCC standards.

TECHNOLOGY AND CONSUMER SERVICES THE CARRIER WILL PROVIDE ITS CUSTOMERS

Verizon offers its customers multiple services such as, voice calls, text messaging, mobile email, picture/video messaging, mobile web, navigation, broadband access. Wireless service enhances public safety and emergency communications in the community. In rural areas such as the subject location, cellular phone service can cover much larger geographic areas than traditional landline phone service.

FUTURE COLLOCATION OPPORTUNITIES

The proposed site has been designed to allow for future co-location opportunities with other carriers. The land lease provides sufficient space for additional service providers and the tower and its foundation are designed for future equipment. This tower will eliminate the need for multiple towers within the same general vicinity as it has been designed to accommodate up to (1) carrier and its associated ground equipment.

LIGHTING

Unless tower lighting is required by the FAA there will be no additional lighting.

NOISE

De minimus white noise from electronic devices within the fenced Premises is expected. A backup generator, quiet as it is (63db at 23'), is not being requested in this application. Non-native noise will be nearly undetectable.

HAZARDOUS MATERIAL

A Hazardous Material Business Plan will also be submitted upon project completion, and stored on site after construction

ENVIRONMENTAL SETTING

Verizon Wireless is proposing to build a monopine tower to look like a natural pine tree to blend in with the existing trees and buildings adjacent the Arrowcreek Country Club clubhouse and cart storage/repair facility at the confluence of existing landscape and parking lot.

MAINTENANCE AND STANDARD GENERATOR TESTING

Verizon will not be installing a standby diesel generator at this cell site.

CONSTRUCTION SCHEDULE

The construction of the facility will be in compliance with all local rules and regulations. The typical duration is two months. The crew size will range from two to ten individuals.

PUBLIC HEARING APPLICATION AND MEETING DATES								
BOARD OF		AGENCY	ADMINISTRATIVE		PARCEL MAP REVIEW			
PLANNING	COMMISSION	ADJUST	MENT	COMMENTS	PERI	MITS	COMM	NITTEE
Intake	Meeting	Intake	Meeting		Intake	BOA Mtg	Intake	Meeting
Date	Date	Date	Date	Due Date	Date	Date	Date	Date
11/16/2015	01/05/2016			12/08/2015			12/01/2015	01/14/2016
12/15/2015	02/02/2016	12/15/2015	02/04/2016	01/05/2016	01/04/2016	02/04/2016	01/04/2016	02/11/2016
01/15/2016	03/01/2016			02/02/2016			02/01/2016	03/10/2016
02/16/2016	04/05/2016	02/16/2016	04/07/2016	03/08/2016	03/01/2016	04/07/2016	03/01/2016	04/14/2016
03/15/2016	05/03/2016			04/05/2016			04/01/2016	05/12/2016
04/15/2016	06/07/2016	04/15/2016	06/02/2016	05/05/2016	05/02/2016	06/02/2016	05/02/2016	06/09/2016
05/16/2016	07/05/2016			06/07/2016			06/01/2016	07/14/2016
06/15/2016	08/02/2016	06/15/2016	08/04/2016	07/05/2016	07/01/2016	08/04/2016	07/01/2016	08/11/2016
07/15/2016	09/06/2016			08/09/2016			08/01/2016	09/08/2016
08/15/2016	10/04/2016	08/15/2016	10/06/2016	09/06/2016	09/01/2016	10/06/2016	09/01/2016	10/13/2016
09/15/2016	11/01/2016			10/04/2016			10/03/2016	11/10/2016
10/17/2016	12/06/2016	10/17/2016	12/01/2016	11/03/2016	11/01/2016	12/01/2016	11/01/2016	12/08/2016
11/15/2016	01/03/2017			12/06/2016			12/01/2016	01/12/2017
12/15/2016	02/07/2017	12/15/2016	02/02/2017	01/05/2017	01/03/2017	02/02/2017	01/03/2017	02/09/2017

	COM	JUNITY SE	RVICES DEPAR	TMENT	FEES	HEALTH	1 FEES	
	Plan	ning			Health District			
APPLICATIONS	PLANNING	NOTICING	ENGINEERING	PARKS	UTILITIES	ENVIRON.	VECTOR	TOTAL
REVERSION TO ACREAGE (See Note 5)								
Not Tahoe	\$51	-	\$215	-	\$26	-	-	\$292
Tahoe	\$51	-	\$215	-	-	-	-	\$266
SIGN PERMIT INSPECTION - (Permanent or Temporary)			To	Be Determ	nined			
SPECIAL USE PERMIT								
Residential								
Not Tahoe	\$1,162				\$203		\$118	
Tahoe	\$1,162		\$65	-	-	\$244	\$118	
With Environmental Impact Statement	\$1,162	-		-	-		-	\$1,162
Commercial, Industrial, Civic								
Minor (See Note 7)	\$2,165	\$200	\$130	-	\$203		\$118	\$3,060
Major (See Note 7)	\$2,165			-	\$203	\$244	\$118	
Tahoe Minor (See Note 7)	\$2,165		·		-	\$244	\$118	
Tahoe Major (See Note 7)	\$2,165		\$520	-	-	\$244	\$118	
With Environmental Impact Statement	\$2,240	-	-	-	-	-	-	\$2,240
TENTATIVE PARCEL MAP/PARCEL MAP WAIVER (See Note 5)								
No System	\$803		\$345	-	\$68	\$776	\$269	\$2,461
1 System (Sewer)	\$803	\$200	\$345	-	\$153	\$331	\$269	\$2,101
1 System (Water)	\$803	\$200	\$345	-	\$153	\$776	\$269	\$2,546
2 Systems	\$803	\$200	\$345	-	\$203	\$331	\$269	\$2,151
Tahoe (Sewer)	\$803	\$200	\$345	-	-	\$331	\$269	\$1,948
Sun Valley (No WC Utilities)	\$803	\$200	\$345	-	\$51	\$331	\$269	\$1,999
TENTATIVE SUBDIVISION MAP (See Notes 5 & 6)								
No System	\$2,422	\$200	\$1,299	\$129	-	\$1,016	\$193	\$5,259
1 System (Sewer)	\$2,422	\$200	\$1,299	\$129	\$2,039	\$374	\$193	\$6,656
1 System (No Sewer)	\$2,422	\$200	\$1,299	\$129	\$1,019	\$1,016	\$193	\$6,278
2 Systems	\$2,422		\$1,299	\$129	\$3,059		\$193	
Tahoe (Sewer)	\$2,422	\$200	\$1,299	\$129	-	\$374	\$193	\$4,617
With Hillside Ordinance - ADD	\$2,422		-	-	-	-	-	\$2,422
With Significant Hydrologic Resource - ADD	\$2,422		-	-	-	-	-	\$2,422
With Common Open Space - ADD	\$2,422	-	-	-	-	-	-	\$2,422

Property Owner Affidavit

Applicant Name: THOMAS H.R. GURNEY IN FRIENDS OF ARROWS
The receipt of this application at the time of submittal does not guarantee the application complies with all requirements of the Washoe County Development Code, the Washoe County Master Plan or the applicable area plan, the applicable regulatory zoning, or that the application is deemed complete and will be processed.
STATE OF NEVADA COUNTY OF WASHOE 1, THOMAS HARMS ROE GURNING. (please print name)
being duly sworn, depose and say that I am the owner* of the property or properties involved in this application as listed below and that the foregoing statements and answers herein contained and the information herewith submitted are in all respects complete, true and correct to the best of my knowledge and belief. I understand that no assurance or guarantee can be given by members of Planning and Development.
(A separate Affidavit must be provided by each property owner named in the title report.)
Assessor Parcel Number(s):
Printed Name THOMAS HATAND ROE GURNE E Signed FOR SKY TERRACE COURT
Subscribed and sworn to before me this 15 day of (Notary Stamp) KARA ANDERSON Notary Public in and for said county and state Notary Public in and for said county and state Notary Public in and for said county and state
My commission expires: Dec. 26, 2016
Owner refers to the following: (Please mark appropriate box.) Owner Corporate Officer/Partner (Provide copy of recorded document indicating authority to sign.) Power of Attorney (Provide copy of Power of Attorney.) Owner Agent (Provide notarized letter from property owner giving legal authority to agent.) Property Agent (Provide copy of record document indicating authority to sign.) Letter from Government Agency with Stewardship





2905 Arrowcreek Pkwy, Reno, NV Photosims Produced on 11-25-2015






2905 Arrowcreek Pkwy, Reno, NV Photosims Produced on 11-25-2015







288151 West Zolezzi 2905 Arrowcreek Pkwy, Reno, NV **Photosims Produced on 11-25-2015**

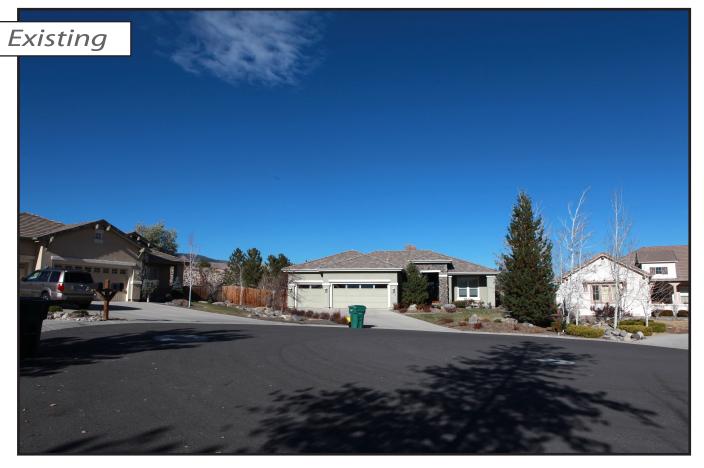



2905 Arrowcreek Pkwy, Reno, NV Photosims Produced on 11-25-2015

Verizon

POST INSTALLED CONCRETE WEDGE ANCHORS

OCCUPANCY AND CONSTRUCTION TYPE

FACILITY IS UNMANNED AND NOT FOR HUMAN HABITATION, ACCESSIBILITY ACCESS AND

REQUIREMENTS ARE NOT REQUIRED, IN ACCORDANCE WITH CALIFORNIA BUILDING CODE, CODE OF REGULATIONS, TITLE 24, PART 2, VOLUME 1, CHAPTER 11B, DIVISION 2, SECTION

OCCUPANCY: U (UNMANNED)

HANDICAP REQUIREMENTS

CONSTRUCTION TYPE: V-B

PROJECT: West Zolezzi - New Build

2905 ARROWCREEK PKWY **RENO, NV 89511**

LOCATION NO: 288151

GENERAL CONTRACTOR NOTES

MATERIAL ORDERS OR BE RESPONSIBLE FOR THE SAME.

THESE DRAWINGS ARE FORMATTED TO BE FULL SIZE AT 24" x 36". CONTRACTOR SHALL VERIFY ALL PLANS AND EXISTING DIMENSIONS AND CONDITIONS ON

THE JOBSITE AND SHALL IMMEDIATELY NOTIFY THE ARCHITECT/ENGINEER IN WRITING OF ANY DISCREPANCIES BEFORE PROCEEDING WITH THE WORK OR

DO NOT SCALE DRAWINGS

PREPARED FOR verizon 295 Parkshore Drive Folsom, California 94630



Project Address:

2905 Arrowcreek Pkwy Reno, NV 89511

	REV	Architect:
	В	ARCHITECTURE PLANNING INTERIORS INTERIORS ARCHITECTURE GROOP 1478 STONE POINT DRIVE SUITE 350 ROSEVILLE CA 95661 TJ 116 778 27200 FJ 916 773 3037
ARGEMEN	NT B	BORGESARCH.COM
	D	PROJECT NO: 20141021630
	В	LOCATION NO: 288151
S	В	DRAWN BY: B.K.W.
	В	CHECKED BY: B.K.W.
	В	
	В	

	2.112	DESCRIE ITOTA
Lic	ensor:	
		OF LAW FOR ANY

PERSON, UNLESS THEY ARE ACTING UNDER THE DIRECTION OF A LICENSED PROFESSIONAL ENGINEER, TO ALTER THIS

Issued For:


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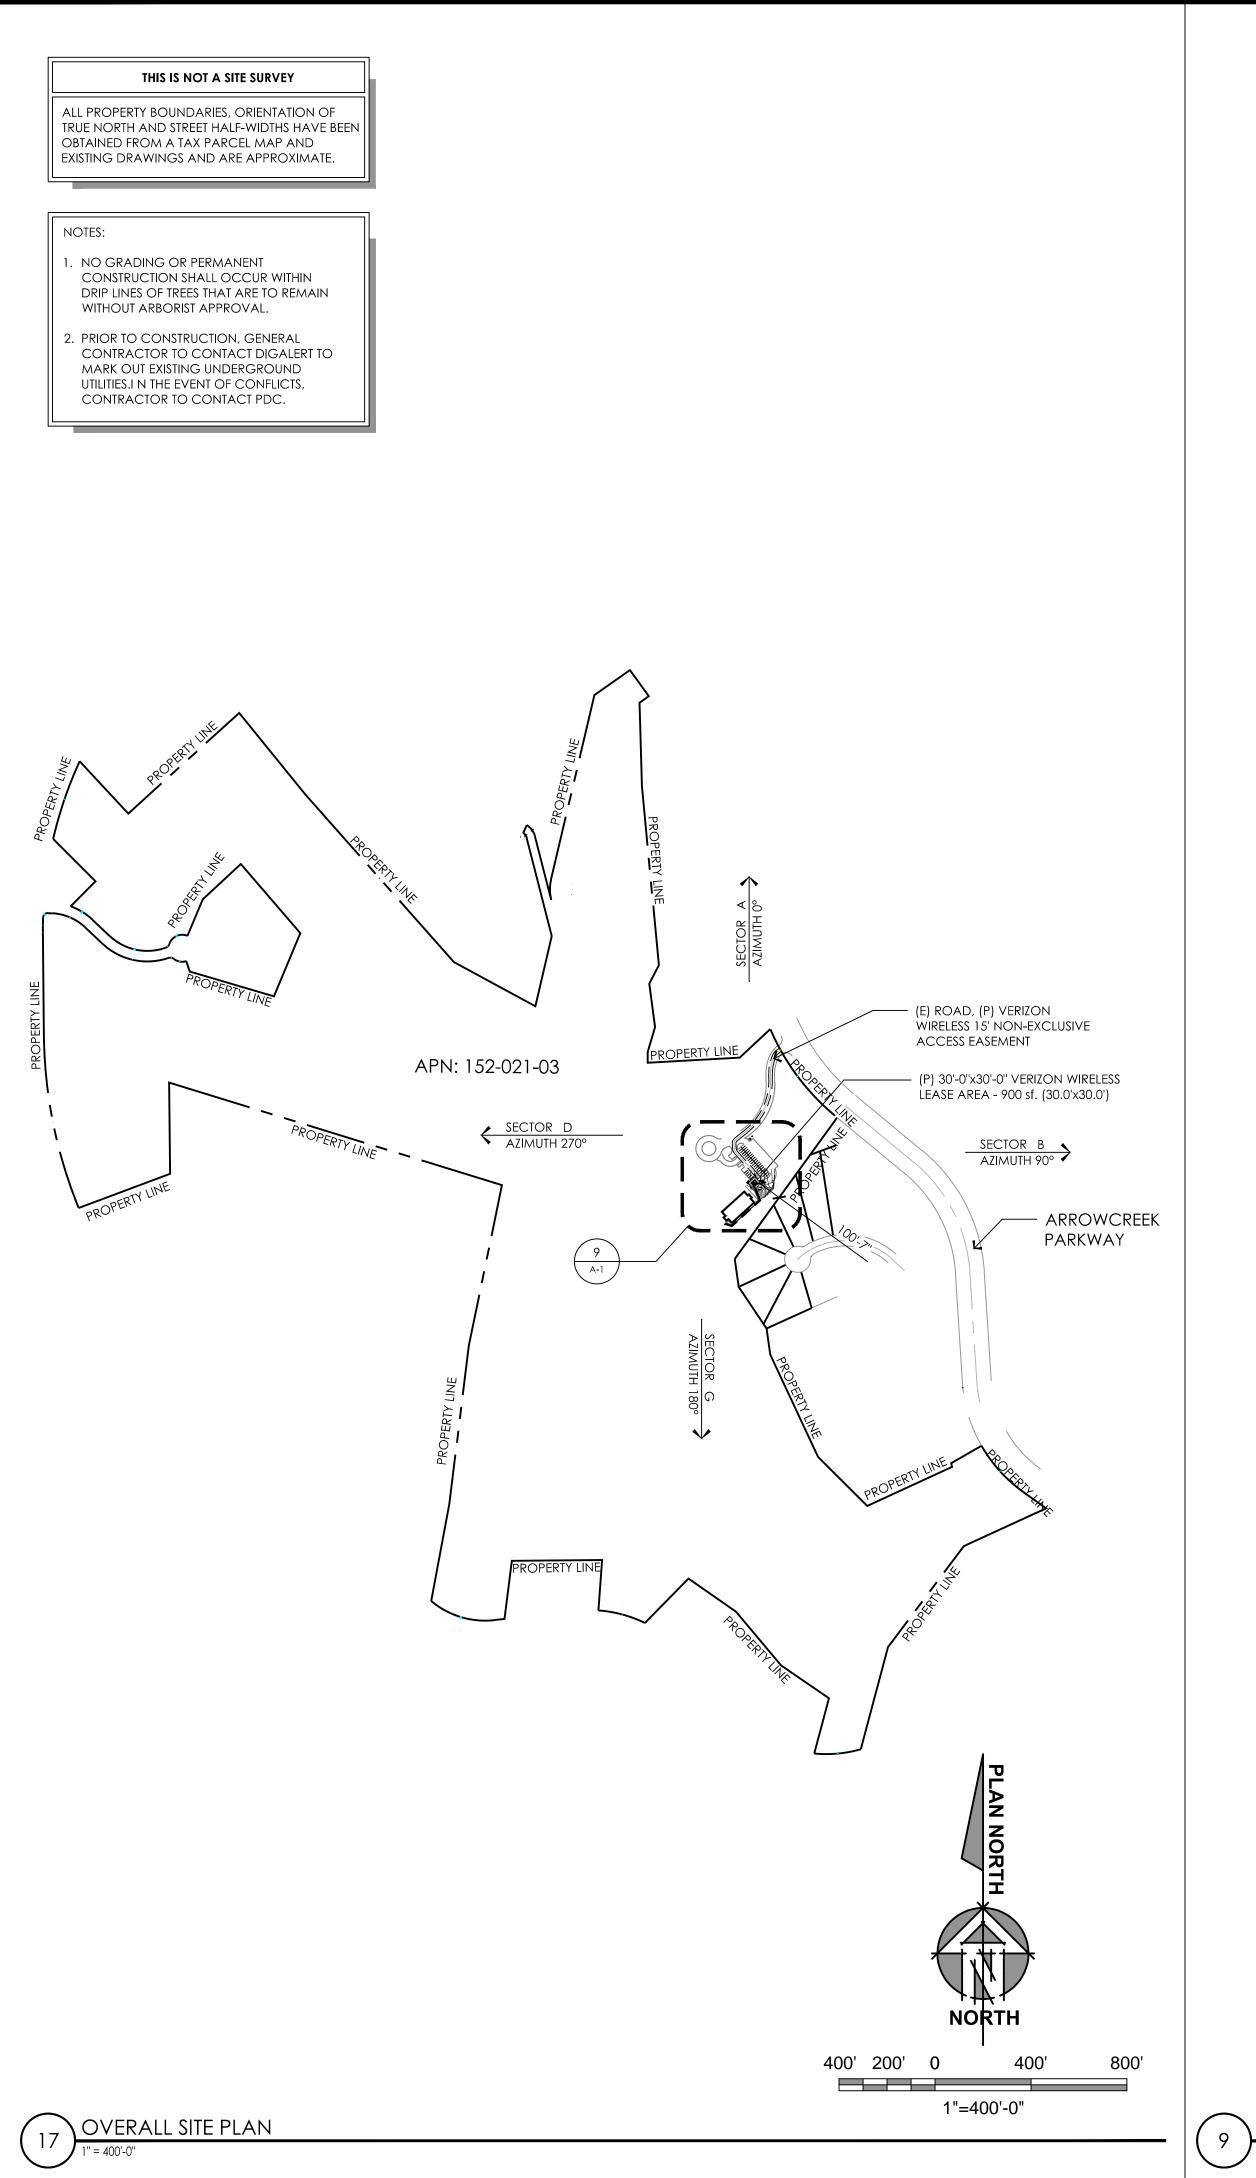
100% ZD Submittal


TITLE SHEET

SHEET NUMBER:

PROJECT INFORMATION PROJECT TEAM SHEET INDEX PROJECT DESCRIPTION **Property Information:** Property Owner: TITLE SHEET Construction Mgr.: Architect / Engineer: A-0 NEW SITE BUILD UNMANNED TELECOMMUNICATIONS FACILITY. THE CLUB AT ARROWCREEK Site Name: WEST ZOLEZZI EPIC WIRELESS GROUP, INC. BORGES ARCHITECTURAL GROUP, INC. 2905 ARROWCREEK PKWY ADD (P) 30'-0"X30'-0" CMU ENCLOSURE AROUND (P) VERIZON WIRELESS OUTDOOR 8700 AUBURN FOLSOM ROAD, SUITE 400 1478 STONE POINT DRIVE, SUITE 350 RENO, NV 89511 EQUIPMENT ON (P) 20'-0" x 10'-0" CONCRETE SLAB Site Number: 20141021630 GRANITE BAY, CA 95746 ROSEVILLE. CA 95661 C-1 OVERALL SITE PLAN & PROJECT AREA ENLA contact: BRETT EWING contact: BRIAN K. WINSLOW (P) 48kVA DIESEL GENERATOR W/ 210 GALLON TANK ON (P) 6'-0" x 10'-0" CONCRETE SLAB Search Ring: WEST ZOLEZZI email: brett.ewing@epicwireless.net email: brian@borgesarch.com ADD (P) H-FRAME W/ (P) METER, (P) INTERSECT W/ DISCONNECT & TELCO CABINET Power Agency: ADD (2) PANEL ANTENNAS AND (1) FUTURE PANEL ANTENNA PER SECTOR (4 SECTORS, ph: (916) 844-9324 ph: (916) 782-7200 **NV ENERGY** Site Address: 2905 ARROWCREEK PKWY 6226 West Sahara Avenue 7. ADD (2) RRUS12 WITH A2 MODULE BEHIND PER SECTOR AND (1) FUTURE RRH PER SECTOR, RENO, NV 89511 Structural Engineer: OVERALL & ENLARGED SITE PLANS Agent for Applicant, Planning and A-1 Las Vegas, NV 89146 (4 SECTORS, (12) RRUS TOTAL) NORM SCHEEL STRUCTURAL ENGINEER Zoning Mgr: 8. ADD (4) SURGE SUPPRESSORS, (2) MOUNTED AT (P) MONOPINE, (2) MOUNTED ph: 1-775-473-6998 A.P.N. Number: 152-021-03 A-2 ENLARGED EQUIPMENT & ANTENNA PLANS 5022 SUNRISE BLVD ON (P) H-FRAME EPIC WIRELESS GROUP, INC. FAIR OAKS, CA 95628 9. ADD (2) HYBRID FIBER CABLE 8700 AUBURN FOLSOM ROAD, SUITE 400 Current Use: RR 10. ADD (P) ICE BRIDGE contact: NORM SCHEEL GRANITE BAY, CA 95746 A - 3.1**ELEVATIONS** Telephone Agency: 11. ADD (1) GPS ANTENNA email: norm@nsse.com contact: BUZZ LYNN Jurisdiction: WASHOE COUNTY ph: (916) 536-9585 email: buzz.lynn@epicwireless.net A-3.2**ELEVATIONS** cell: (775) 852-5367 GENERATOR SPECS A-4 Geil Engineering 1226 High Street contact: NEIL ROHDE email: nrohde@pacbell.net ph: (530) 885-0426 RF Engineer: VERIZON WIRELESS 255 PARKSHORE DRIVE VICINITY MAP CODE COMPLIANCE FOLSOM, CA 95630 contact: ERICSON MALANA email: ericson.malana@verizonwireless.com ALL WORK AND MATERIALS SHALL BE PERFORMED AND INSTALLED IN ACCORDANCE WITH ph: (925) 788-1863 THE CURRENT EDITIONS OF THE FOLLOWING CODES AS ADOPTED BY THE LOCAL GOVERNING B 01/20/16 100% ZD Submittal AUTHORITIES. NOTHING IN THESE PLANS IS TO BE CONSTRUED TO PERMIT WORK NOT A | 10/01/15 | 90% ZD Submittal CONFORMING TO THESE CODES. DIRECTIONS FROM VERIZON WIRELESS REV DATE 1) 2012 INTERNATIONAL BUILDING CODE WITH AMENDMENTS DIRECTIONS FROM VERIZON WIRELESS'S OFFICE AT 255 PARKSHORE DRIVE, FOLSOM, CA 2) 2011 NATIONAL ELECTRICAL CODE 1. Head northeast on Parkshore Dr toward Coolidge Dr VERIZON SIGNATURE BLOCK 3) 2012 INTERNATIONAL ENERGY CONSERVATION CODE 2. Turn left onto Coolidge Dr 4) 2012 UNIFORM MECHANICAL CODE 3. Turn left onto Glenn Dr 4. Use the right 2 lanes to turn right onto Folsom Blvd DISCIPLINE: SIGNATURE: DATE: 5) 2012 UNIFORM PLUMBING CODE 5. Continue straight to stay on Folsom Blvd 6) 2012 INTERNATIONAL FIRE CODE SITE ACQUISITION: 6. Continue onto Folsom-Auburn Rd 7) LOCAL BUILDING CODE 7. Turn left onto Cavitt Stallman Rd CONSTRUCTION: 8. Turn right at the 1st cross street onto Laird Rd 8) CITY / COUNTY ORDINANCES 9. Turn right onto Horseshoe Bar Rd ANY APPLICABLE LOCAL AND STATE LAWS AND REGULATIONS RF: 10. Turn left to stay on Horseshoe Bar Rd 11. Turn right to merge onto I-80 E MICROWAVE: 12. Merge onto I-80 E 13. Keep left to stay on I-80 E TELCO: 14. Use the right 3 lanes to take exit 15 to merge onto I-580 S/US-395 S toward Carson City 15. Take exit 59 for Damonte Ranch Pkwy **EQUIPMENT:** 16. Use the right 2 lanes to turn right onto Damonte Ranch Pkwy PROJECT ADMINISTRATOR: 17. Continue onto Arrowcreek Pkwy Destination will be on the left WO ADMINISTRATOR: SPECIAL INSPECTIONS



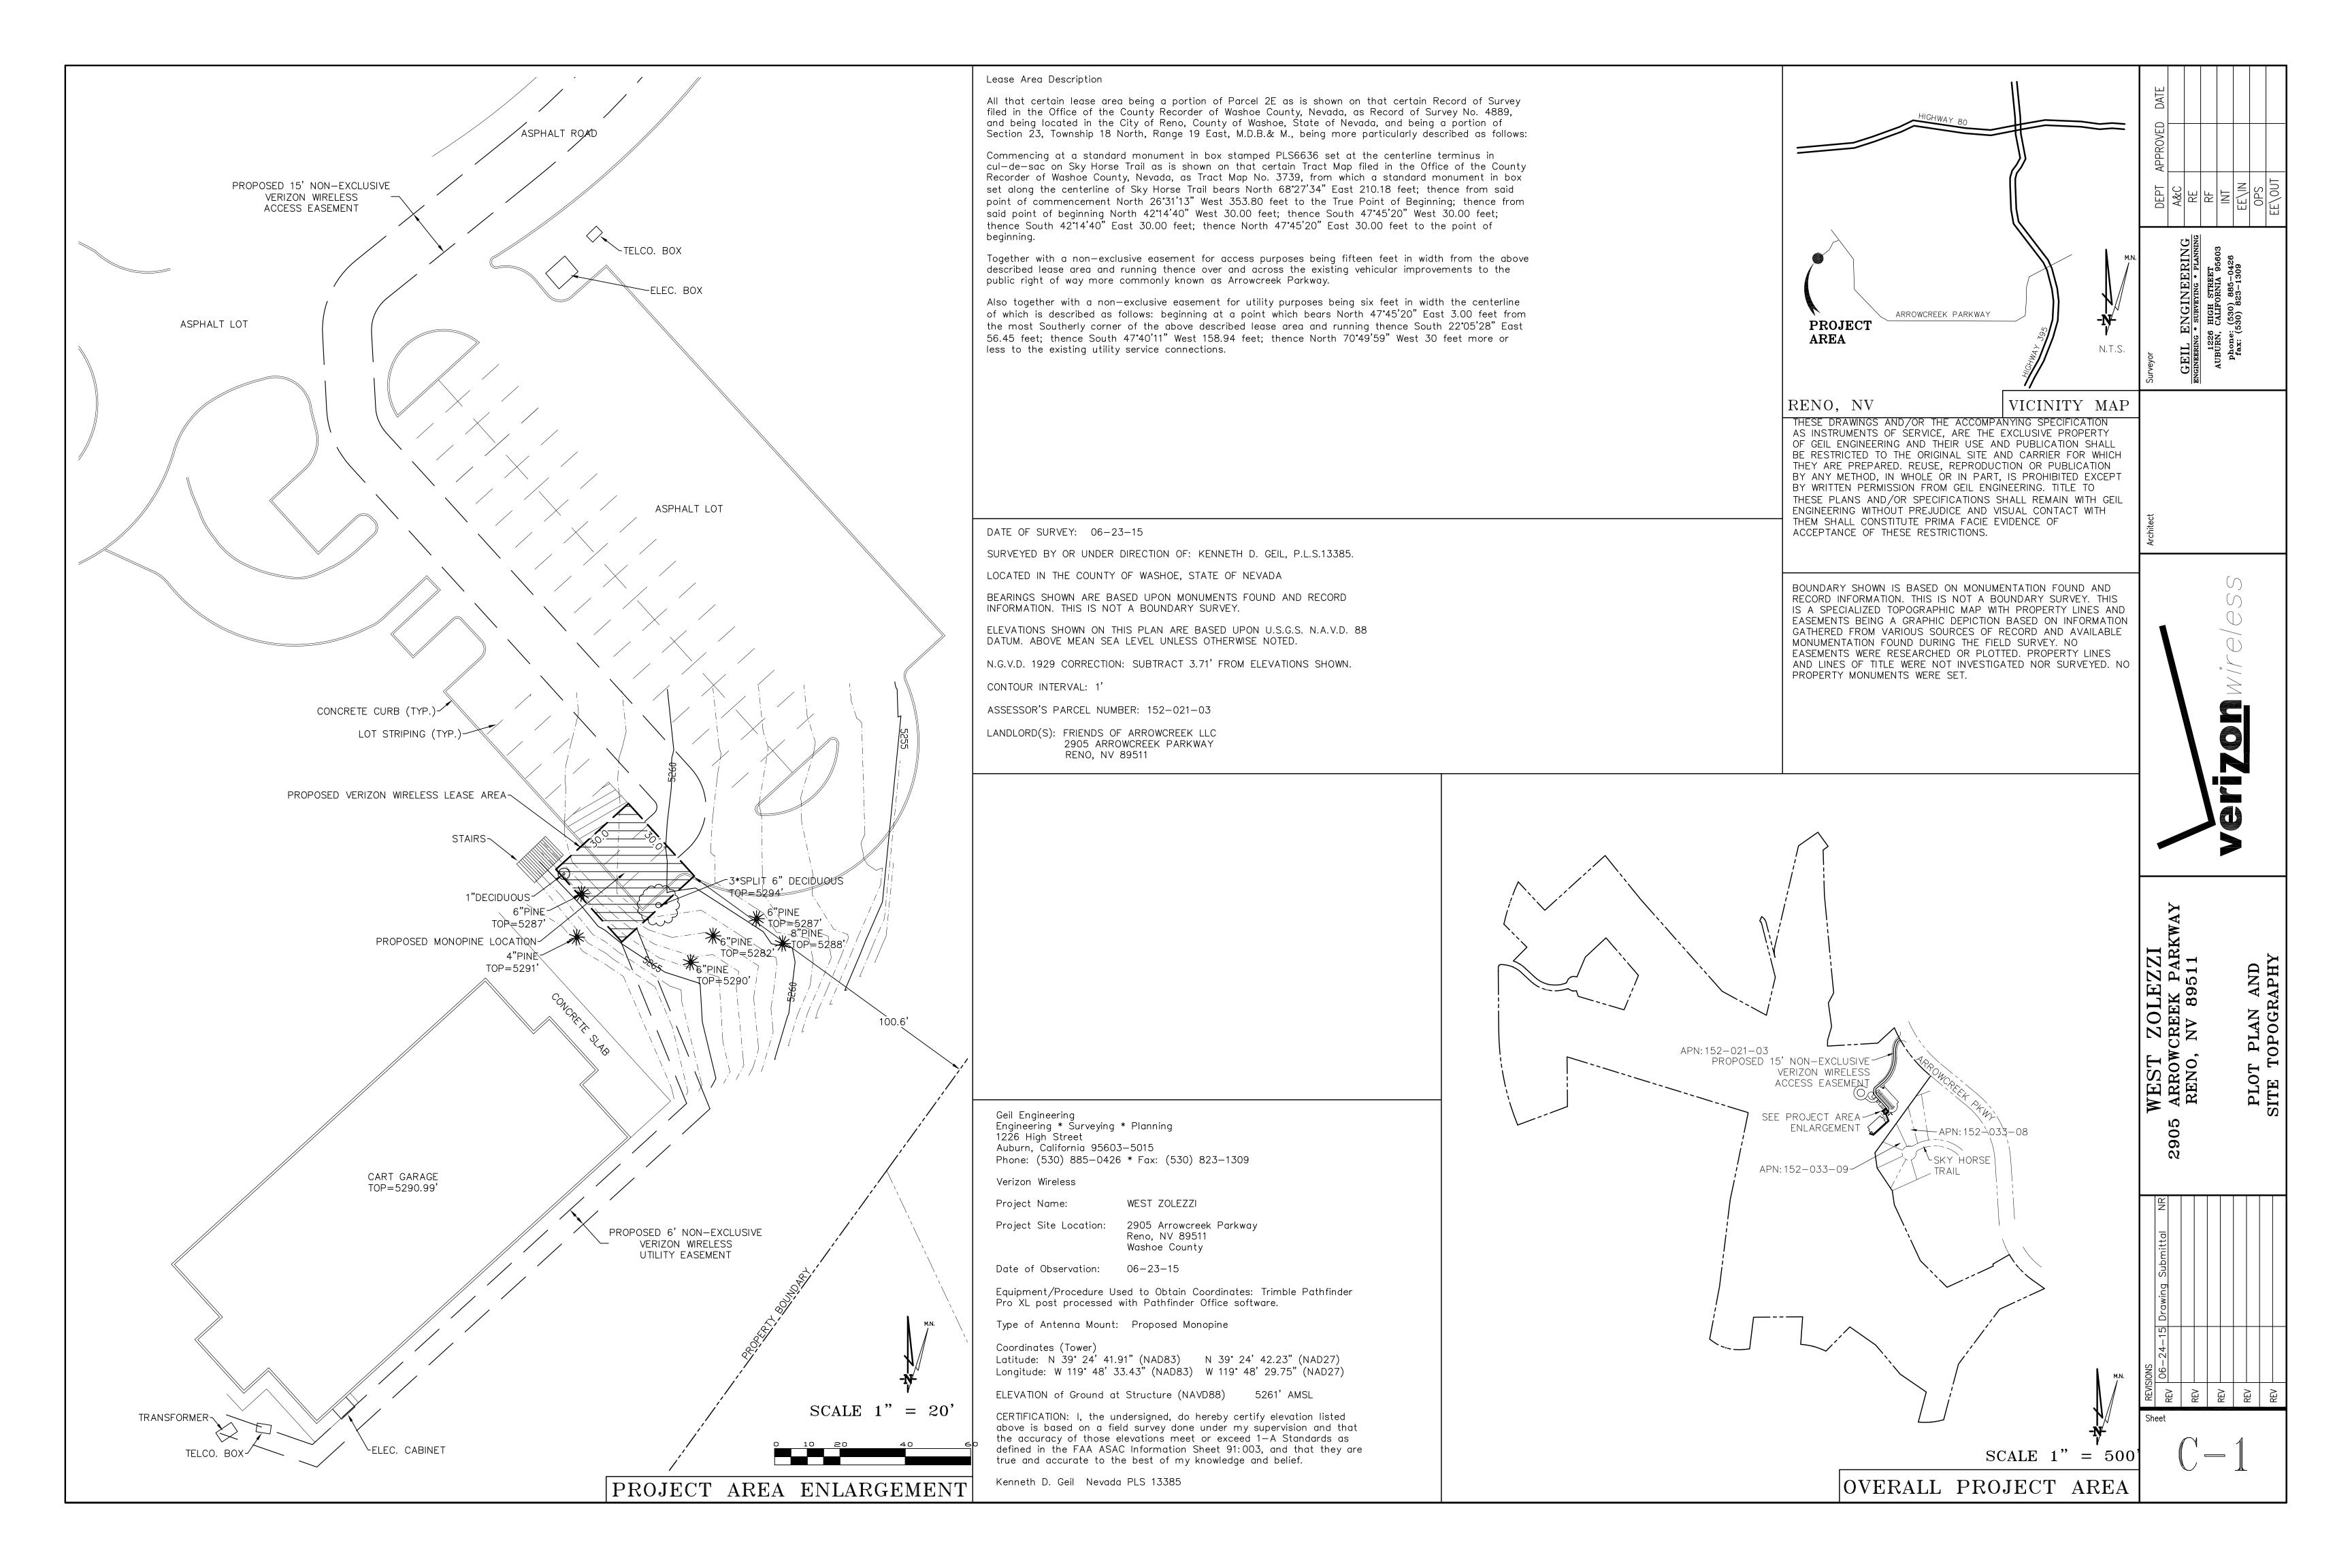

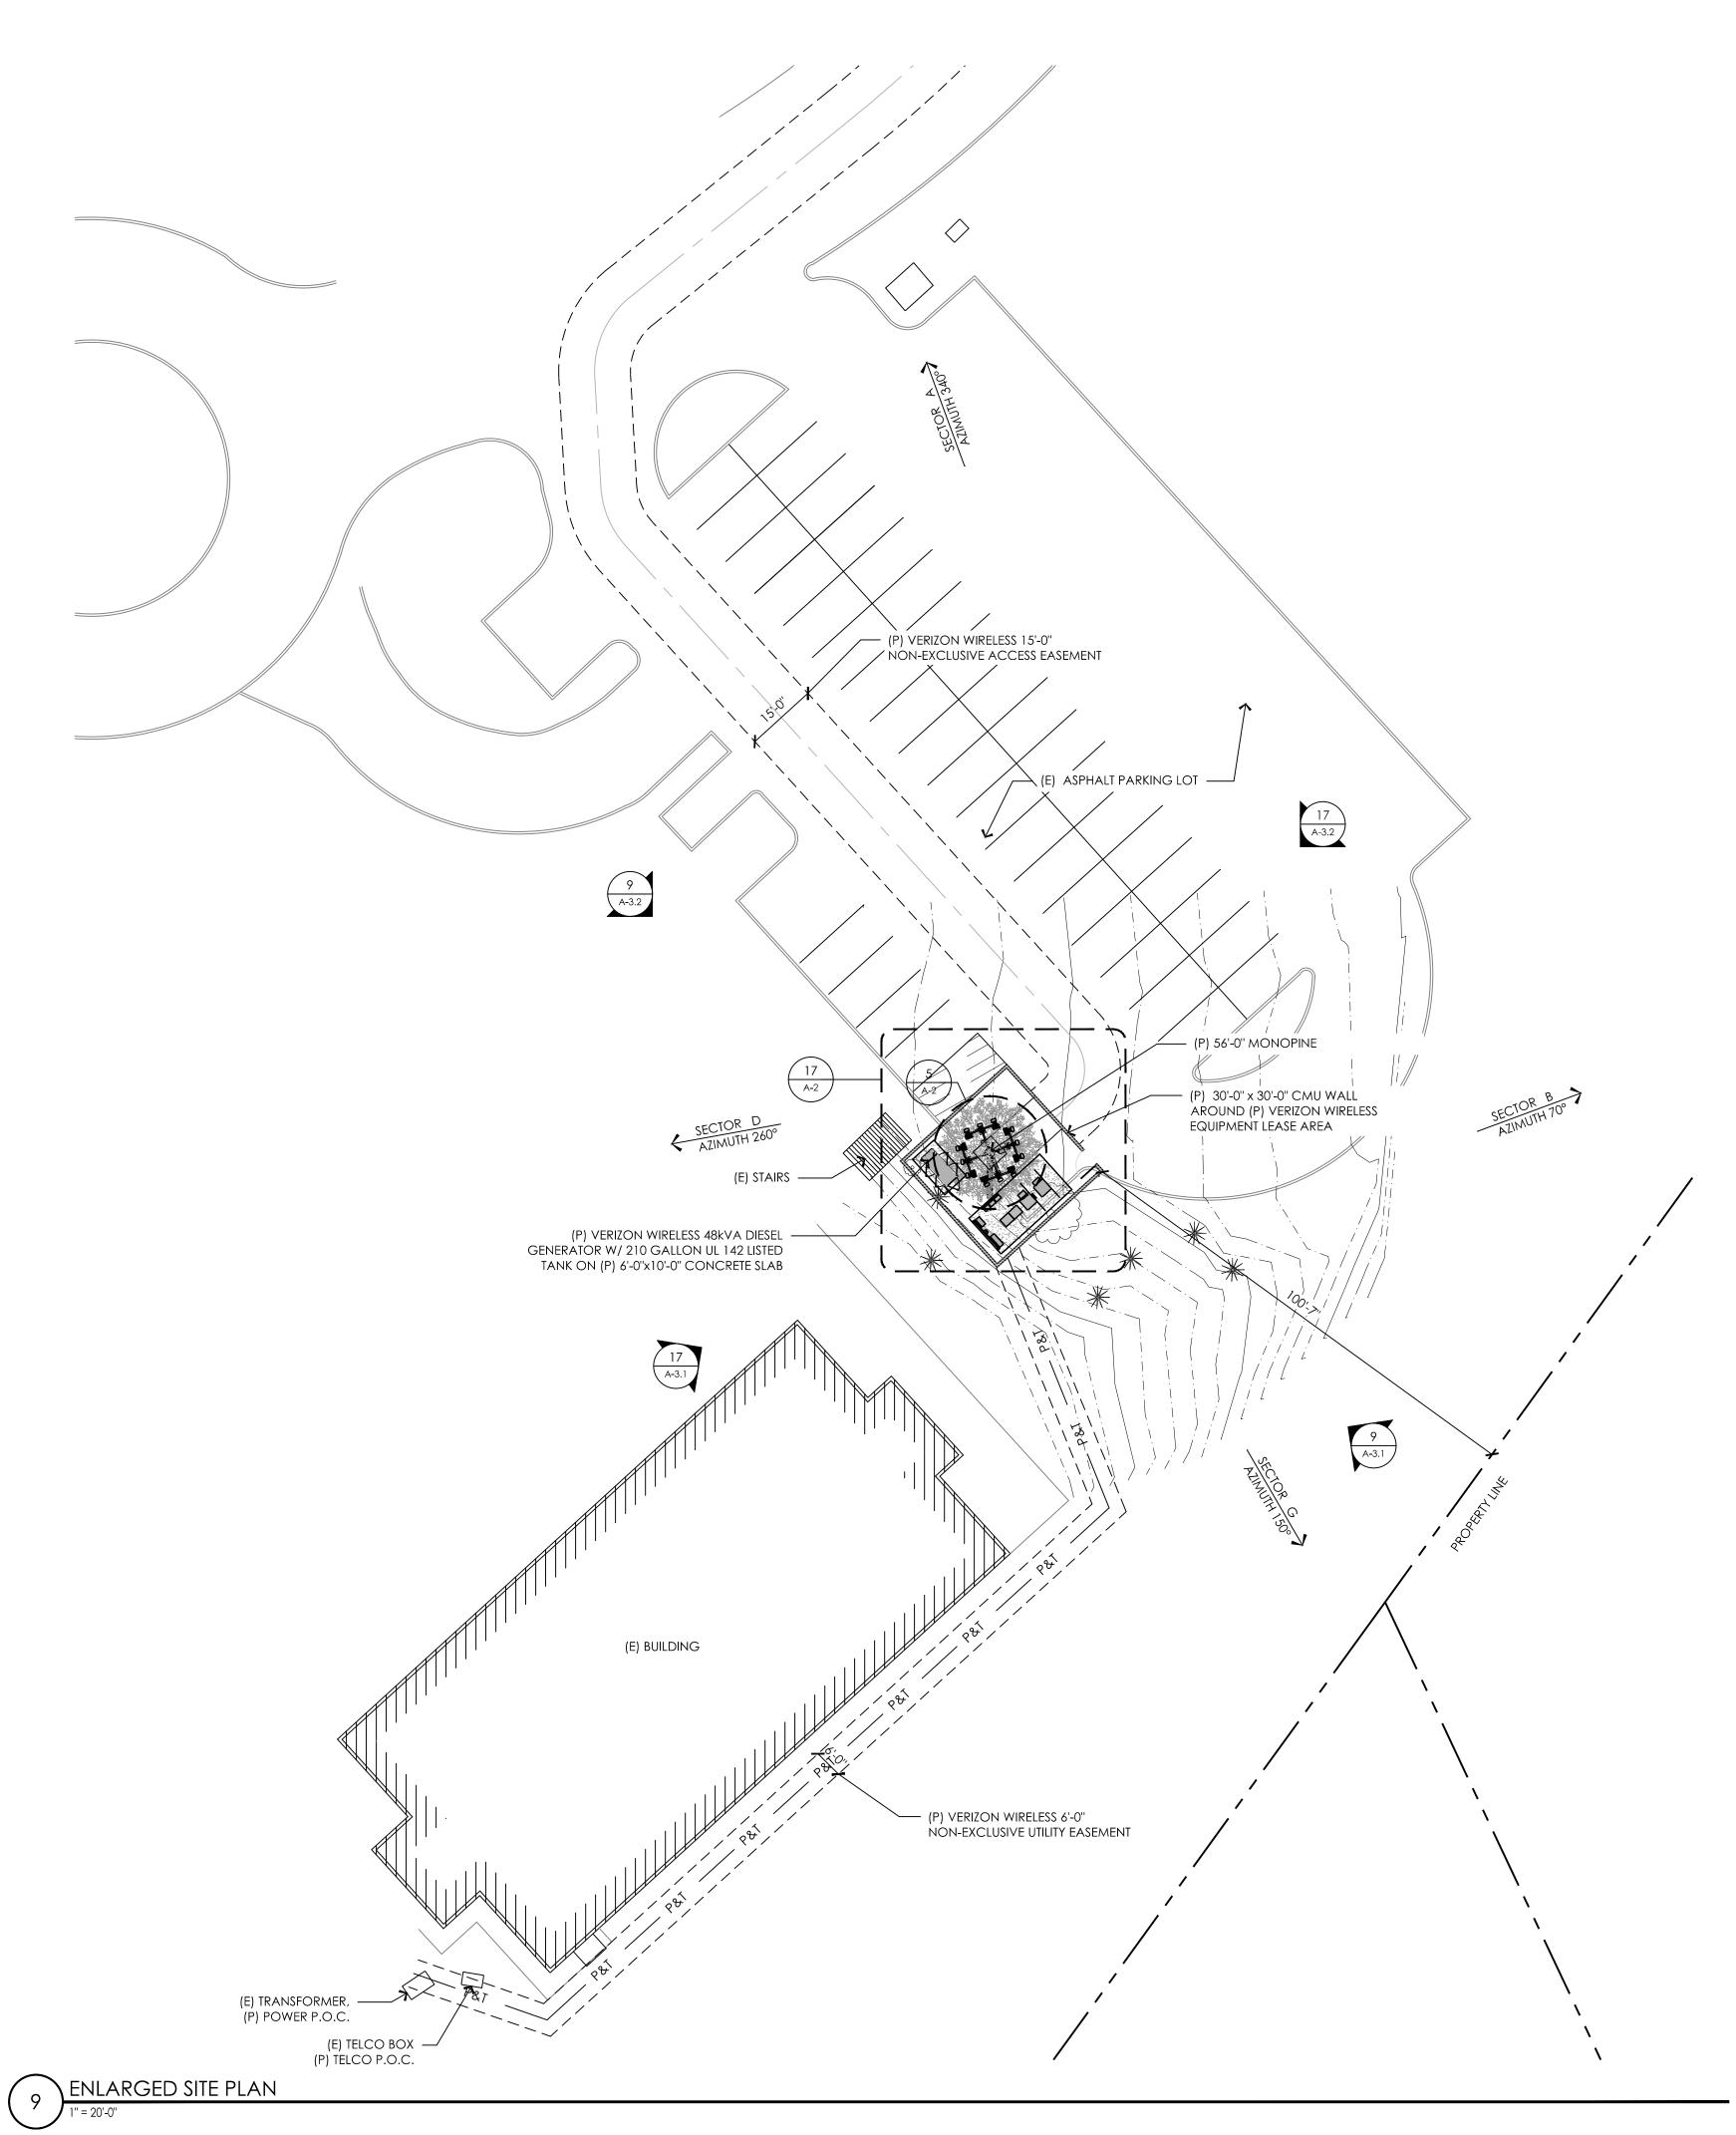



295 Parkshore Drive Folsom, California 94630



Project Address:

Granite Bay, California 95746

2905 Arrowcreek Pkwy Reno, NV 89511

Architect:

ARCHITECTURE
PLANNING
INTERIORS

BARCHITECTURAL GROUP
BOTGES

1478 STONE POINT DRIVE
SUITE 350
ROSEVILLE CA 95661
T1916 773 3037
BORGESARCH.COM

PROJECT NO: 20141021630

LOCATION NO: 288151

DRAWN BY: B.K.W.

CHECKED BY: B.K.W.

B 01/20/16 100% ZD Submittal
A 10/01/15 90% ZD Submittal
REV DATE DESCRIPTION

Licensor:

IT IS A VIOLATION OF LAW FOR ANY PERSON, UNLESS THEY ARE ACTING UNDER THE DIRECTION OF A LICENSED PROFESSIONAL ENGINEER, TO ALTER THIS DOCUMENT.

Issued For:

01/20/16


100% ZD Submittal

CLIEET TITLE.

OVERALL & ENLARGED SITE PLANS

SHEET NUMBER:

A-1

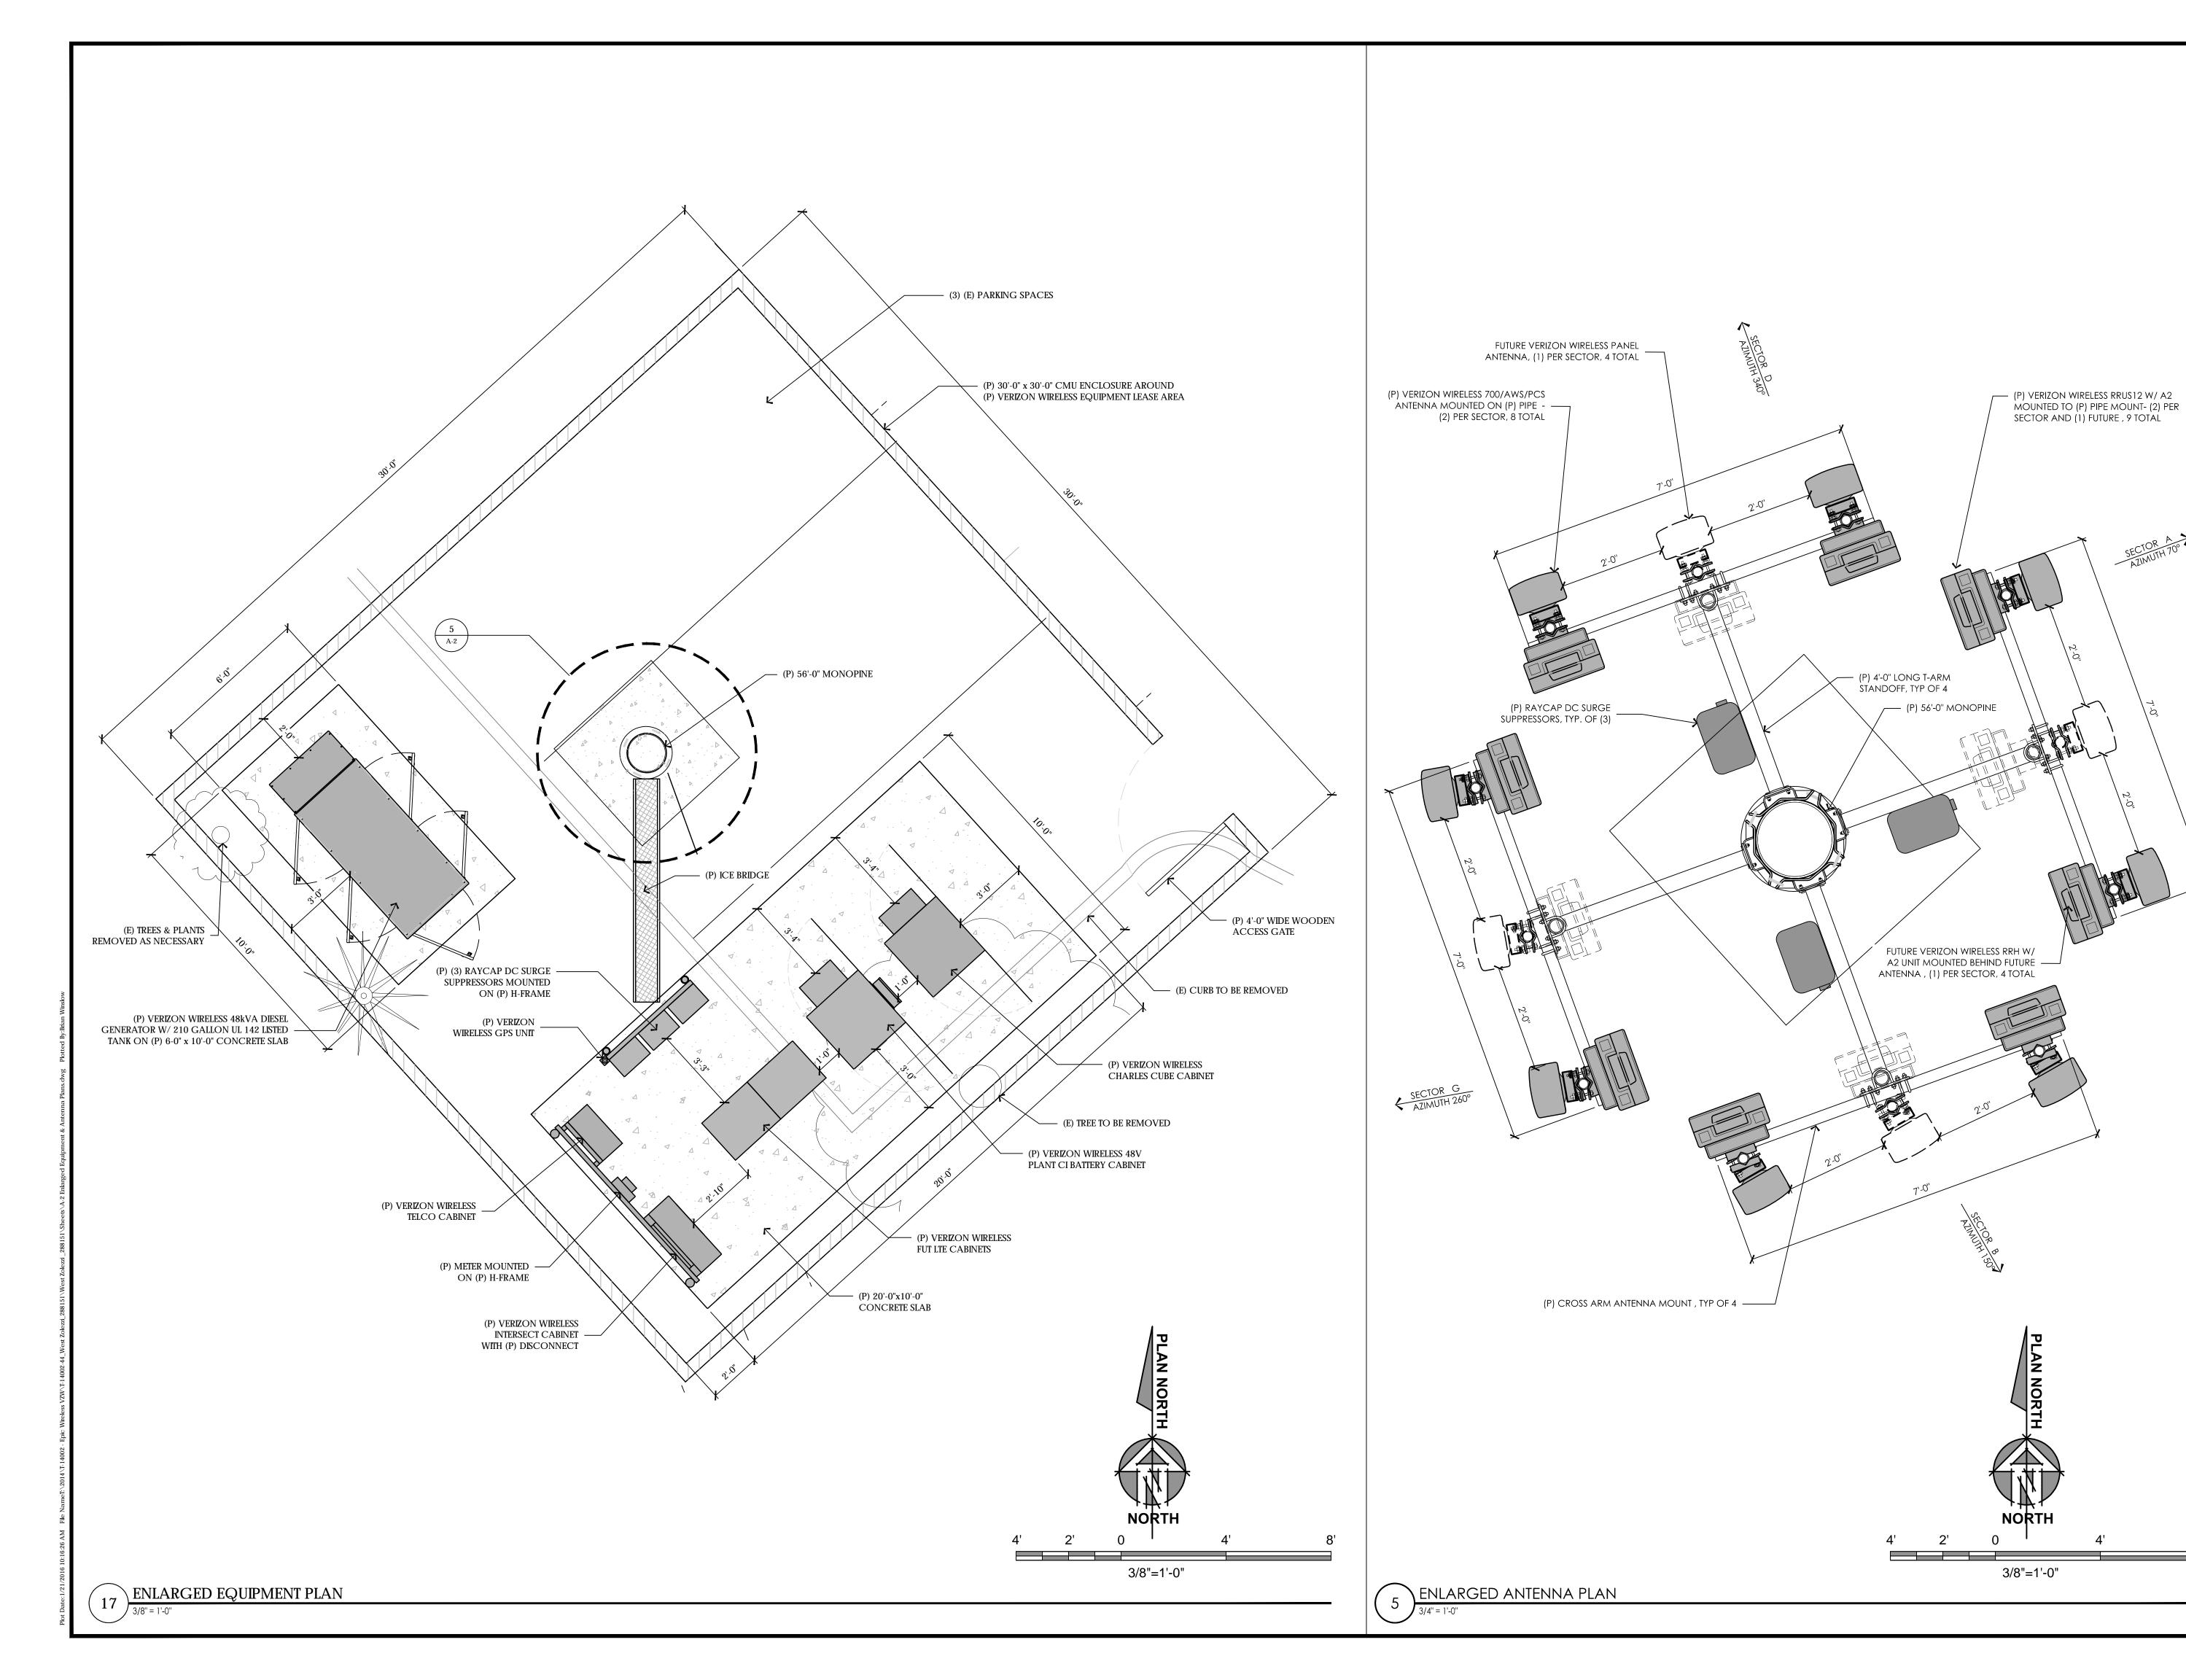





Project Address:

2905 Arrowcreek Pkwy Reno, NV 89511



PROJECT NO: 20141021630

LOCATION NO: 288151

DRAWN BY: B.K.W.

CHECKED BY: B.K.W.

В	01/20/16	100% ZD Submittal
A	10/01/15	90% ZD Submittal
REV	DATE	DESCRIPTION

Licensor:

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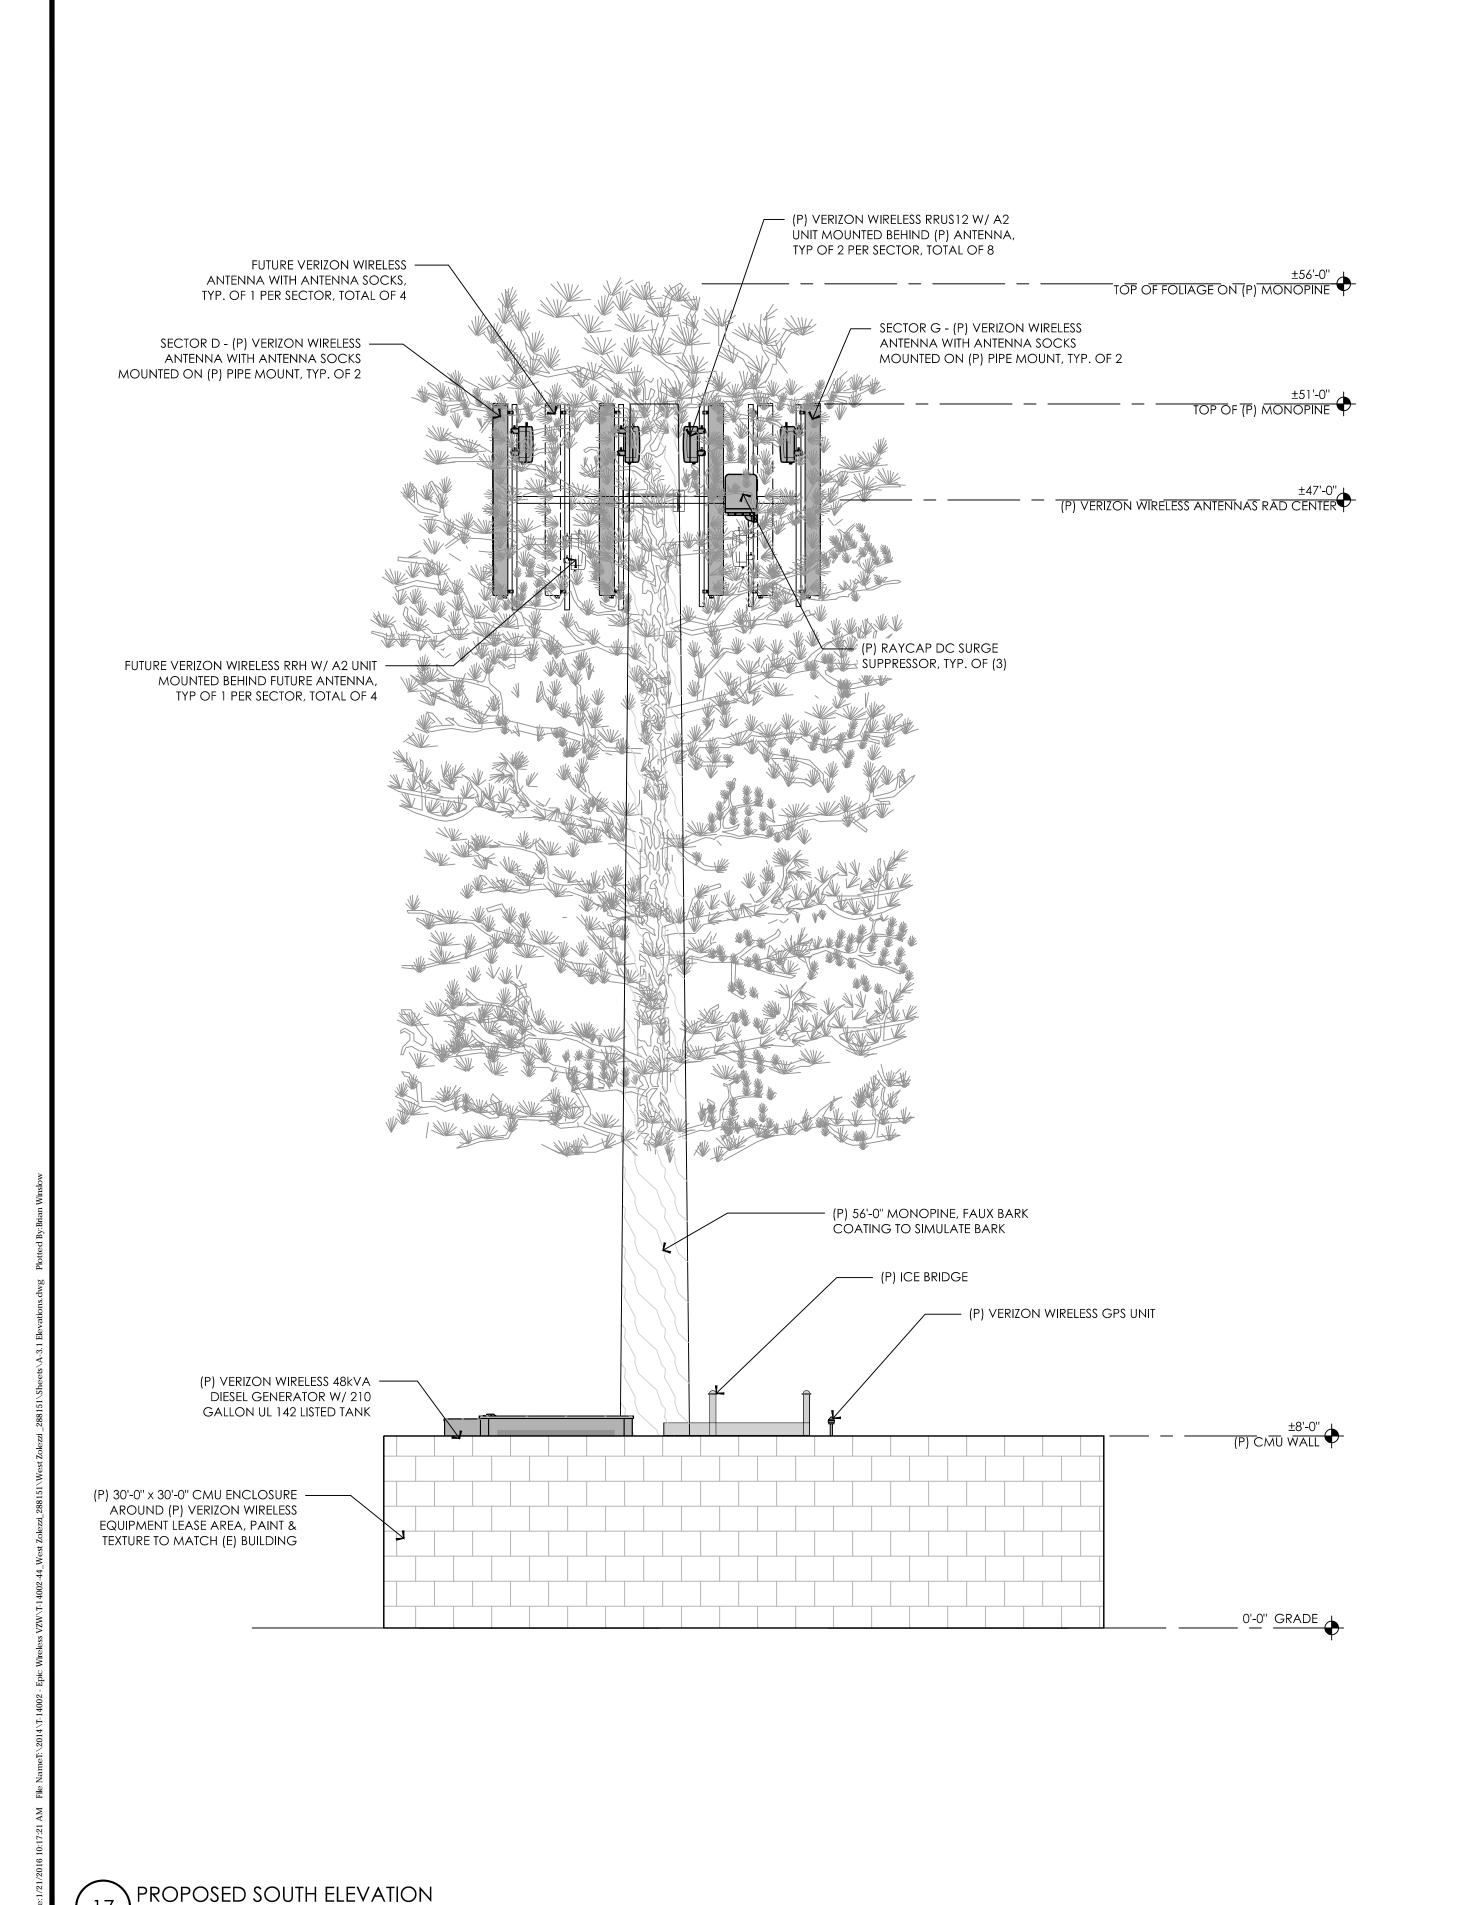
Issued For:


01/20/16 100% ZD Submittal


SHEET TITLE:
ENLARGED EQUIPMENT &
ANTENNA PLANS

SHEET NUMBER

A-2



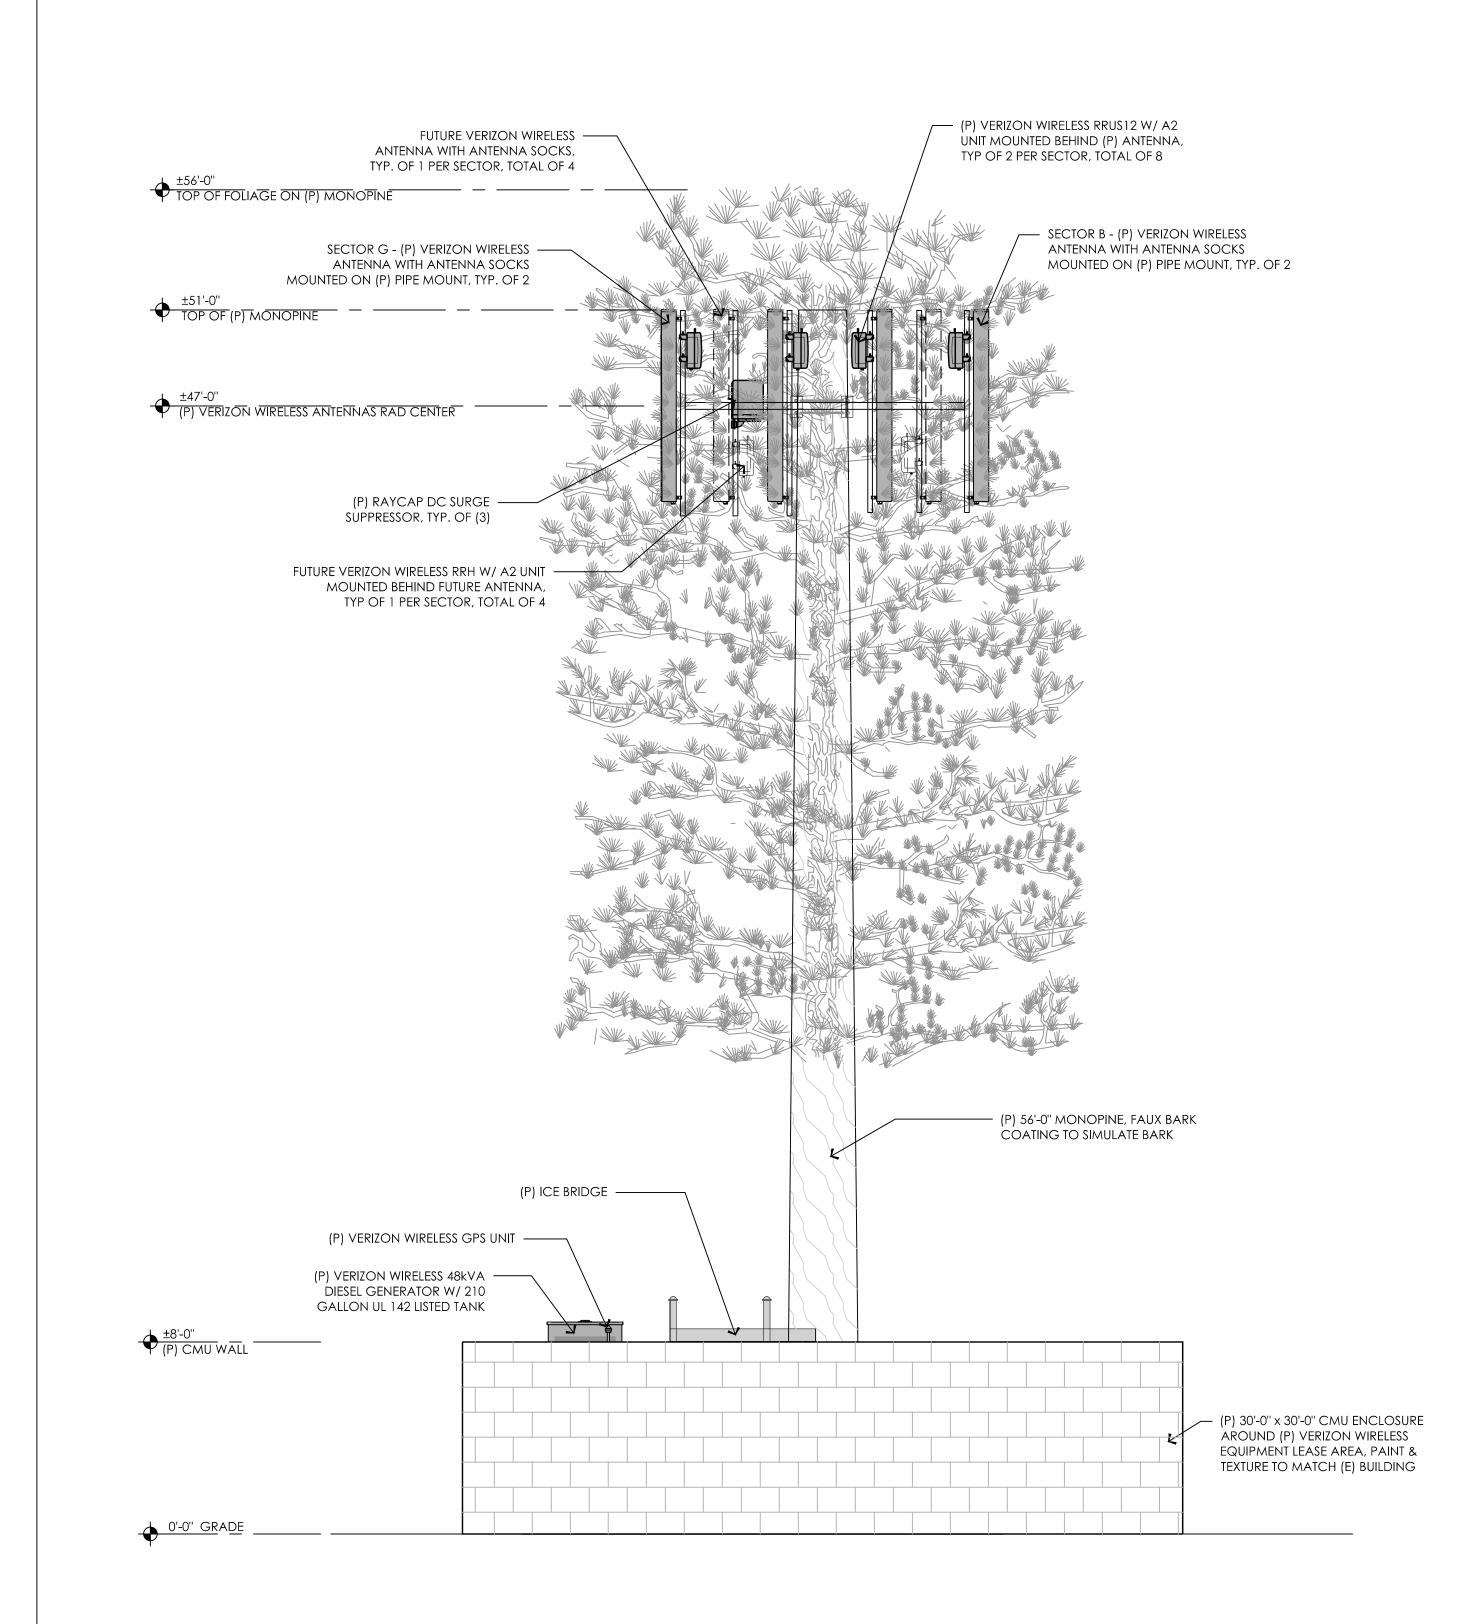

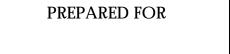

verizon

295 Parkshore Drive Folsom, California 94630



Project Address:

Granite Bay, California 95746

2905 Arrowcreek Pkwy Reno, NV 89511

architecture Barchitectural group planning INTERIORS

PROJECT NO: 20141021630 LOCATION NO: 288151

B.K.W. DRAWN BY:

CHECKED BY: B.K.W.

B 01/20/16 100% ZD Submittal A 10/01/15 90% ZD Submittal

DESCRIPTION

DATE

Licensor:

IT IS A VIOLATION OF LAW FOR ANY PERSON, UNLESS THEY ARE ACTING UNDER THE DIRECTION OF A LICENSED PROFESSIONAL ENGINEER, TO ALTER THIS


DOCUMENT.


Issued For:

01/20/16

100% ZD Submittal

ELEVATIONS

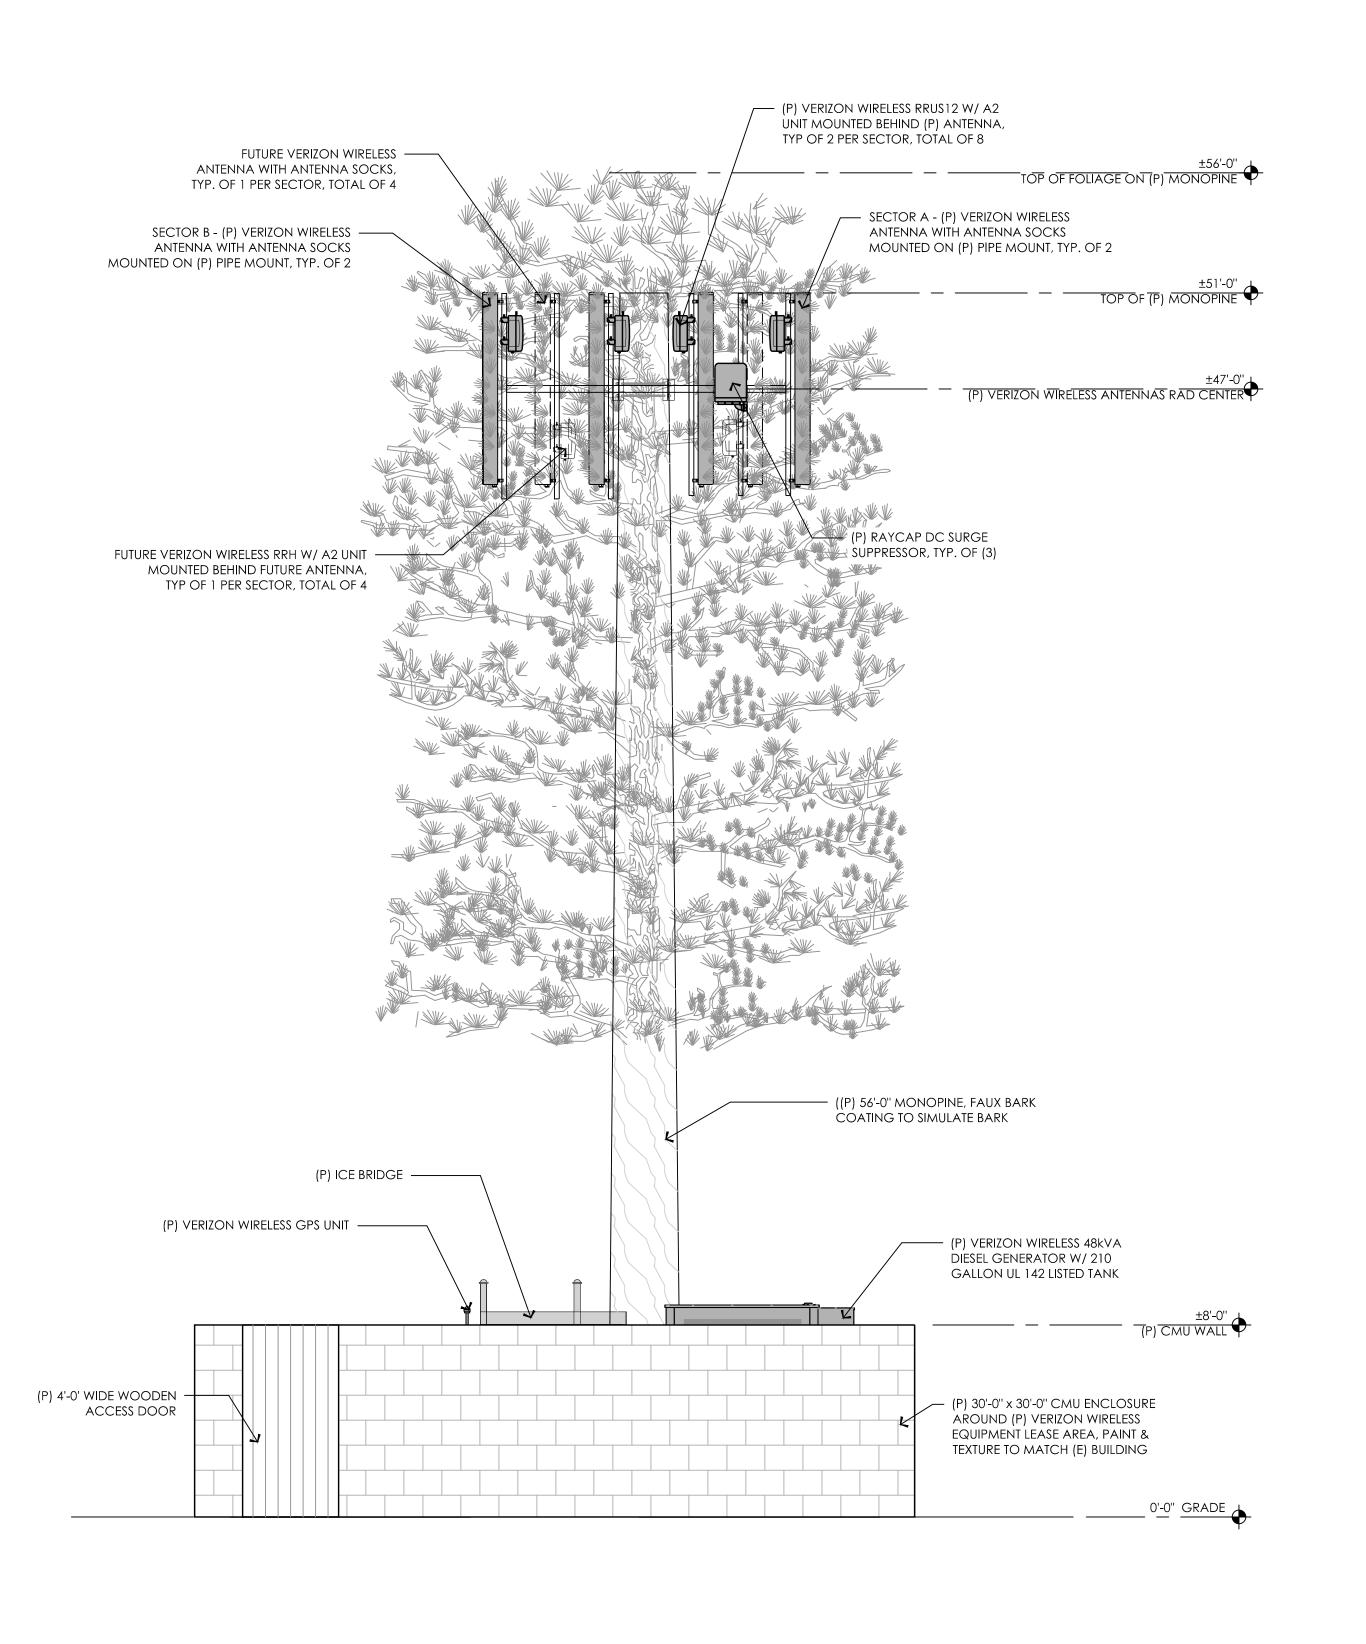

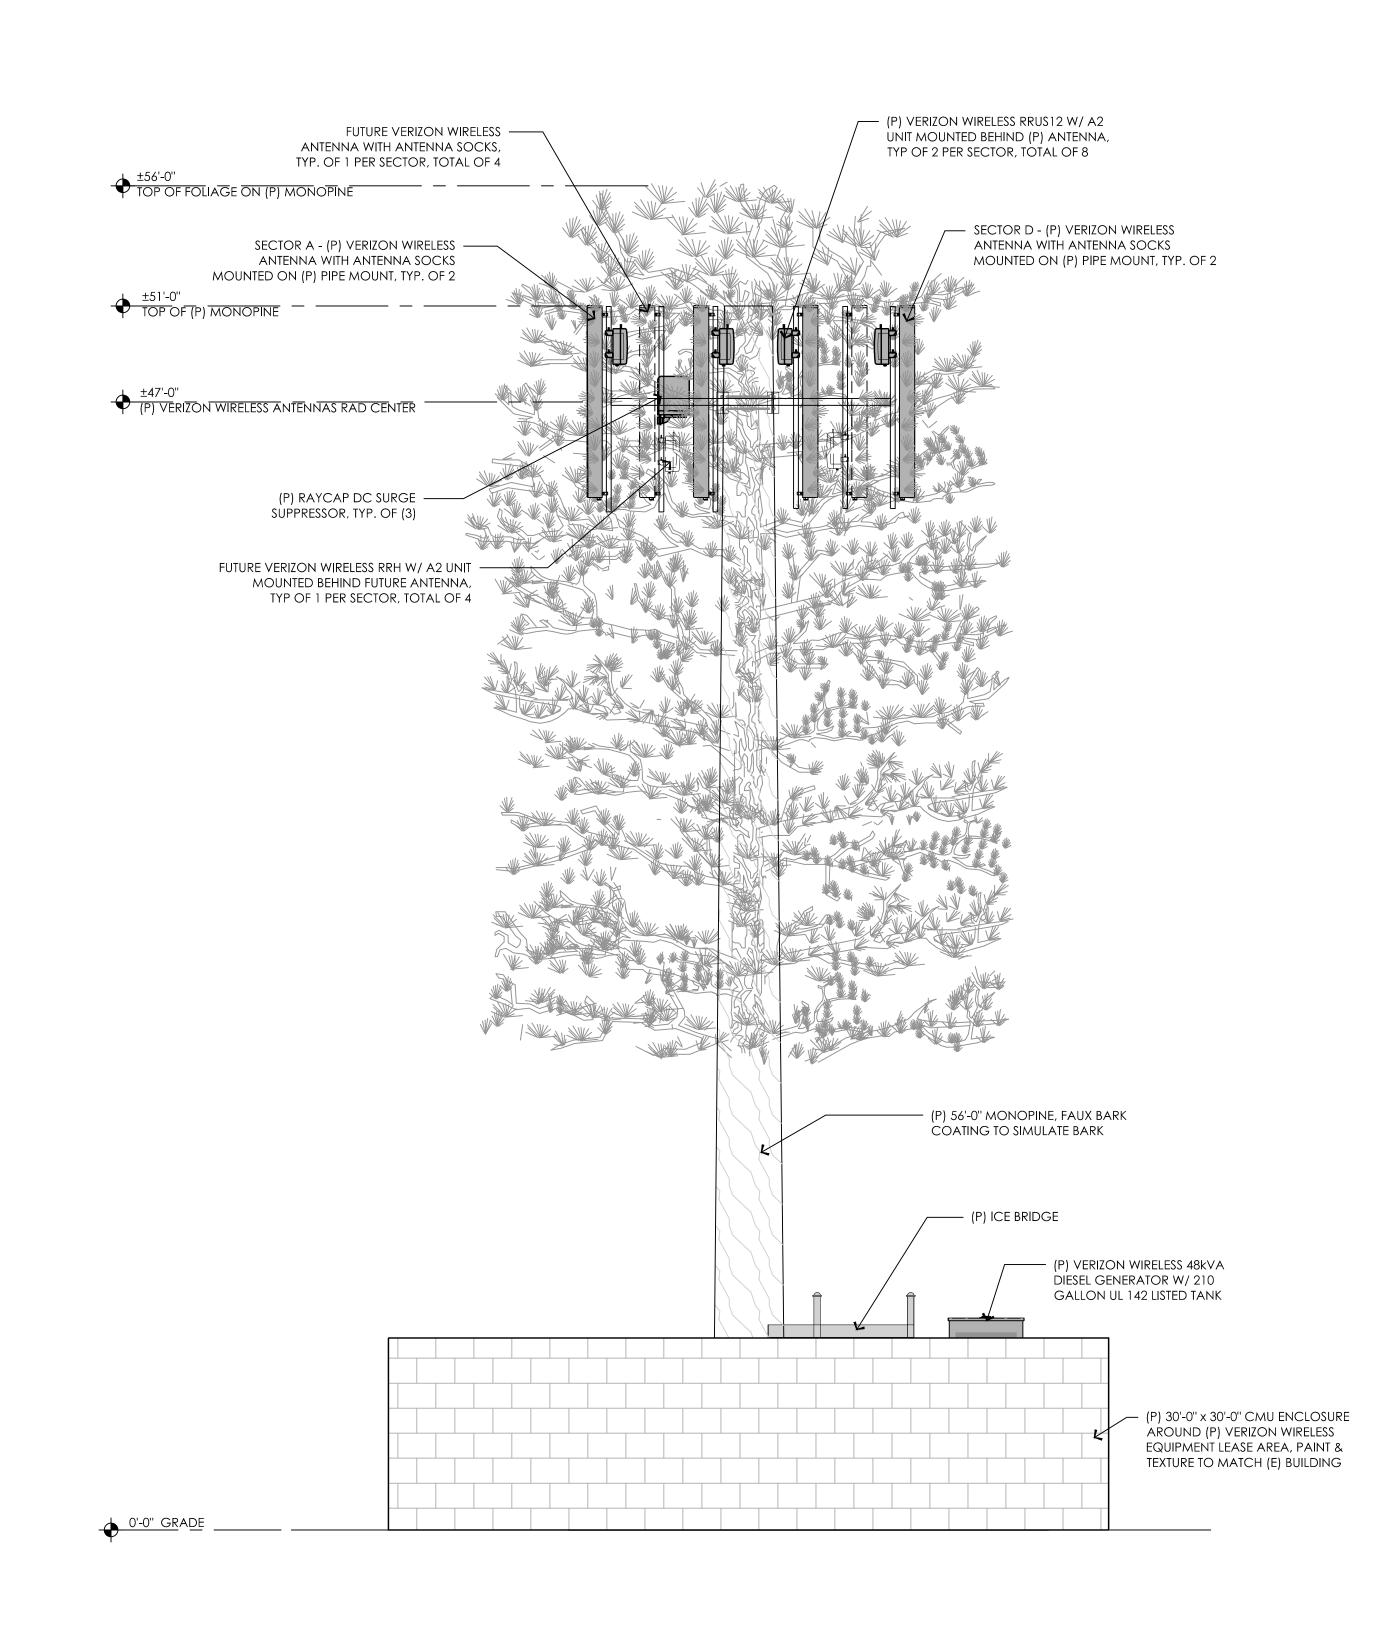

PREPARED FOR

Verizon

295 Parkshore Drive



Project Address:

2905 Arrowcreek Pkwy Reno, NV 89511

Architect:

ARCHITECTURE
PLANNING
INTERIORS

BARCHITECTURAL GROUP

BOTSES

1478 STONE POINT DRIVE
SUITE 350
ROSEVILLE CA 95661
T1916 782 7200
F1916 773 3037
BORGESARCH.COM

PROJECT NO: 20141021630

LOCATION NO: 288151

DRAWN BY: B.K.W.

CHECKED BY: B.K.W.

B 01/20/16 100% ZD Submittal
A 10/01/15 90% ZD Submittal
REV DATE DESCRIPTION

Licensor:

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ELEVATIONS

A-3.2

PROPOSED WEST ELEVATION

1/4" = 1'-0"



Rated RPM:



STATEMENT OF EXHAUST EMISSIONS **2013 DIESEL FUELED GENERATOR**

The measured emissions values provided here are proprietary to Generac and it's authorized dealers. This information may only be disseminated upon request, to regulatory governmental bodies for emissions permitting purposes or to specifying organizations as submittal data when expressly required by project specifications, and shall remain confidential and not open to public viewing. This information is not intended for compilation or sales purposes and may not be used as such, nor may it be reproduced without the expressed written permission of Generac Power Systems, Inc. The data provided shall not be meant to include information made public by Generac.

Generator Model: EPA Certificate Number: DKMCL3.41D43-001 kW_e Rating: **CARB Certificate Number:** Not Applicable 536263 Engine Family: DKMCL3.41D43 SCAQMD CEP Number: D3400T-Gen1 Engine Model: Emission Standard Category: Rated Engine Power (BHP)*: Certification Type: Stationary Emergency Cl (40 CFR Part 60 Subpart IIII) Fuel Consumption (gal/hr)*: Turbo/Aftercooled Aspiration:

*Engine Power and Fuel Consumption are declared by the Engine Manufacturer of Record and the U.S. EPA.

Emissions based on engine power of specific Engine Model. (These values are actual composite weighted exhaust emissions results over the EPA 5-mode test cycle.)				
	СО	NOx + NMHC	PM	
	3.51	4.27	0.15	Grams/kW-hr
	2.64	3.19	0.11	Grams/bhp-hr


•The stated values are actual exhaust emission test measurements obtained from an engine representative of the type described above.


•Values based on 5-mode testing are official data of record as submitted to regulatory agencies for certification purposes. Testing was conducted in accordance with prevailing EPA protocol, which is typically accepted by SCAQMD and other regional authorities.

•No emissions values provided above are to be construed as guarantees of emission levels for any given Generac generator unit. •Generac Power Systems, Inc. reserves the right to revise this information without prior notice.

•Consult state and local regulatory agencies for specific permitting requirements. •The emission performance data supplied by the equipment manufacturer is only one element required toward completion of the permitting and installation process. State and local regulations may vary on a case-by-case basis and local agencies must be consulted by the permit application/equipment owner prior to equipment purchase or installation. The data supplied herein by Generac Power Systems cannot be construed as a guarantee of installability of the generating set.

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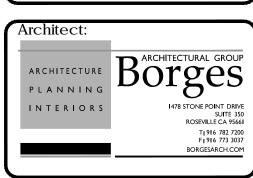


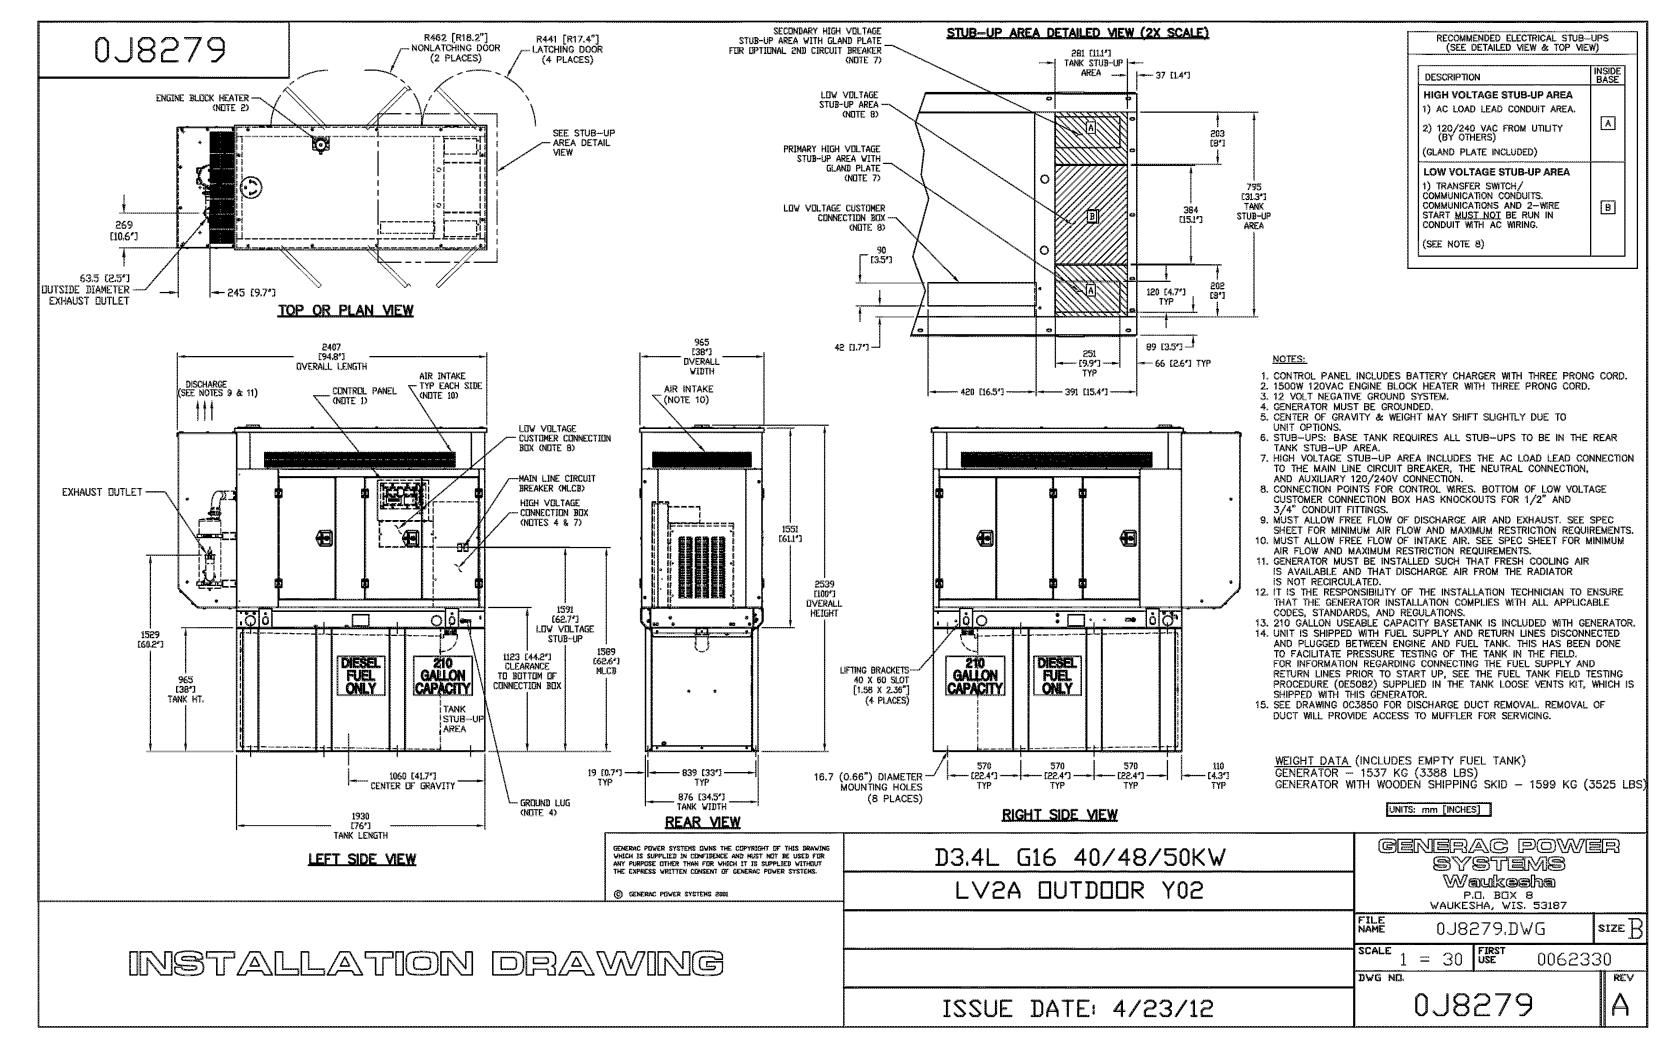

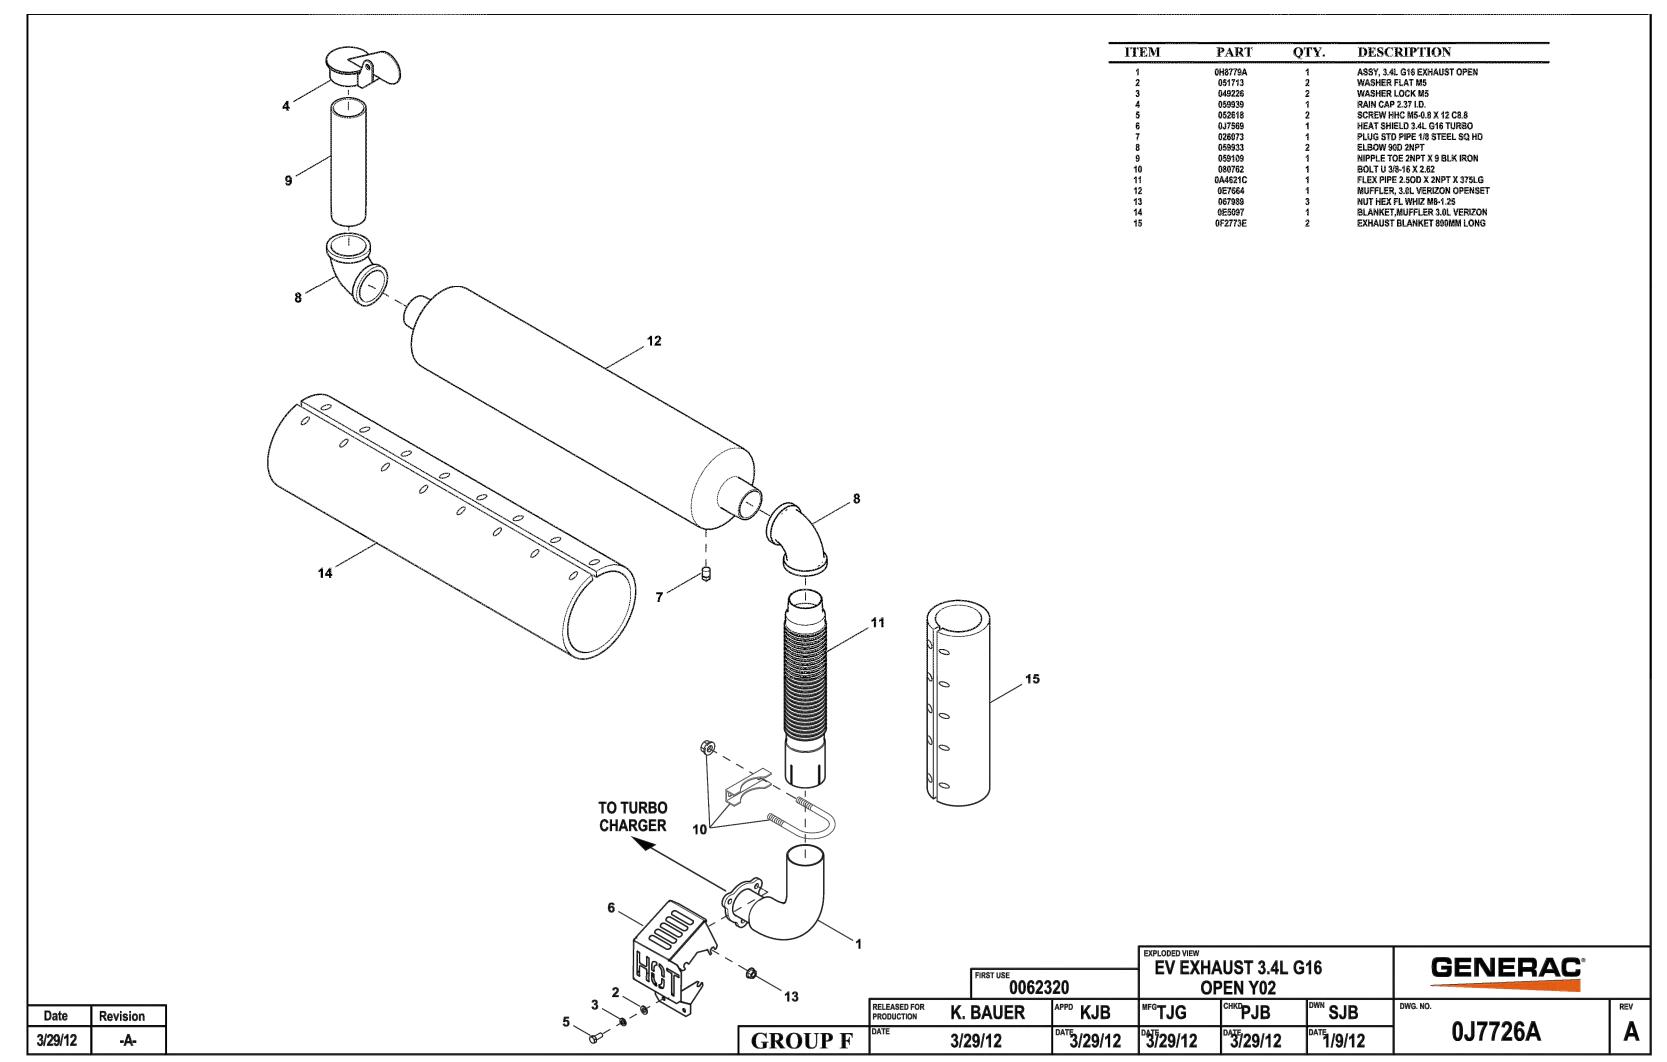


Project Address:

2905 Arrowcreek Pkwy Reno, NV 89511



PROJECT NO: 20141021630 LOCATION NO: 288151 B.K.W. DRAWN BY: B.K.W. CHECKED BY:

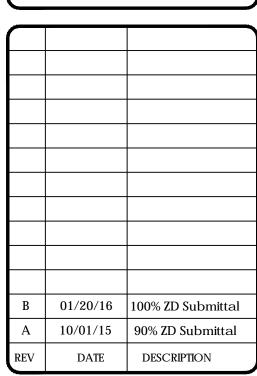

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GENERATOR