# Community Services Department Planning and Development SPECIAL USE PERMIT APPLICATION



#### **Washoe County Development Application**

Your entire application is a public record. If you have a concern about releasing personal information, please contact Planning and Development staff at 775.328.3600.

Project Information	S	taff Assigned Case No.: <u>.SB/</u>	1-016
Project Name: Utility Operations Building			
Project Construction of a Description: equipment	free standing Operat	ions Building to house operations	s staff and
Project Address: 8455 Alexand	er Lake Road		
Project Area (acres or square fe	et): 49.43 Acres		
Project Location (with point of re	ference to major cross	streets AND area locator):	
Southeast Corridor located on A	Alexander Rd - Neare	est cross street South McCarran	Blvd
Assessor's Parcel No.(s):	Parcel Acreage:	Assessor's Parcel No(s):	Parcel Acreage:
165-011-05	49.43	165.012-01	7.28
165.011-06	14.97	164-022-05	11.65
Section(s)/Township/Range: Se	04 T18 R20		
	e County approval	s associated with this applicat	ion:
Case No.(s). SB14-004			
Applicant	Information (atta	ch additional sheets if necessary	)
Property Owner:		Professional Consultant:	
Name: Washoe County		Name:	
Address: 4930 Energy Wy		Address:	
Reno, NV	Zip: 89502		Zip:
Phone: 775-328-3763	Fax:	Phone:	Fax:
Email: wwardell@washoecoun	ty.us	Email:	
Cell: 775-750-7325	Other:	Cell:	Other:
Contact Person: Bill Wardell		Contact Person:	
Applicant/Developer:		Other Persons to be Contacted:	
Name:		Name:	
Address:		Address:	
	Zip:	Zip:	
Phone:	Fax:	Phone:	Fax:
Email:		Email:	
Cell:	Other:	Cell:	Other:
Contact Person:		Contact Person:	
	For Office	Use Only	
Date Received: /o/ə / //4	Initial: TAC	Planning Area: SETM	
County Commission District:	2	Master Plan Designation(s):	SR
CAB(s): STMWV - CAL	ξ	Regulatory Zoning(s): 귏 위	SP

#### Special Use Permit Application Supplemental Information

(All required information may be separately attached)

Chapter 110 of the Washoe County Code is commonly known as the Development Code. Specific references to special use permits may be found in Article 810, Special Use Permits.

1.	What is the type of project being requested?
	Addition of an Operations Building adjacent to the existing South Truckee Meadows Water Reclamation Facility. The structure is to be used for equipment storage for utility maintenance and staff offices.
	What currently developed portions of the property or existing structures are going to be used with this permit?
	The current treatment facility is immediately south of the proposed building location and is adjacent to the proposed expansion to the north of the existing facility.
3.	What improvements (e.g. new structures, roadway improvements, utilities, sanitation, water supply, drainage, parking, signs, etc.) will have to be constructed or installed and what is the projected time frame for the completion of each?
	The plans include the construction of a single detached metal building structure to adjoin an existing paved access apron that ties to the existing driveway. An extension to the proposed apron area will occur to accommodate staff and public parking and exterior equipment storage.  The project is anticipated to go out to bid in Jan 2015 and construction to be

completed by June 30, 2015.

4.	What is the intended phasing schedule for the construction and completion of the project?
	The project will be only one phase.
5.	What physical characteristics of your location and/or premises are especially suited to deal with the impacts and the intensity of your proposed use?
	The currently operated treatment facility is located outside of an existing industrial area in the Southeast corridor. One method of site access from Alexander Road exists. Since the initial construction completed in 1990, no complaints of noise or odor have been reported by adjacent property owners. The proposed structure will not add to or supplement any noise or odor or intensify the potential for noise or odor.
6.	What are the anticipated beneficial aspects or effects your project will have on adjacent properties and the community?
	The relocation of Utility Operations staff and equipment to this building will place them in a more direct location to facilitate their job function to the facility and adjacent distribution and collection system. It will also increase efficiency and response times by putting equipment and staff closer to their primary work areas.
7.	What will you do to minimize the anticipated negative impacts or effects your project will have on adjacent properties?
	No noise or odors will be generated from the proposed building. The colors on the building will be neutral to blend with the surrounding environment. Equipment stored will either be inside the building or directly adjacent to the building on the exterior with fencing to conceal it.

8. Please describe operational parameters and/or voluntary conditions of approval to be imposed on the project special use permit to address community impacts:

The existing STMWRF facility generally operates from 7:30am to 4:30pm Monday through Friday. This building will operate during similar hours of operation. Fencing height adjacent to the proposed building will be increased from 6 feet to 8 feet to mitigate equipment storage located adjacent to the building. The fencing will be slatted to comply with the existing special use permit for the STMWRF project.

9. How many improved parking spaces, both on-site and off-site, are available or will be provided? (Please indicate on site plan.)

10 parking spaces for staff's personal vehicles will be provided along with 8 additional parking spaces for public and ancillary use with two of those 8 spaces dedicated as accessible parking, one of which will be van accessible


10. What types of landscaping (e.g. shrubs, trees, fencing, painting scheme, etc.) are proposed? (Please indicate location on site plan.)

Small to medium sized evergreen trees and shrubs will be placed around the proposed building and parking areas as well as revegetation in areas around the perimeter of the construction activity zone to restore areas disturbed as part of the construction. See attached site plan for conceptual planting zones and types.

11. What type of signs and lighting will be provided? On a separate sheet, show a depiction (height, width, construction materials, colors, illumination methods, lighting intensity, base landscaping, etc.) of each sign and the typical lighting standards. (Please indicate location of signs and lights on site plan.)


A sign following standard Washoe County size and formatting will be placed at the driveway connection to direct public traffic to the proposed building as well as a sign attached to the structure adjacent to the primary entrance to identify the building. No additional lighting or signage is proposed. Any exterior lighting will meet current code requirements.

☐ Yes	☑ No	
13. Community Sewer		
☑ Yes	□ No	
☑ Yes Community Water	□ No	

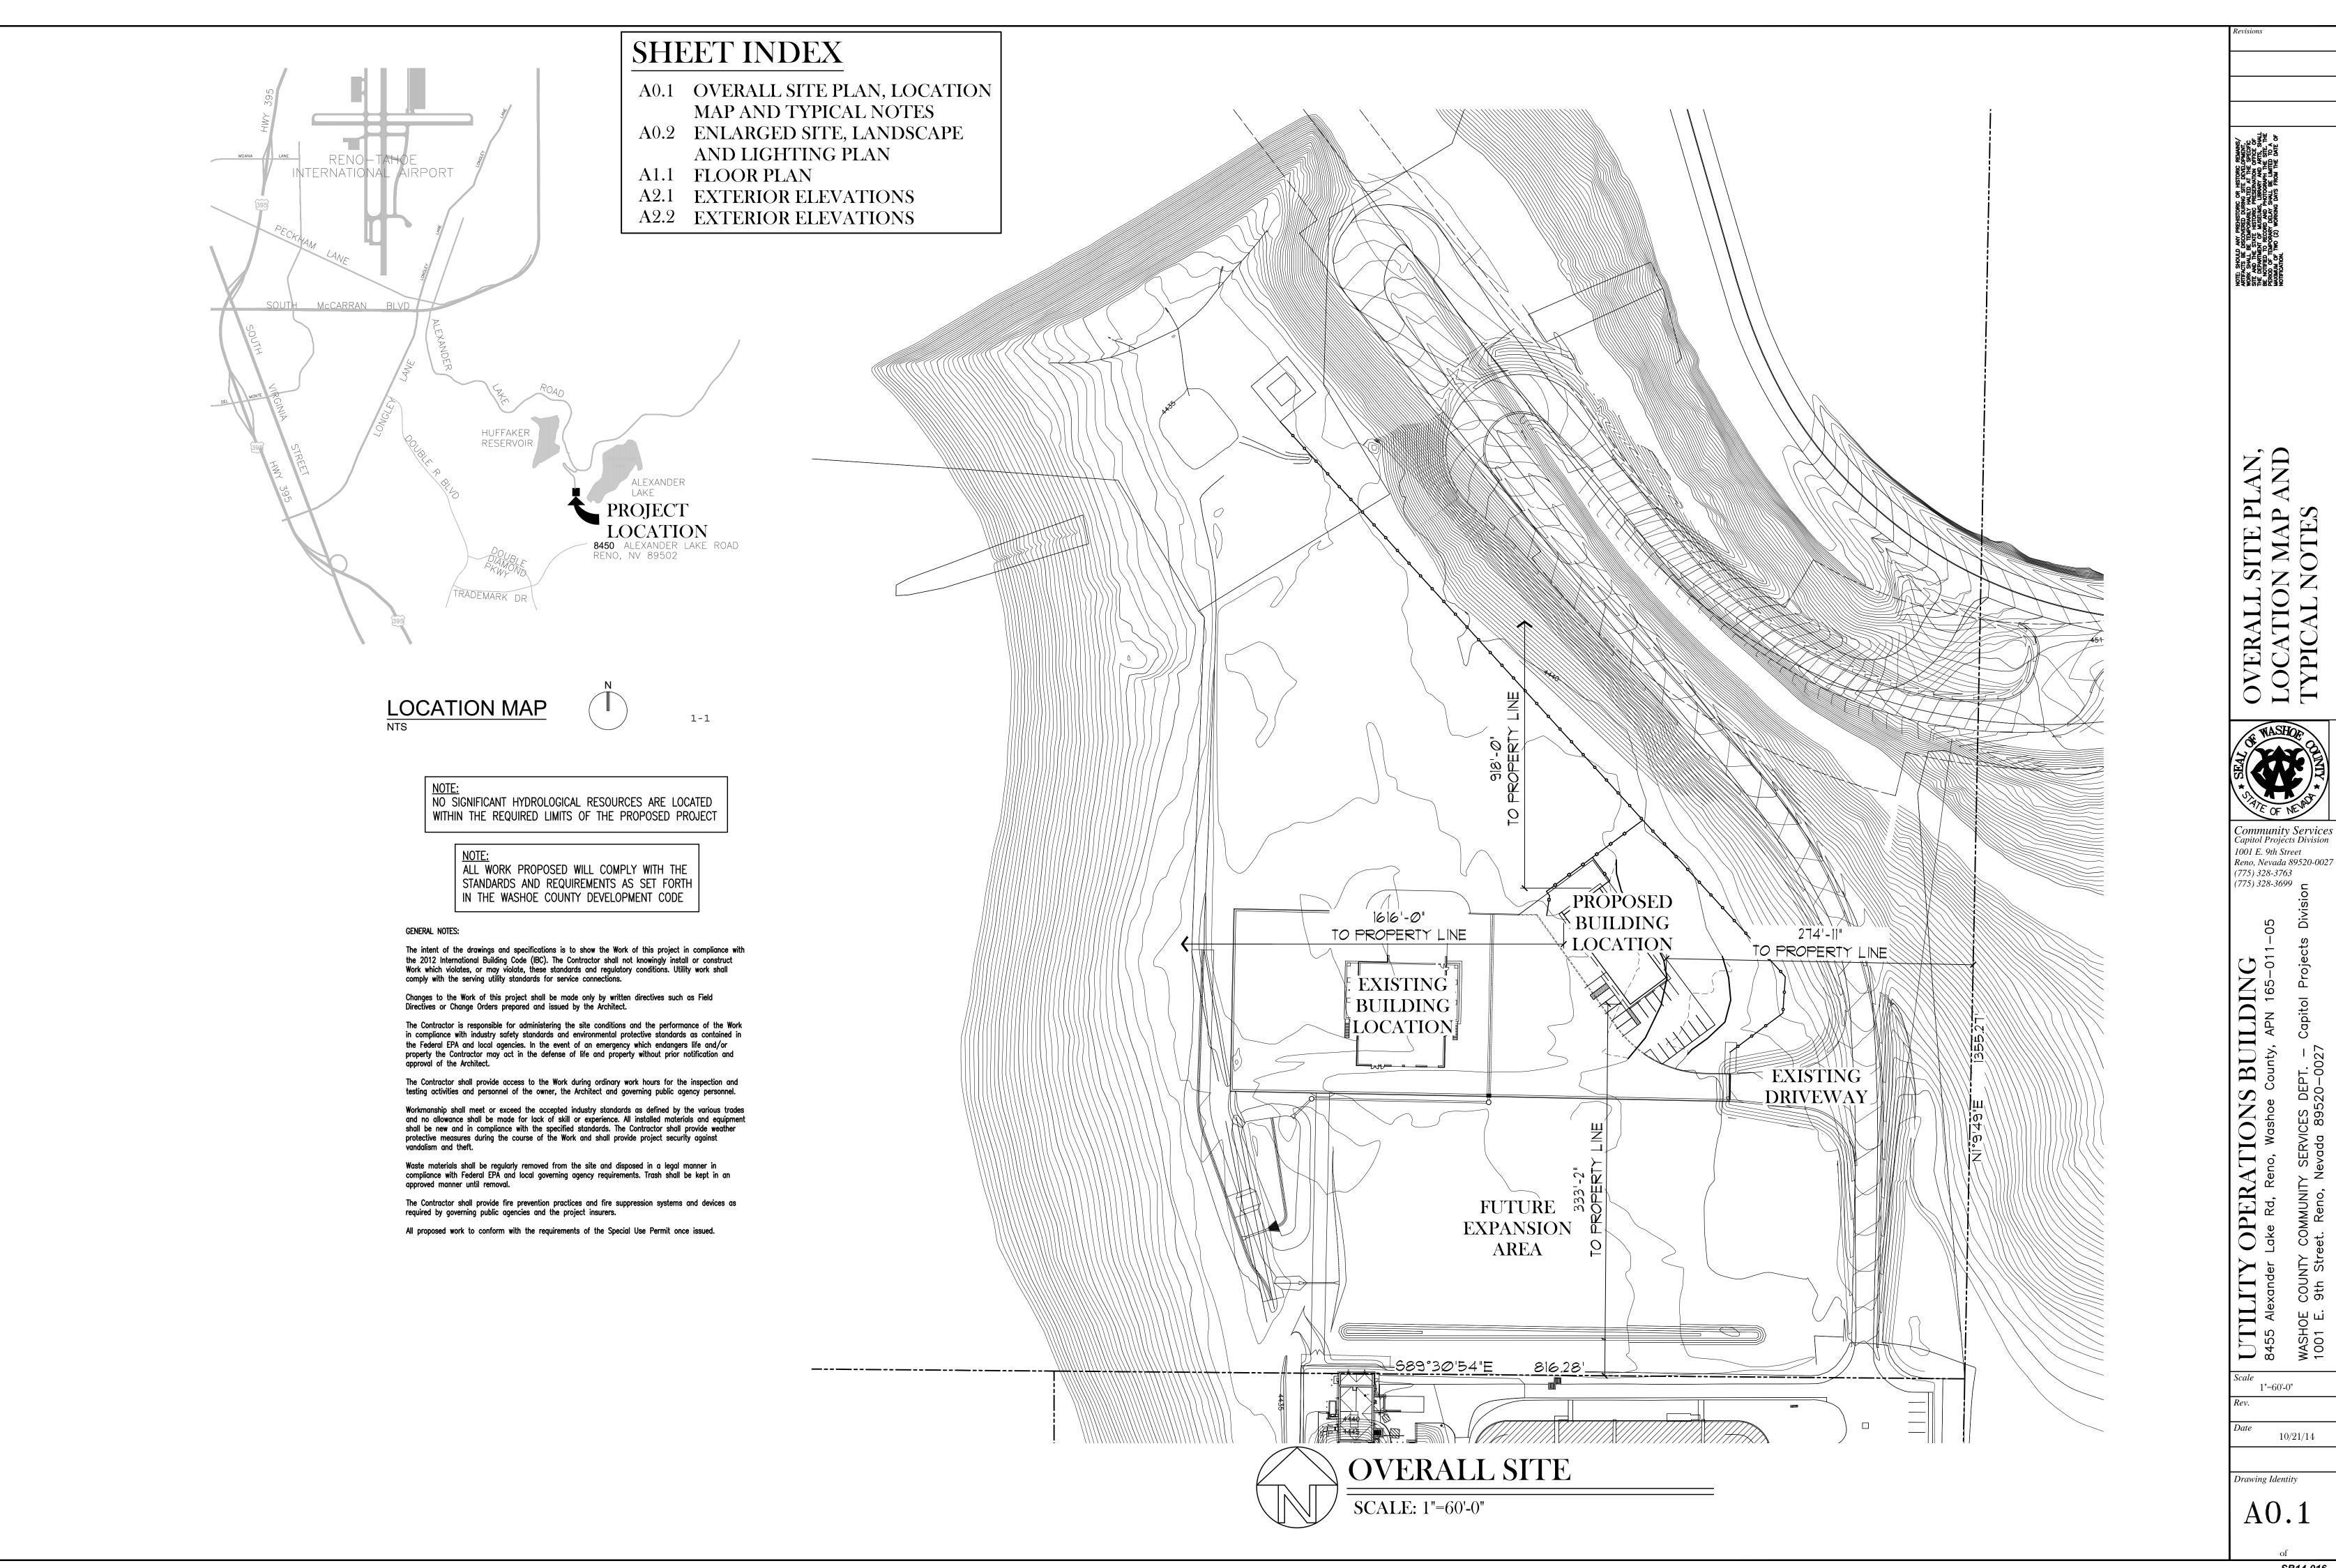

10/21/14

SB14-016

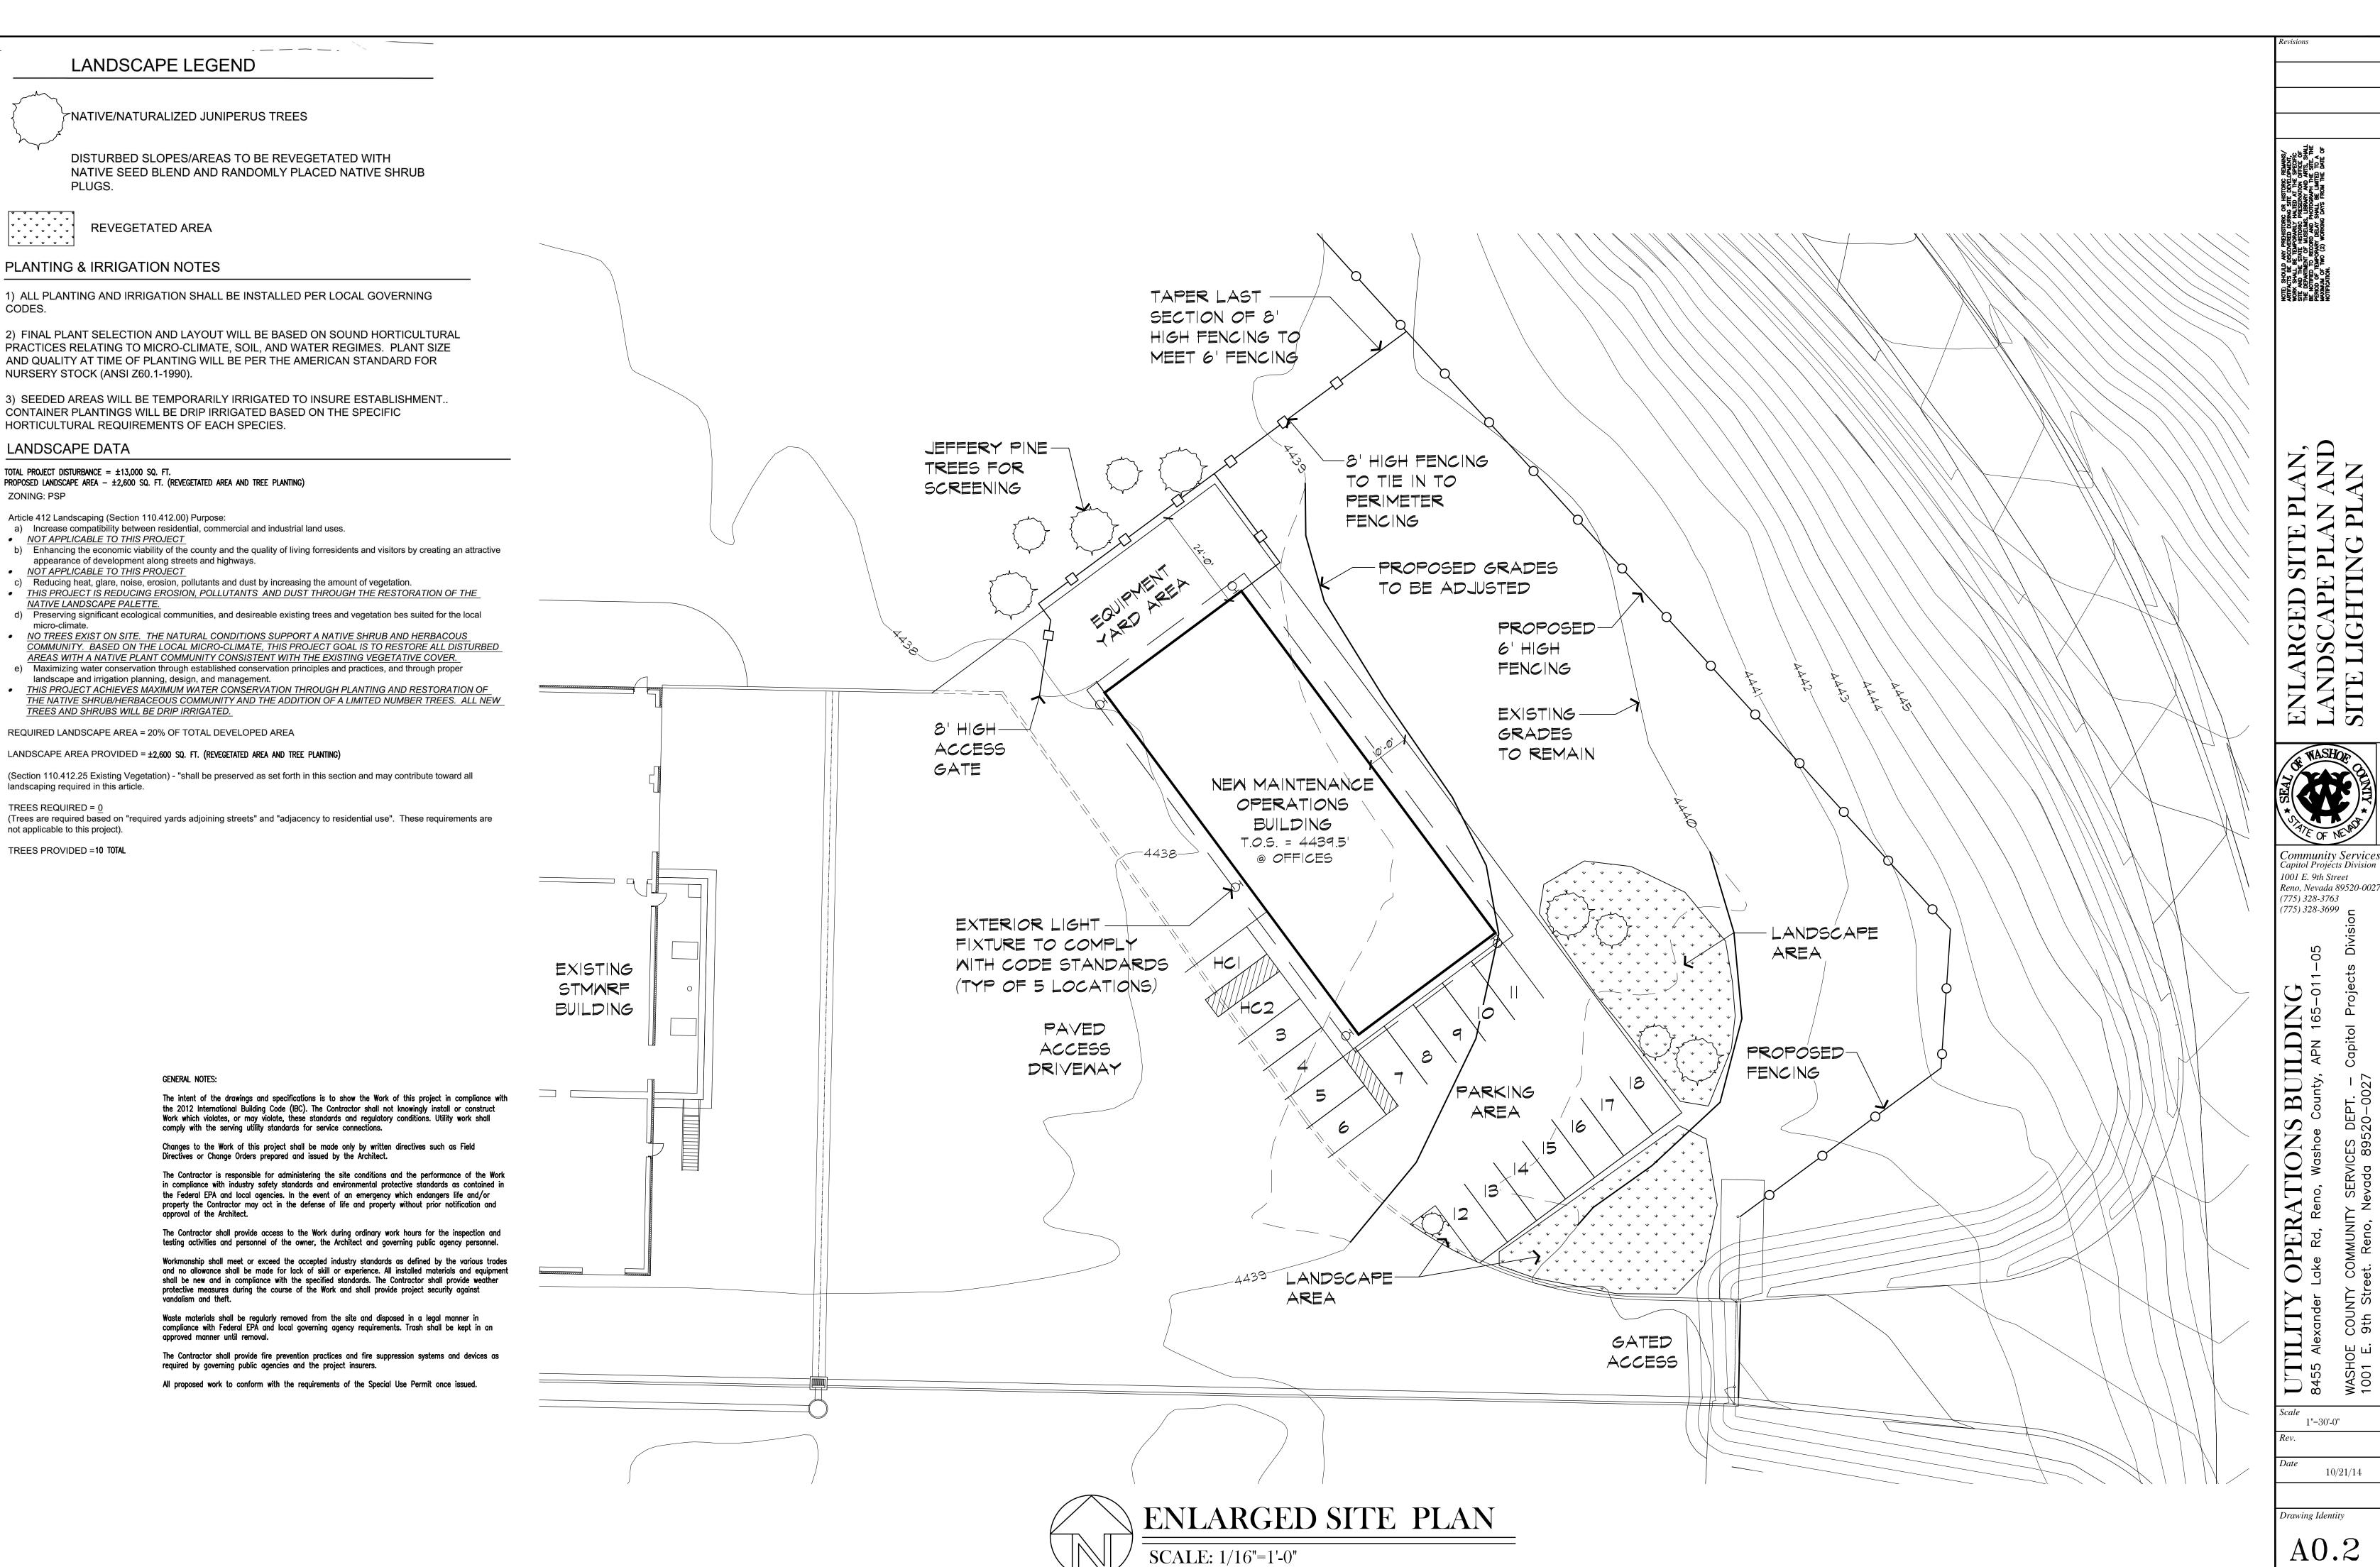

OPERATIONS BUILDING Lake Rd, Reno, Washoe County, APN 165-011


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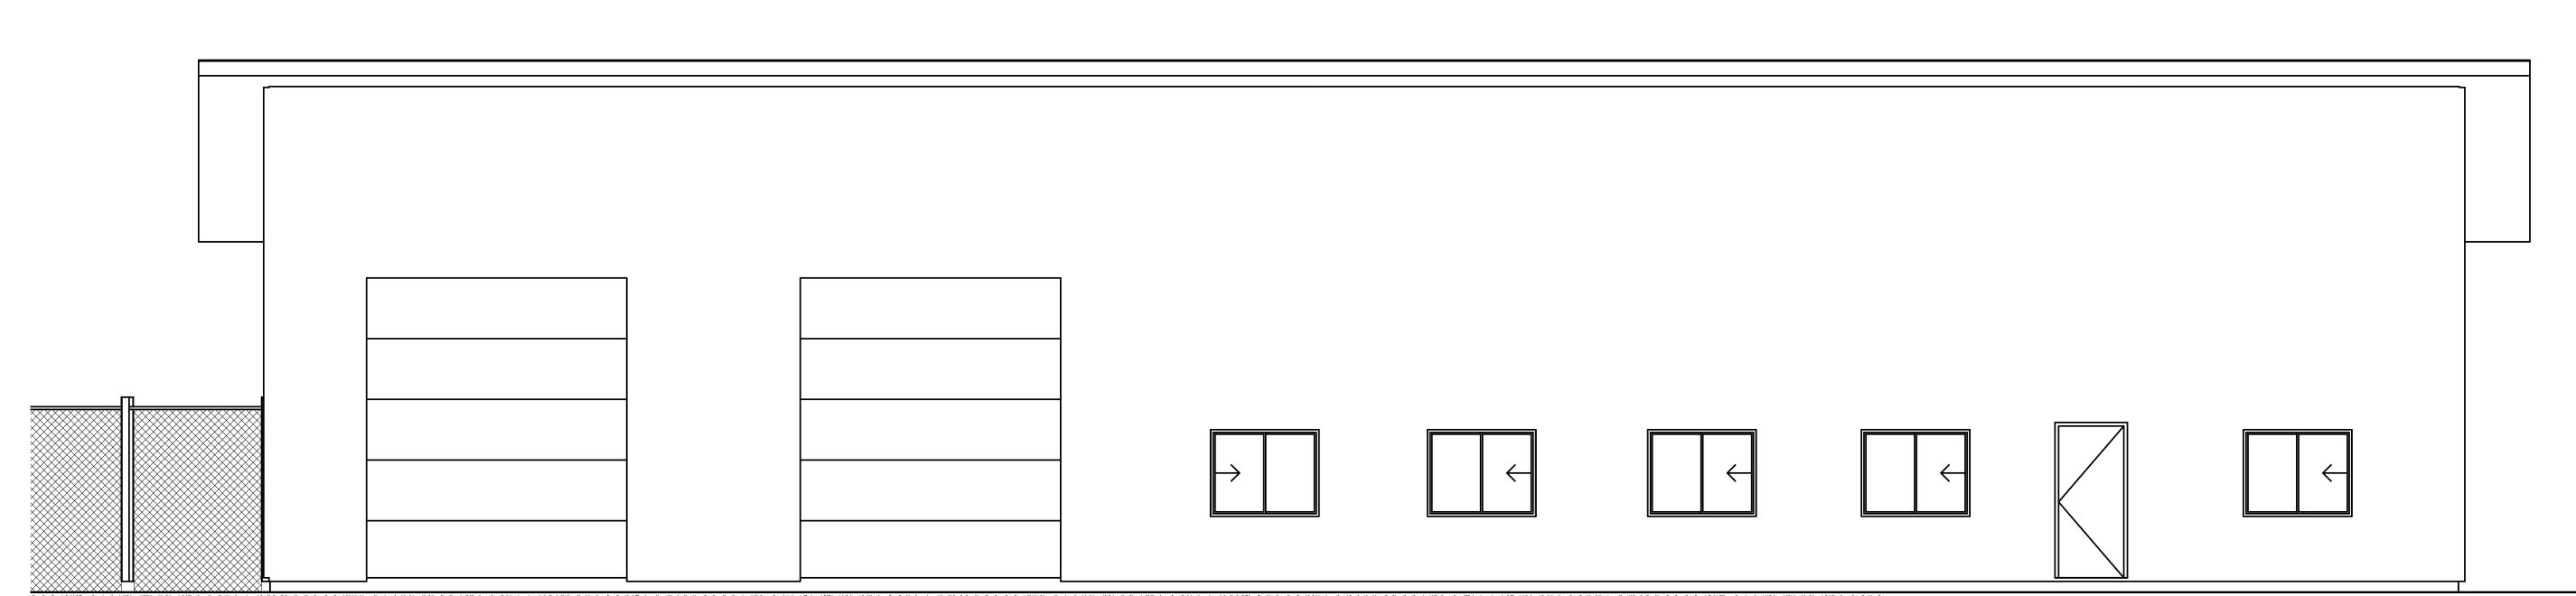
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SB14-016



SCALE: 1/4"=1'-0"



## SOUTHWEST EXTERIOR ELEVATION

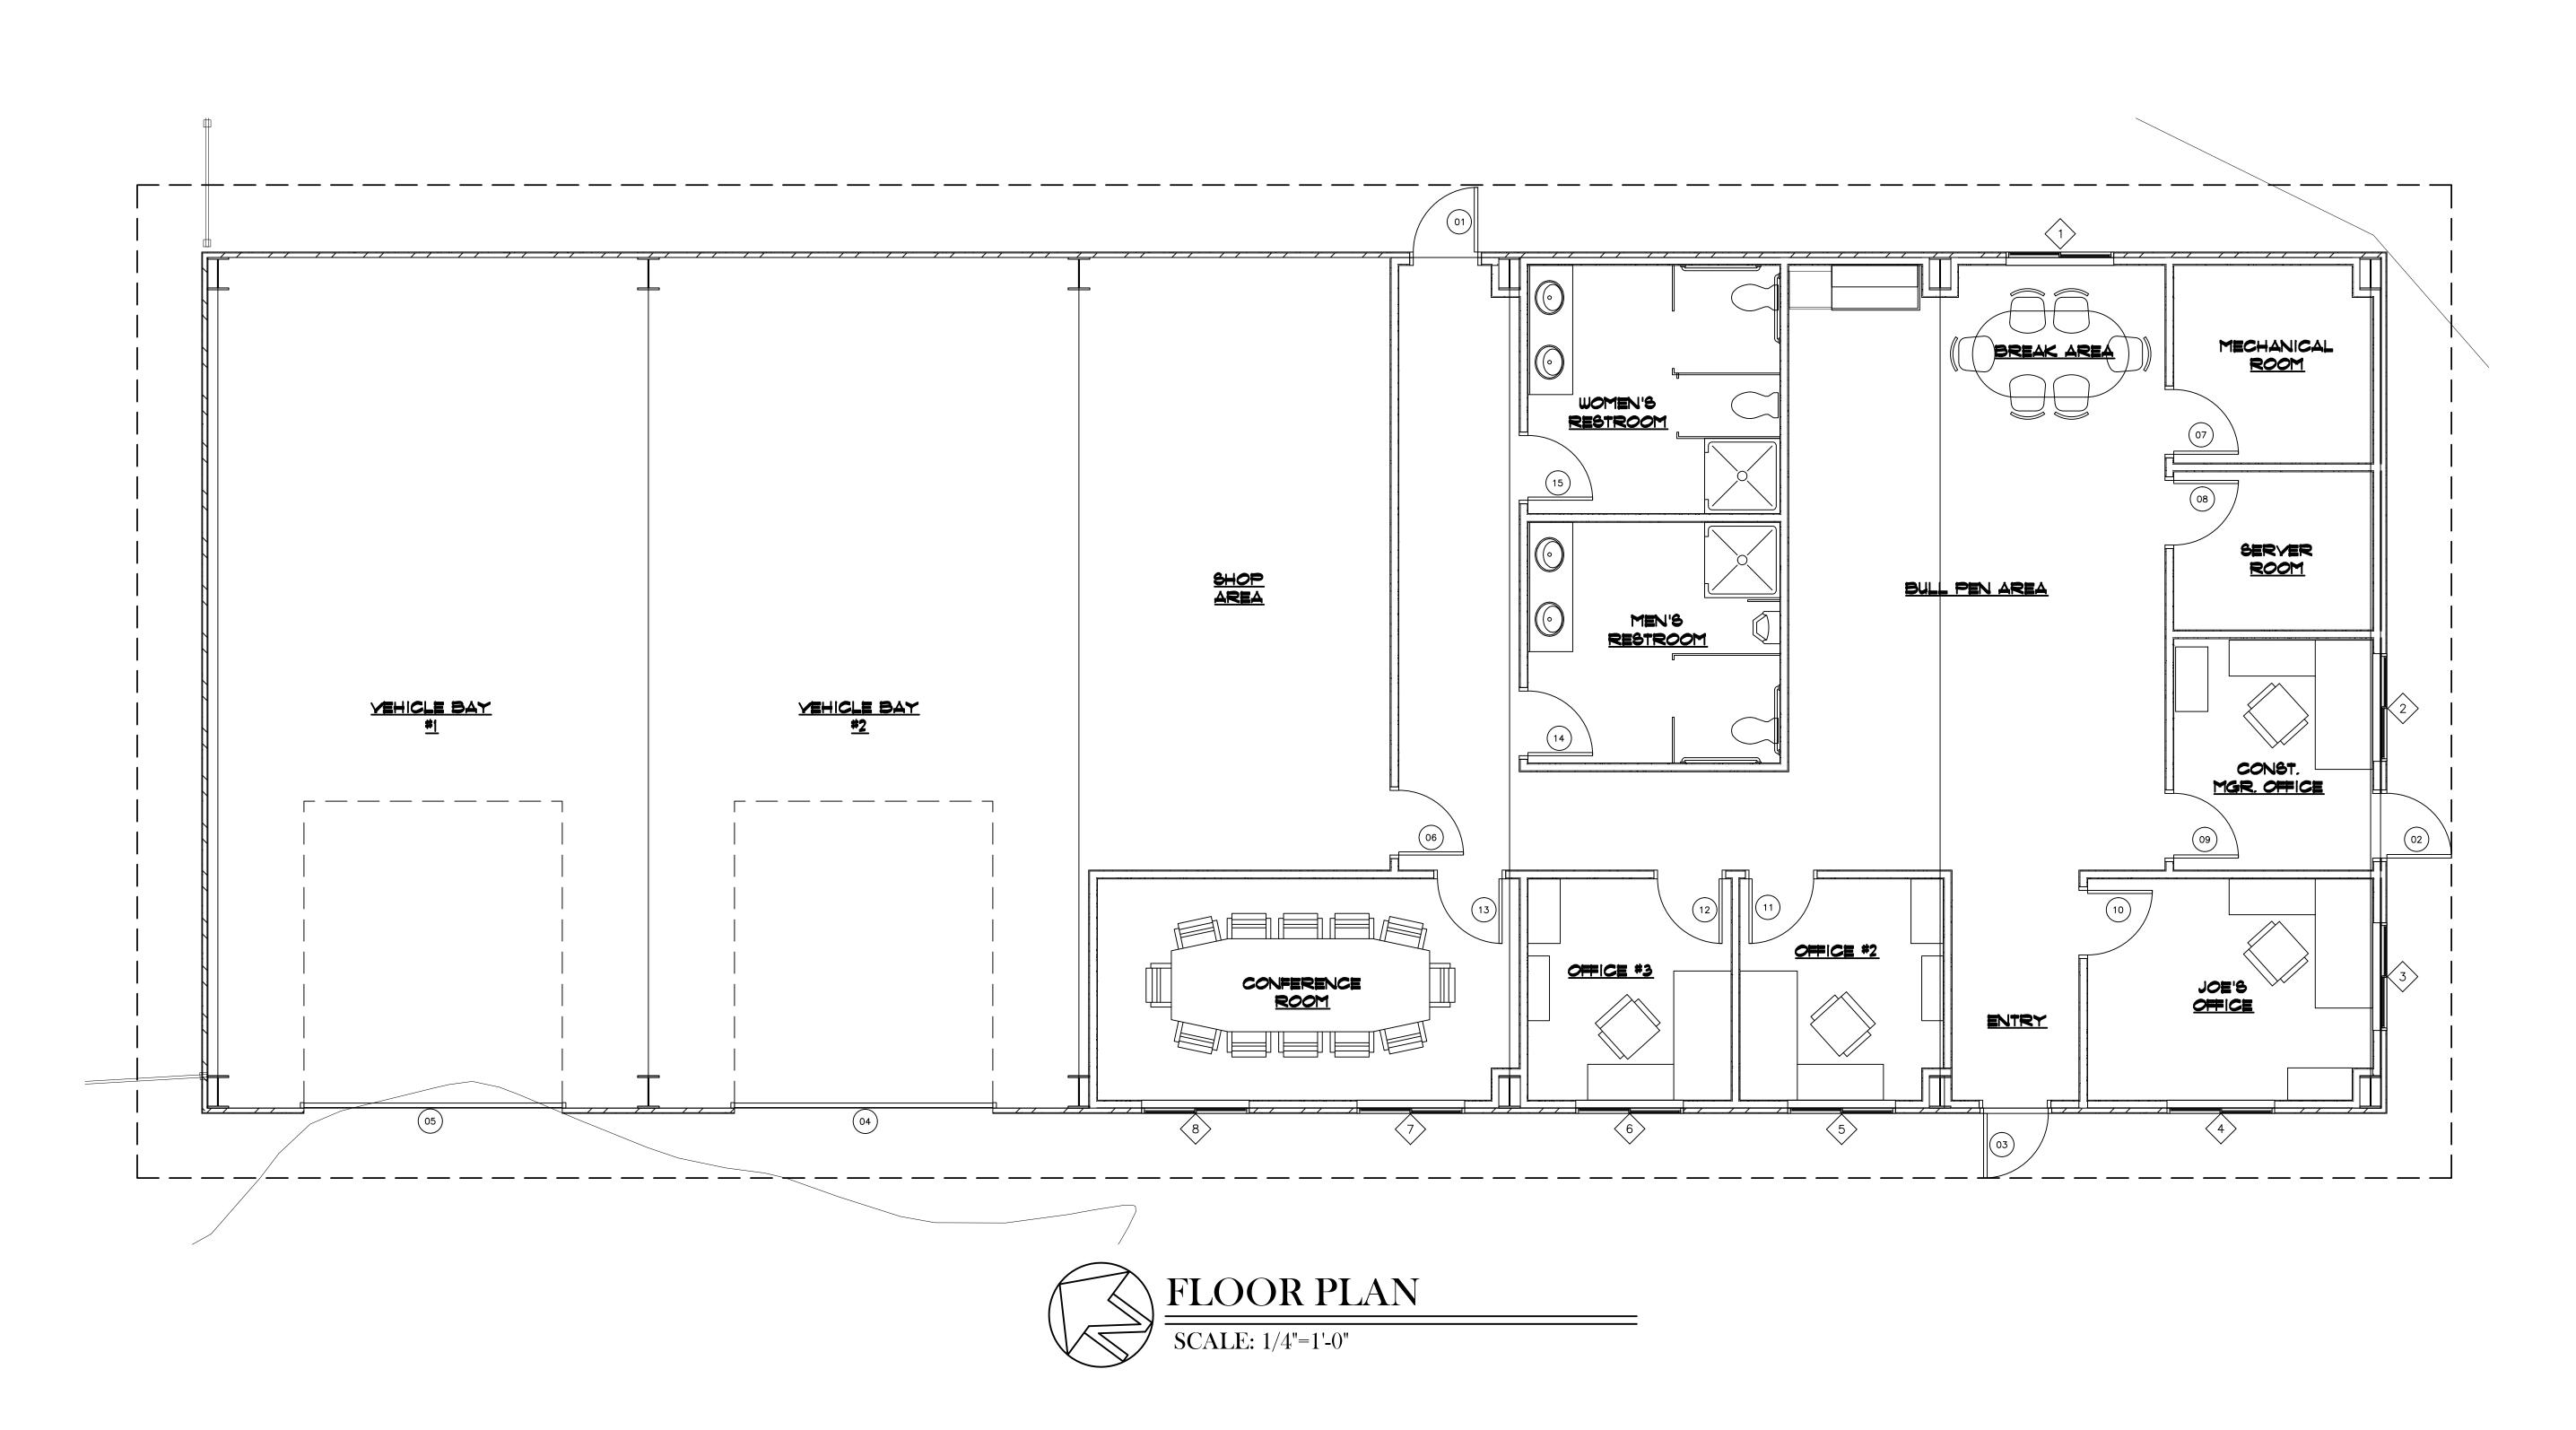SCALE: 1/4"=1'-0"

NOTE: SHOULD ANY PREHISTORIC OR HISTORIC REMANS/ ARTIFACTS BE DISCOVERED DURING SITE DELEGIARITY, WORK SHALL BE TEMPORARIY HALTED AT THE SPECTR'C SITE AND THE STATE HISTORIC PRESERVATION OFFICE OF THE DEPARTMENT OF MUSCINAS, LIBRARY AND ARTS, SHA BE NOTFED TO RECORD AND PHOTOGRAPH THE SITE TH PERSON OF TEMPORARY DELAY SHALL BE LIMITED TO A MAXIMUM OF TIMO (2) WORGING DAYS FROM THE DATE NOTFICATION.

EXTERIOR ELEVATIONS

Community Services
Capitol Projects Division

Community Services Capitol Projects Division 1001 E. 9th Street Reno, Nevada 89520-0027 (775) 328-3763 (775) 328-3699

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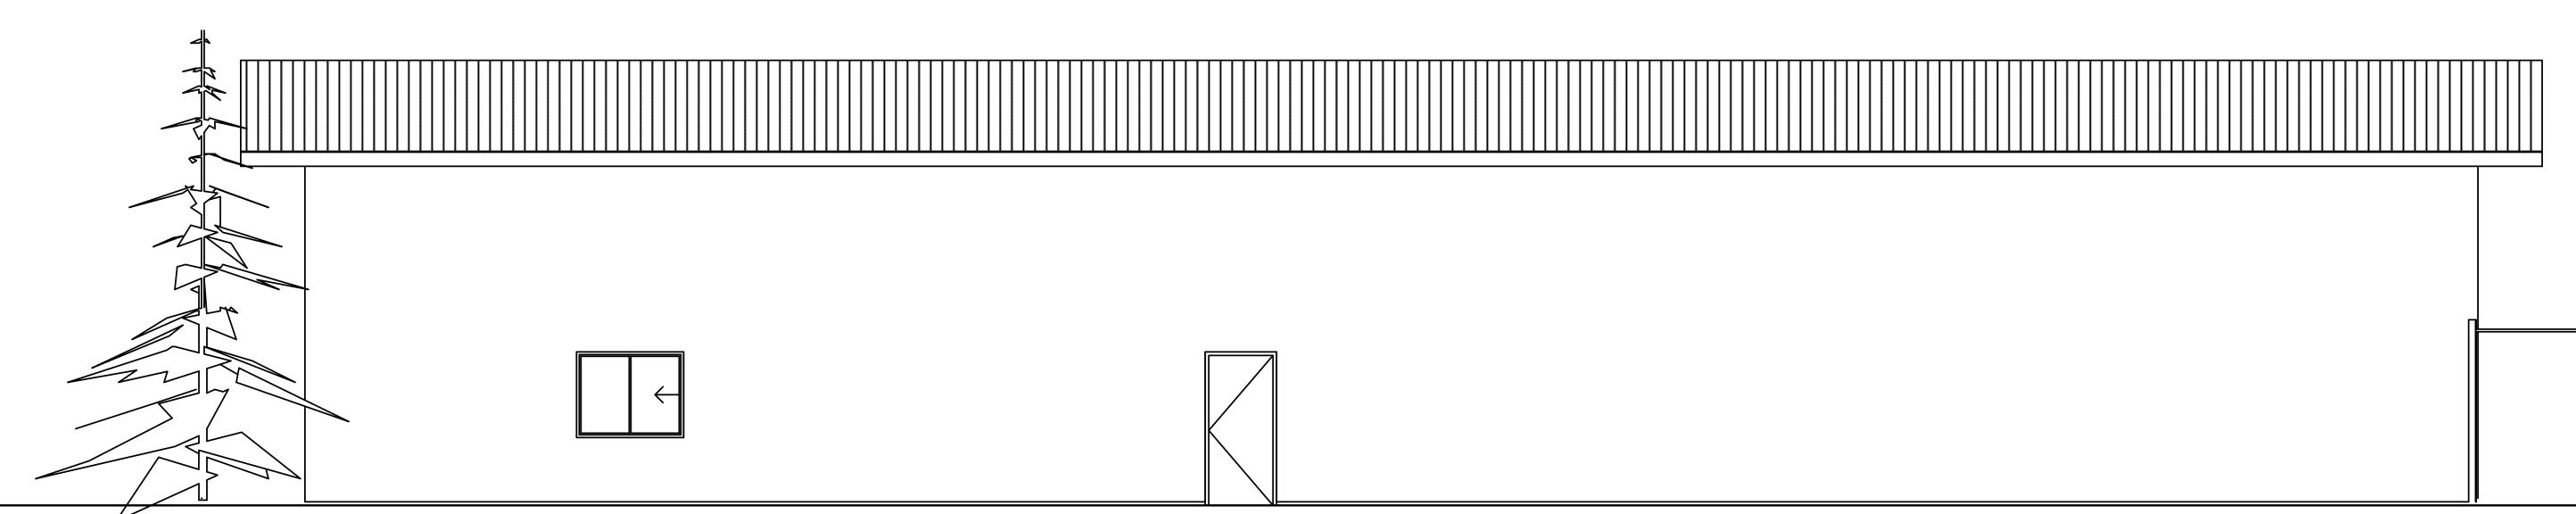
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Drawing Identity

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### NORTHEAST EXTERIOR ELEVATION

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EXTERIOR ELEVATIONS

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o, Washoe County, APN 165-011-05

SERVICES DEPT. - Capitol Projects Division

TILITY OPERATIONS BUILD) is Alexander Lake Rd, Reno, Washoe County, APN 18HOE COUNTY COMMUNITY SERVICES DEPT. — Capitol

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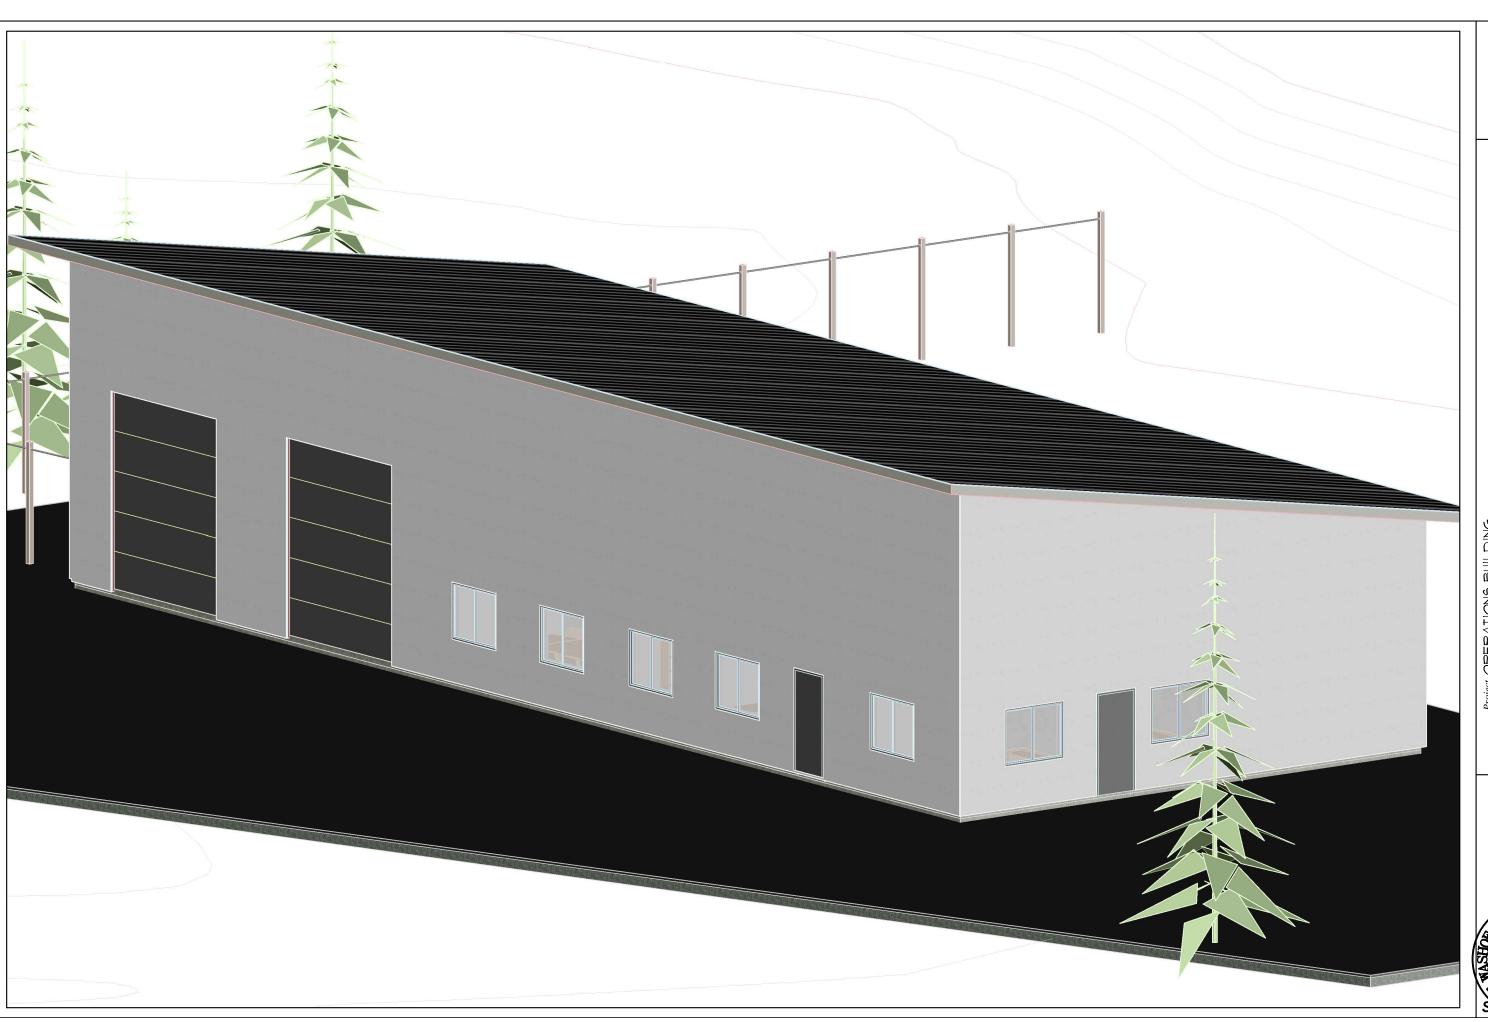
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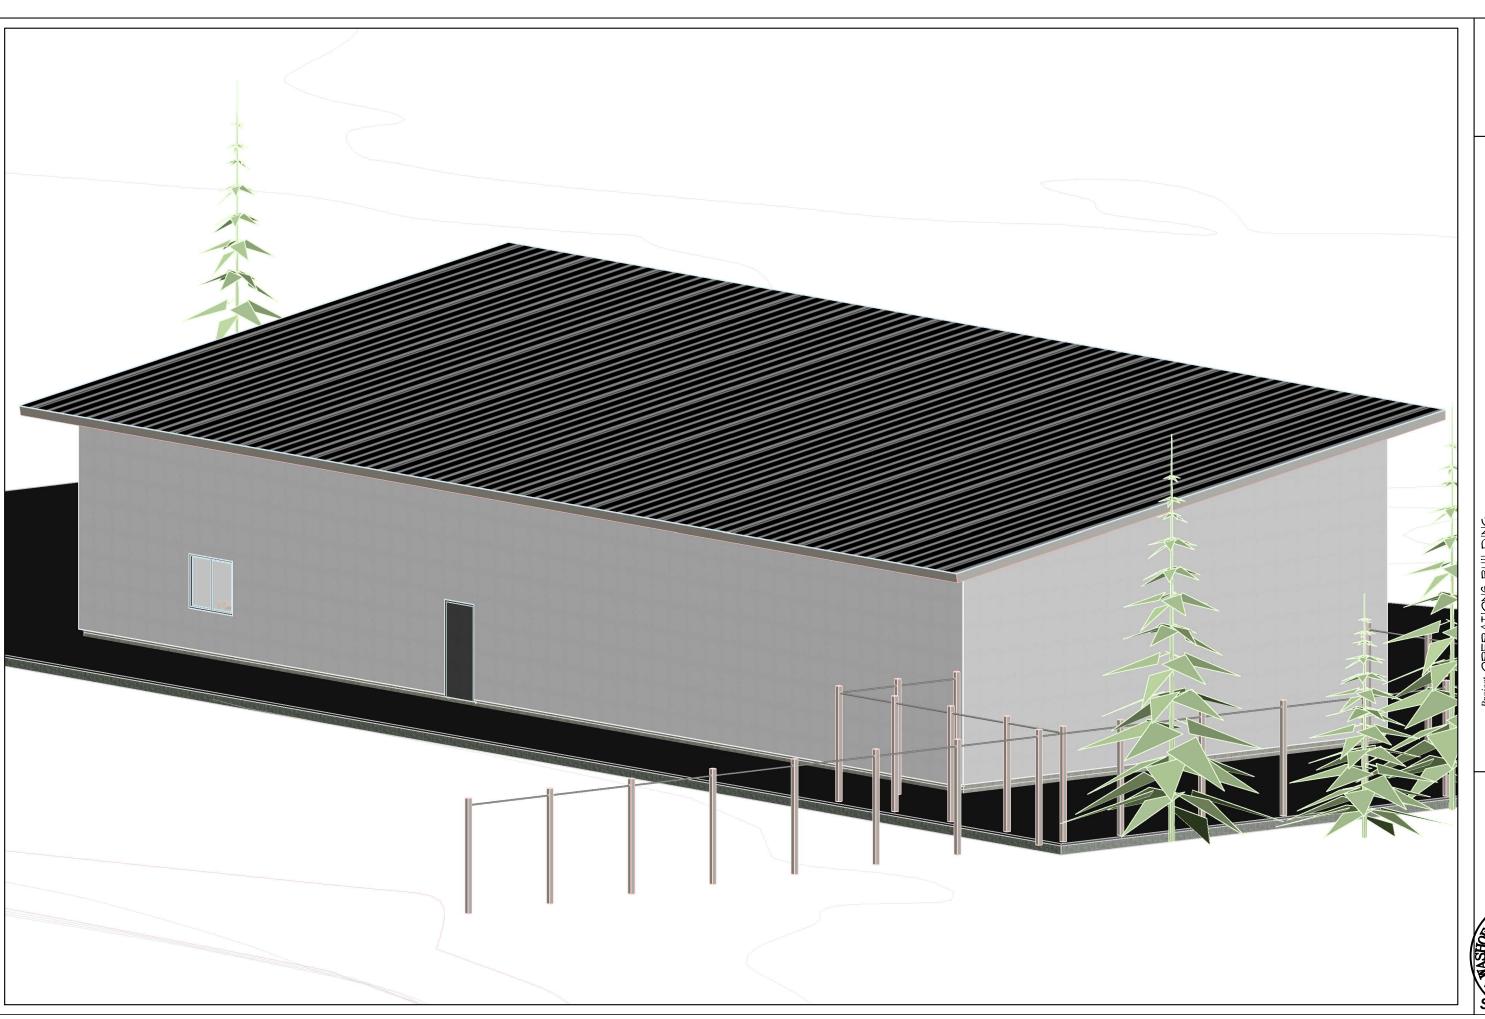
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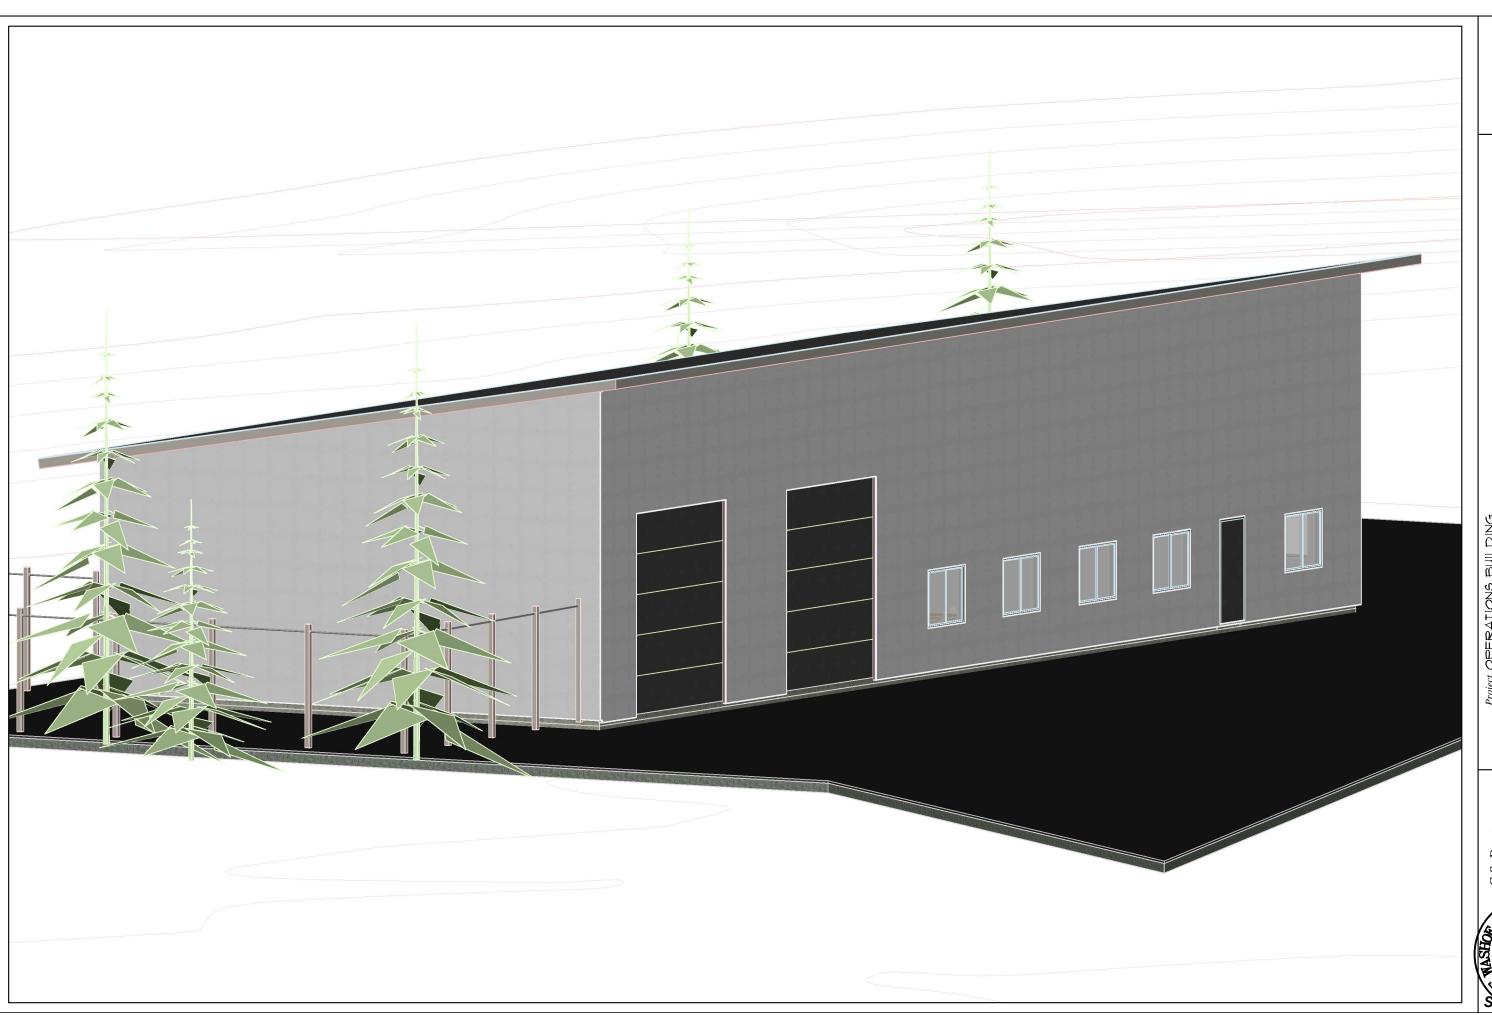


Date 10/21/14
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Drawing Name: 3D VIEW FROM SOUTHWEST



12.3

Date 10/21/14
Scale NOT TO SCALE
Drawing Name: 3D VIEW FROM NORTHEAST



Date 10/21/14
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Drawing Name: 3D VIEW FROM NORTHWEST