

Post Office Box 6315 Tahoe City, California 96145

December 8, 2020

Planning & Building Division Washoe County 1001 E. Ninth Street Reno, NV 89512

Subject:

920 Southwood Blvd, LLC ("Bowl Incline")

Proposed Special Use Permit

920 Southwood Boulevard, Incline Village, Nevada

Washoe County APN: 132-232-08

To Whom It May Concern:

Based on our recent predevelopment meeting with Chris Bronczyk and Dan Cahalane in Planning, we are submitting this Special Use Permit application to establish an Outdoor Amusements use in association with the existing Bowl Incline (Amusements and Recreations Services) commercial facility at the property. We are submitting this Special Use Permit application for your review and processing towards the anticipated Citizen's Advisory Board meeting and subsequent Board of Adjustments hearing.

Included with this submittal, please find the following required application item and supporting documents:

- Washoe County Predevelopment Worksheet
- Check in the amount of \$3,440.80 for application fees (Tahoe Minor Commercial) and Signed Washoe County Development Application Form (delivered separately via courier)
- Proof of Property Tax Payment
- Proposed Architectural Plan Set (Dennis E. Zirbel, Architect), including planting, lighting and elevations
- Parking Demand Study (LSC Transportation Consultants, Inc., dated 12/3/2020)
- Project Description Document
- Current Grant Deed

920 Southwood Blvd, LLC proposes to renovate the existing Bowl Incline facility in conjunction with creating a new outdoor lounge and use area to encourage year-round use and increased vitality for this existing commercial business and the Incline Village community. The property is located in the Incline Village Community Plan, jointly adopted by the Tahoe Regional Planning Agency and Washoe

County, where a various commercial uses are permissible. The proposed renovation project for Bowl Incline includes "Amusements and Recreations Services" and "Outdoor Amusements" use types; both use types are considered Special Uses under the Community Plan.

Should you have any questions or require additional information, please do not hesitate to contact our office. Your efforts in the processing of this application are greatly appreciated.

Sincerely,

WWO: Attachments

cc: Dennis E. Zirbel

Community Services Department Planning and Building

SPECIAL USE PERMIT (see page 7)

SPECIAL USE PERMIT FOR GRADING (see page 9)

SPECIAL USE PERMIT FOR STABLES (see page 12)

APPLICATION



Community Services Department Planning and Building 1001 E. Ninth St., Bldg. A Reno, NV 89512-2845

Telephone: 775.328.6100

Washoe County Development Application

Your entire application is a public record. If you have a concern about releasing personal information, please contact Planning and Building staff at 775.328.6100.

Project Information	s	Staff Assigned Case No.:								
Project Name:										
Project Description:										
Project Address:										
Project Area (acres or square feet):										
Project Location (with point of re	eference to major cross	streets AND area locator):								
Assessor's Parcel No.(s):	Parcel Acreage:	Assessor's Parcel No.(s):	Parcel Acreage:							
Indicate any previous Washo Case No.(s).	e County approval	s associated with this applicat	tion:							
Applicant Inf	ormation (attach	additional sheets if necess	sary)							
Property Owner:		Professional Consultant:								
Name:		Name:								
Address:		Address:								
	Zip:	Zip:								
Phone:	Fax:	Phone:	Fax:							
Email:		Email:								
Cell:	Other:	Cell: Other:								
Contact Person:		Contact Person:								
Applicant/Developer:		Other Persons to be Contacted:								
Name:		Name:								
Address:		Address:								
	Zip:		Zip:							
Phone:	Fax:	Phone:	Fax:							
Email:		Email:								
Cell:	Other:	Cell:	Other:							
Contact Person:		Contact Person:								
	For Office	Use Only								
Date Received:	Initial:	Planning Area:								
County Commission District:		Master Plan Designation(s):								
CAB(s):		Regulatory Zoning(s):								

Property Owner Affidavit

Applicant Name: 920 SOUTHWOOD BUD LIC.
The receipt of this application at the time of submittal does not guarantee the application complies with all requirements of the Washoe County Development Code, the Washoe County Master Plan or the applicable area plan, the applicable regulatory zoning, or that the application is deemed complete and will be processed.
STATE OF NEVADA)
COUNTY OF WASHOE)
1. TRACY M. TOMKOVICZ
(please print name)
being duly sworn, depose and say that I am the owner* of the property or properties involved in this application as listed below and that the foregoing statements and answers herein contained and the information herewith submitted are in all respects complete, true, and correct to the best of my knowledge and belief. I understand that no assurance or guarantee can be given by members of Planning and Building.
(A separate Affidavit must be provided by each property owner named in the title report.)
Assessor Parcel Number(s): 132-232-08
Signed Address 985 FAIRNA BUD
INCLINE VILLAGE, NV 89451
Subscribed and sworn to before me this
DERRICK AMENT
Notary Public in and for said county and state Notary Public - State of Nevada Appointment Recorded in Washoe County
My commission expires: May 10, 2023 No: 11-4858-2 - Expires May10, 2023
*Owner refers to the following: (Please mark appropriate box.)
□ Owner
□ Corporate Officer/Partner (Provide copy of record document indicating authority to sign.)
□ Power of Attorney (Provide copy of Power of Attorney.)
 Owner Agent (Provide notarized letter from property owner giving legal authority to agent.)
☐ Property Agent (Provide copy of record document indicating authority to sign.)
□ Letter from Government Agency with Stewardship

Special Use Permit Application Supplemental Information (All required information may be separately attached)

1.	What is the project being requested?
2.	Provide a site plan with all existing and proposed structures (e.g. new structures, roadway improvements, utilities, sanitation, water supply, drainage, parking, signs, etc.)
3.	What is the intended phasing schedule for the construction and completion of the project?
4.	What physical characteristics of your location and/or premises are especially suited to deal with the impacts and the intensity of your proposed use?
5.	What are the anticipated beneficial aspects or affects your project will have on adjacent properties and the community?
6.	What are the anticipated negative impacts or affect your project will have on adjacent properties? How will you mitigate these impacts?
7.	Provide specific information on landscaping, parking, type of signs and lighting, and all other code requirements pertinent to the type of use being purposed. Show and indicate these requirements on submitted drawings with the application.

☐ Yes				No	
Utilities:					
a. Sewer Service					
b. Electrical Service					
c. Telephone Service					
d. LPG or Natural Gas	Service				
e. Solid Waste Disposa	al Service				
f. Cable Television Se	rvice				
g. Water Service					
i. Certificate #				acre-feet per year acre-feet per year	
For most uses, Washo Requirements, requires					
h. Permit #				core feet per veer	
				· · · · · · · · · · · · · · · · · · ·	
i. Gortinoato ii				dore reet per year	
i Surface Claim #				acre-feet per vear	
j. Surface Claim # k. Other # Title of those rights (as	s filed with	the Stat	e Engin	acre-feet per year acre-feet per year eer in the Division of	Water Resources of th
·				acre-feet per year eer in the Division of	Water Resources of the
k. Other # Title of those rights (as	tion and Na	atural Res	sources).	acre-feet per year eer in the Division of	Water Resources of the
k. Other # Title of those rights (as Department of Conserva	tion and Na	atural Res	sources).	acre-feet per year eer in the Division of	Water Resources of the
k. Other # Title of those rights (as Department of Conserva	tion and Na	atural Res	sources).	acre-feet per year eer in the Division of	Water Resources of the
k. Other # Title of those rights (as Department of Conserval Community Services (program a. Fire Station	tion and Na	atural Res	sources).	acre-feet per year eer in the Division of	Water Resources of the
k. Other # Title of those rights (as Department of Conserval Community Services (procease of the Station b. Health Care Facility	tion and Na	atural Res	sources).	acre-feet per year eer in the Division of	Water Resources of the
k. Other # Title of those rights (as Department of Conserval Community Services (program in the Station b. Health Care Facility c. Elementary School	tion and Na	atural Res	sources).	acre-feet per year eer in the Division of	Water Resources of the
k. Other # Title of those rights (as Department of Conserval Community Services (procease as Fire Station b. Health Care Facility c. Elementary School d. Middle School	tion and Na	atural Res	sources).	acre-feet per year eer in the Division of	Water Resources of the
k. Other # Title of those rights (as Department of Conserval Community Services (programation of Services) a. Fire Station b. Health Care Facility c. Elementary School d. Middle School e. High School	tion and Na	atural Res	sources).	acre-feet per year eer in the Division of	Water Resources of the

Special Use Permit Application for Grading Supplemental Information

(All required information may be separately attached)

1.	What is the purpose of the grading?
2.	How many cubic yards of material are you proposing to excavate on site?
3.	How many square feet of surface of the property are you disturbing?
4.	How many cubic yards of material are you exporting or importing? If none, how are you managing to balance the work on-site?
5.	Is it possible to develop your property without surpassing the grading thresholds requiring a Special Use Permit? (Explain fully your answer.)
6.	Has any portion of the grading shown on the plan been done previously? (If yes, explain the circumstances, the year the work was done, and who completed the work.)
7.	Have you shown all areas on your site plan that are proposed to be disturbed by grading? (If no explain your answer.)

roadways	listurbed area	
		erties also be served by the proposed access/grading requested (i.e. if y
are creati	ng a driveway,	would it be used for access to additional neighboring properties)?
		ontal/vertical) of the cut and fill areas proposed to be? What methods will until the revegetation is established?
Are you p Yes	lanning any be	rms?
required?		and you are leveling a pad for a building, are retaining walls going to igh will the walls be and what is their construction (i.e. rockery, concreock)?
What are	you proposing	for visual mitigation of the work?
Will the grain size?	rading propose	ed require removal of any trees? If so, what species, how many and of w

16.	How are you	u providing te	mporary irrigation to the disturbed area?
17.	•	eviewed the re	evegetation plan with the Washoe Storey Conservation District? If yes, have ggestions?
18.		ny restrictive requested gra	e covenants, recorded conditions, or deed restrictions (CC&Rs) that may ading?
	Yes	No	If yes, please attach a copy.

Date: 12/02/2020

Property Tax Reminder Notice

WASHOE COUNTY PO BOX 30039 RENO, NV 89520-3039 775-328-2510

PIN: 13223208

AIN:

Balance Good Through: 12/02/2020 \$0.00 **Current Year Balance:** Prior Year(s) Balance: \$0.00 (see below for details)

Page: 1

\$0.00

AUTO Harlalalardadalalarardadlal

920 SOUTHWOOD BLVD LLC 985 FAIRWAY BLVD 4336 **INCLINE VILLAGE NV 89451**

Description:

Total Due:

Situs: 920 SOUTHWOOD BLVD

INCLINE VILLAGE

This is a courtesy notice. If you have an impound account through your lender or are not sure if you have an impound account and need more information, please contact your lender directly. Please submit payment for the remaining amount(s) according to the due dates shown. Always include your PIN number with your payment. Please visit our website: www.washoecounty.us/treas

	Current Charges													
PIN	Year Bill Number In			Due Date	Charges	Interest	Pen/Fees	Paid	Balance					
13223208	2020	2020461241	1	08/17/2020	1,817.75	0.00	0.00	1,817.75	0.00					
13223208	2020		2	10/05/2020	1,817.61	0.00	0.00	1,817.61	0.00					
13223208	2020		3	01/04/2021	1,817.61	0.00	0.00	1,817.61	0.00					
13223208	2020		4	03/01/2021	1,817.61	0.00	0.00	1,817.61	0.00					
Current Year Totals					7,270.58	0.00	0.00	7,270.58	0.00					

Prior Years												
PIN	Year	Bill Number	Charges	Interest	Pen/Fees	Paid	Balance					
Prior Years Total												

920 SOUTHWOOD BLVD, LLC ("BOWL INCLINE")
PROPOSED SPECIAL USE PERMIT
920 SOUTHWOOD BOULEVARD, INCLINE VILLAGE, NEVADA
WASHOE COUNTY APN: 132-232-08

PROJECT DESCRIPTION

Summary of Request: 920 Southwood Blvd, LLC proposes to renovate the existing Bowl Incline facility in conjunction with creating a new outdoor lounge and use area to encourage year-round use and increased vitality for this existing commercial business and the Incline Village community. The property is located in the Incline Village Community Plan, jointly adopted by the Tahoe Regional Planning Agency and Washoe County, where a various commercial uses are permissible. The proposed renovation project for Bowl Incline includes "Amusements and Recreations Services" and "Outdoor Amusements" use types; both use types are considered Special Uses under the Community Plan.

Existing Site Conditions: The subject parcel is located at the corner of Incline Way and Southwood Boulevard in the community of Incline Village. According to Washoe County Assessor's records, the existing 16,500 square foot "Bowling Center" was originally constructed in 1966. The 16-lane bowling center includes areas dedicated to billiards, golf simulation, video arcade and food and beverage within the building.

Surrounding Land Uses: The properties in the vicinity are a mix of commercial uses, multi-family residential and the Incline Middle School. The directly adjoining land uses on the two sides of the property are commercial. The property is accessed by an asphalt driveway from SR-28/North Lake Boulevard.

Parcel Zoning and Land Use/ Tahoe Basin Area Plan: The subject parcel is located within the Incline Village Commercial Community Plan, adopted in 1996. In the draft documents for the Washoe County Area Plan, which has been presented to TRPA yet not adopted, no significant zoning changes are proposed that would affect the permissible uses at the property. "Amusements and Recreations Services" and "Outdoor Amusements" use types are considered Special Uses under the Community Plan.

Project Description: The project proposes to renovate and reconfigure the existing Bowl Incline facility, inclusive of the addition of a new outdoor lounge and activity area to improve the year-round vitality of the business. The existing upstairs office space is proposed to be converted a second lounge area and a new entry enclosure is added to the front of the building with bike parking provided at the entry. Along the exterior frontage of the building a new outdoor covered lounge and activity area with perimeter landscaping is proposed. The outdoor area totals approximately 5,100 square feet of space that is considered an "Outdoor Sports and Recreation" use under the TRPA Code. It is forecasted that the additional



lounge and outdoor activity area will generate up to three (3) additional employees from baseline conditions, which are accounted for in the parking demand analysis.

Along with the building renovation the parking area is to be reconfigured, new landscaping incorporated, new signage installed and water quality improvements (BMP's) implemented across the site.

Parking: A Parking Demand Study for the proposed project, dat4ed December 3, 2020, was completed by LSC Transportation Consultants, Inc. LSC evaluated the proposed uses with the Institute of Transportation Engineer's *Trip Generation Manual* (10th Edition, 2020) and *Parking Generation Manual* (5th Edition, 2019). Peak parking demand was analyzed for the two primary use types concluding that the parking demand for the "proposed renovations to the existing building and outdoor recreation area is 60 spaces." A full copy of the report including the Shared Parking Analysis is included with this application.

The existing parking lot is proposed to be reconfigured for more efficient yield and circulation, with the required 60 parking stalls in accordance with the LSC Study attained. Three (3) of the parking stalls are dedicated to employee parking, as they front the dumpster and service area; these stalls will only be utilized at peak demand periods, when use of the dumpsters is not anticipated.

Landscaping: A Planting Plan was prepared by Design Workshop to screen the periphery of the outdoor activity area, as well as the parking lot as viewed from Southwood Boulevard. The plan uses native or adapted species to reduce maintenance and watering requirements. Aumr Maples and Quaking Aspen are specified at the edge of the parking area, with a title of eleven (11) new trees to be planted. A combination of shrubs, perennials and native grasses are utilized in the planting plan. Proposed quantities are listed in a table on the planting plan.

Lighting: All proposed exterior lighting will be shrouded and downlit in accordance with TRPA and Washoe County standards.

Signage: A new freestanding sign is proposed, with the conceptual graphic including within this submittal package.

Other Regulatory Approvals: The proposed project will require Tahoe Regional Planning Agency (TRPA) approval. Based on the use types of "Amusements and Recreations Services" and "Outdoor Amusements" use types, both considered Special Uses under the Incline Village Community Plan, it is anticipated that a Hearings Officer level of review will be required by TRPA.



LSC TRANSPORTATION CONSULTANTS, INC.



2690 Lake Forest Road, Suite C P. O. Box 5875 Tahoe City, CA 96145 (530) 583-4053 FAX (530) 583-5966

Email: lsc@lsctahoe.com Website: www.lsctrans.com

December 3, 2020

Dennis E. Zirbel, Architect 10056 Spring Street P.O. Box 296 Truckee Ca, 96161

RE: Bowl Incline Parking Demand Study

Dear Mr. Zirbel:

Per your request, LSC Transportation Consultants, Inc. has conducted a parking demand analysis for modifications to the Bowl Incline facility located on Southwood Boulevard in Incline Village, Nevada. The project aims to renovate the existing 17,751 square foot bowling alley, adding 1,372 square feet of indoor space within the existing building for lounge space and entry way and to create an additional 5,100 square feet of outdoor entertainment area. While Washoe County parking codes define the parking requirements for indoor recreation, the proposed outdoor component requires a project-specific parking demand study.

Washoe County Development Standards

Per the Washoe County Development Code (Oct 23, 2020), Interpretation 04-1:

"When a commercial development that does not comply with current development standards (nonconforming development) is enlarged by less than fifty (50) percent, or if one allowed use is substituted for another and the structure(s) within the development are not enlarged, the applicant shall demonstrate that current standards, regarding the number of parking spaces for the new or expanded use are complied with. Any new parking spaces or loading areas required shall comply with all current standards, pursuant to Article 410."

As the increase in the proposed project size is 37 percent of the existing bowling alley's floor area, and is not greater than 50 percent, the existing 48 parking spaces can be considered to serve the existing bowling alley. The new outdoor entertainment area would require additional parking spaces to meet Washoe County Code.

Parking Demand of Proposed Project Use

The proposed renovations of the Bowl Incline alley included converting the existing 2nd floor office space to a new bar lounge area, as well expanding the entrance hall. The Institute of Transportation Engineer's *Trip Generation Manual* (10th Editions, 2020) and *Parking Generation Manual* (5th Edition, 2019) include Bowling Alley as a land use (ITE Code: 437). A description of the land use states:

A bowling alley is a recreational facility that includes bowling lanes. A small lounge, restaurant and/or snack bar, video games, and pool tables may also be available.

Since the new lounge is considered an accessory use, and the existing bowling alley already has a bar area, no additional parking spaces are expected to be generated by customers to the expanded lounge area. Though new customers are not expected as a direct result of this conversion, the new space could result in increased number of employees. As a result, additional parking spaces is allotted for the change in employees. See attached Table A.

The 5,100 square foot outdoor recreational area is a combination of a covered bar and lounge area, two bocce ball/ice shuffleboard courts, and playground area. As this combined outdoor space does not have standard parking rate, the ITE land use of Racquet/Tennis Club (ITE code 491) was selected as it has close similarities and a potential land use alternative recommended by Washoe County. This outdoor space will require additional employees; two additional parking spaces are allotted for this use.

Since some of those persons using the new outdoor recreation area will likely be bowling patrons, a 25% internal/captive market reduction was taken for this land use. As a result, a combine 72 parking spaces are need to meet peak demands of each of the induvial land uses at their peak times, as shown in Table A. However, since the different land uses peak at different times a shared parking analysis is performed.

Shared Parking

As outdoor recreation has the greatest use during the day while indoor bowling activity is greatest in the evening, the potential of shared parking between the outdoor recreation area and bowling alley uses exist. An analysis of parking needs for each hour of the day was therefore conducted. Based on the hourly percentages found in the *ITE Parking Generation Manual*, the proportion of parking demand for hour of each individual land use is calculated and summed. The percentages presented in the Parking Generation Manual were adjusted based on hours of operation and user logs supplied by Bowl Incline. These adjustments did not reduce any of the Manual's factors but added parking demand to earlier in the day as shown to occur based on Bowl Inclines records. These proportions are shown in the lower portion of Table B.

The peak period of parking demand is found to occur at 8 PM (when all bowling guest are assumed to be onsite, along with 41% of the outdoor recreation area in use), at 60 parking spaces.

Conclusion

The parking demand of the Bowl Incline including the proposed renovations to the existing building and outdoor recreation area is 60 spaces. This is based on the original parking spaces associated the current bowling alley plus the additional spaces needed for additional employee of the renovated space and new outdoor recreational space.



Please contact Bill Suen, Engineer with any questions regarding this analysis, at 510-673-3043, bill@lsctahoe.com

Respectfully Submitted,

LSC TRANSPORTATION CONSULTANTS, INC.

Gordon R. Shaw, PE, AICP

Project Manager

Table A: Bowl Incline Peak Parking Demand

Description	Quantity	Units	Land Use Category	Parking Rate ¹	Required Parking Spaces for Individual Use	Internal/ Captive Market Reduction	Parking Required with Non-Auto and Captive Market Reductions
Existing Landuse to the Converted							
Bowl Incline			Existing	Parking Spaces	48	0%	48
Additional Indoor Lounge Employees	1	Employees	_	1 per Peak Employee	1	0%	1
Proposed Project							
Outdoor Recreation	5.1	KSF	Racquet/Tennis Club	5.49 per KSF	28	25%	21
Additional Outdoor Lounge Employees	2	Employees	(Land Use 491)	1 per Peak Employee	2	0%	2
Total					76		72

NOTE: KSF = 1,000 square feet

Note 1: Parking Requirements from ITE Parking Generation Manual, 5th Edition

LSC Transportation Consultants, Inc.

TABLE B: Bowl	Incline Shared	l Parkina	Analysis
I ADLL D. DUWI	IIICIIIIE SIIUIEU	PUIKIIIY	Allulysis

Description	Total Required Parking for Individual Land Use	11:00 AM	12:00 PM	1:00 PM	2:00 PM	3:00 PM	4:00 PM	5:00 PM	6:00 PM	7:00 PM	8:00 PM	9:00 PM	10:00 PM	11:00 PM	12:00 AM	Parking Demand During Peak Period
Existing Bowling Alley Outdoor Use Area	48 21	10.0 14.0	9.6 14.7	21.6 18.1	36.0 19.7	9.6 21.0	4.8 21.0	21.6 18.7	41.8 13.7	47.5 8.6	48.0 8.6	48.0 4.2	48.0 2.1	9.6 0.0	2.4 0.0	48 9
Additional Lounge Employees	3	3.0	3.0	3.0	3.0	3.0	3.0	3.0	3.0	3.0	3.0	3.0	3.0	1.0	1.0	3
TOTAL PROPOSED PROJECT	69	27	28	43	59	34	29	44	59	60	60	56	54	11	4	60

Shared Parking Fact	ors P	ercent c	of Peak	Parkin	g Dema	nd by H	our							
	11.00	12.00	1.00	2.00	3.00	4.00	5.00	6.00	7.00	8.00	9.00	10.00	11.00	12.00
Land Use	AM	PM	PM	PM	PM	PM	PM	PM	PM	PM	PM	PM	PM	AM
Bowling ¹	20%	20%	45%	75%	20%	10%	45%	87%	99%	100%	100%	100%	20%	5%
Outdoor Use Area ²	64%	70%	86%	94%	100%	100%	89%	65%	41%	41%	20%	10%	0%	0%

Note 1: Source - ITE Parking Generation, 5th Edition, 2019. Adjusted for hours of operation and Bowl Incline Use logs.

Source: LSC Transportation Consultants, Inc.

Note 2: Source - ITE Parking Generation, 5th Edition, 2019, for Racquet/Tennis Club (Land Use 491)

APN: 132-232-08 R.P.T.T.: \$13,735.00

Escrow No.: 20007725A-COM

When Recorded Return to: 920 Southwood Blvd LLC

985 Fairway Blvd #4336 Incline Village, NV 8945

Mail Tax Statements to: 920 Southwood Blvd LLC SAME AS ABOVE DOC #5101770

11/09/2020 04:42:56 PM Electronic Recording Requested By FIRST CENTENNIAL - RENO (MAIN OF Washoe County Recorder

Kalie M. Work

Fee: \$43.00 RPTT: \$13735.00

Page 1 of 3

SPACE ABOVE FOR RECORDER'S USE

GRANT, BARGAIN, SALE DEED

FOR VALUABLE CONSIDERATION, receipt of which is hereby acknowledged,

Waldman Investments, Inc., a Nevada corporation

do(es) hereby Grant, Bargain, Sell and Convey to

920 Southwood Blvd LLC, a Nevada limited liability company

all that real property situated in the City of Incline Village, County of Washoe, State of Nevada, described as follows:

SEE LEGAL DESCRIPTION ATTACHED HERETO AND MADE A PART HEREOF AS EXHIBIT "A"

Together with all and singular tenements, hereditaments and appurtenances thereunto belonging or in anywise appertaining.

5101770 Page 2 of 3 - 11/09/2020 04:42:56 PM

Page 2 of the Grant, Bargain, Sale Deed (signature pag	e). Escrow No.: 20007725A-COM
Dated this 6 th day of Harmber	<u>,</u> 2020.
Waldman Investments Inc., a Nevada corporation	
BY: Curt H. Wegener, President	
STATE OF NEVADA	
COUNTY OF Washe	
This instrument was acknowledged before me on this Waldman Investments Inc.	6 day of Northen ber , 2008, by of
Notary Public	


Notary Public - State of Nevada
Appointment Recorded in Washes County
Not 20-0245-02 - Expires March 25, 2024

5101770 Page 3 of 3 - 11/09/2020 04:42:56 PM

EXHIBIT A

Lots 8 and 9, in Block D, as shown on the map of COMMERCIAL SUB, NO. 1, filed in the office of the County Recorder of Washoe County, Nevada, on March 2, 1965, as Tract Map No. 942.

Assessors Parcel No.: 132-232-08

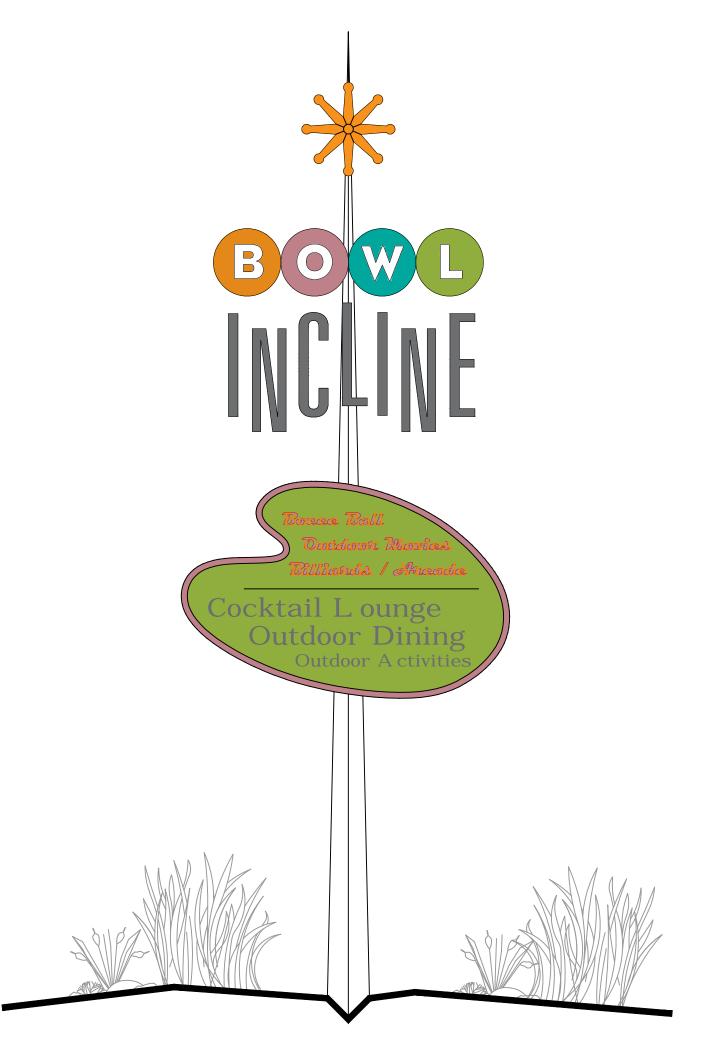

BOWL INCLINE - RENOVATION / REMODEL

920 SOUTHWOOD BOULEVARD, INCLINE VILLAGE, WASHOE COUNTY, NEVADA

review at least two weeks prior to ordering materials or product. Provide

Construction Schedule Lighting Fixtures & controls Plumbing Schematic Mechanical Equipment Submittals Fireplace Shop Drawings with flues Windows Shop Drawings Any Metal Fabrications Shop Drawings Roofing Material Samples Specialty Sheet Metal Items Shop Cabinets/Built-ins Shop Drawings

Plaster & Druwall Finish Sample Tile Mock-up

Exterior Millwork Sample/Details Appliance cut sheets Waterproofing at retaining walls Gutters, Downspouts and Snow Fences Kitchen Hood / Ventilation Paver samples Landscape planting 4 irrigation submittal Maintenance Schedule for all finishes/appliances Civil Engineering Submittals - Including sewer

Construction Waste Management F All arill work Submittals Electrical Wiring / Circuit Submittals Masonry & Stone Samples & Mock-ups Carpet & Flooring Samples Pond /Creek Design and Submitta

SCOPE OF WORK

Interior Millwork Samples

Insulation

The work required to be performed by the contractor consists of constructing and completing the 'Project', as defined in the General Conditions, or Title, in accordance with the Drawings, Specifications and all applicable provisions of the Contract Documents. The work includes furnishing all plant, labor, tools, equipment, appliances, materials, transportation and services and in performing all operations necessary for the property incidental to the construction as proper completion of the Project as shown and noted on the drawings. All layouts shall be submitted to the Architect for review and approval prior to construction or installation. All submittals and installations hall be in accordance with the current building codes, A.D.A., Model Energy Code and all current state and local codes and ordinances.

GENERAL DEFENSIBLE <u>SPACE GUIDELINES:</u>

- ALL DEAD TREES, BRUSH AND OTHER VEGETATION MUST BE REMOVED. LL RESIDUAL TREES WILL BE LIMBED TO A HEIGHT OF 10 FEET FROM THE GROUND NOT TO EXCEED 1/3 OF THE TOTAL TREE HEIGHT. ALL RESIDUAL TREES WILL BE LIMBED TO ACHIEVE IØ FEET OF CLEARANCE FROM ANY PART OF THE HOUSE TO THE BRANCHES OF T TREE. IF THIS WOULD REQUIRE REMOVAL OF THE CROWN EXCEEDING THE LOWER 1/3 OF THE TREES HEIGHT THEN THE TREE SHOULD BE
- THE AREA WITHIN 5 FEET OF THE FOUNDATION AND SUPPORT POSTS SHOULD NOT CONTAIN ANY COMBUSTIBLE PLANT MATERIALS. WITHIN 30 FEET OF THE STRUCTURE THERE SHOULD ONLY BE SINGLE SPECIMENS OF WELL MAINTAINED AND WELL IRRIGATED SHRUBS OR TREES. SUCH MATERIAL SHOULD NOT BE CAPABLE OF READILY TRANSMITTING FIRE TO THE STRUCTURE. COMBUSTIBLE MULCHES OR PINE NEEDLES SHOULD NOT BE USED AS A GROUND COVER WITHIN TH
- ALL BRUSH, TREES OR FLAMMABLE MATERIAL WILL BE REMOVED FRO UNDER THE DRIP LINE OF RESIDUAL TREES OR TREE GROUPS. TREE CANOPIES WILL BE SPACED AT LEAST 10 FEET APART. IF TREES ARE GROUPED CLOSE ENOUGH TOGETHER AS TO ACT AS ONE UNIT,
- THEN ALL OTHER REQUIREMENTS MUST BE MET. BEYOND 30 FEET FROM THE HOME, BRUSH FIELDS MUST BE SPACED A DISTANCE EQUAL OR GREATER THAN 2 TIMES THE HEIGHT OF THE BRUSH. INDIVIDUAL BRUSH PLANTS WILL NOT EXCEED 100 SQUARE
- SEE ARBORIST REPORT FOR ADDITIONAL INFORMATION. Ø. GENERAL CONTRACTOR TO COMPLETE DEFENSIBLE SPACE AS

BUILDING DESIGN CRITERIA

2018 International Building Code (IBC) 2018 Uniform Plumbing Code (UPC) 2018 Uniform Mechanical Code (UMC. 2017 National Electrical Code (NEC) 2018 International Energy Conservation Code (IECC) 2018 International Fire Code (IFC) 2018 International Urban Wildfire Interface Fire Code (IWUIC)

2018 Northern Nevada amendments by(NVCICC), and

Any other jurisdiction amendments

OCCUPANCY GROUP V-B (AUTOMATIC FIRE SPRINKLER SYSTEM) CONSTRUCTION TYPE: GROUND SNOW LOAD: 190 PSF (6,300' ELEVATION) ROOF LIVE LOAD (Pf): 133 PSF 120 MPH - EXPOSURE C

BASIC WIND SPEED: SEISMIC DESIGN CATEGORY: [FLOOR LIVE LOAD: FLOOD ZONE: NONE

BUILDING CODES:

- MAINTAIN EXISTING VEGETATION, DISTURB ONLY THE MINIMUM AMOUNT PLAN. NO ACTIVITY IS TO TAKE PLACE IN AREAS OF THE SITE OTHER THAN THE CONSTRUCTION ACTIVITY ZONE. CONTRACTOR TO SET NEW DATUM ${\it o}$ BUILDING ENTRY PRIOR TO
- ALL DISTURBED AREAS TO BE RE-VEGETATED WITH SCHAFFER'S MILL APPROVED FOREST UNDERSTORY SEED MIXTURE AND ALL AREAS OF EXPOSED SOIL WILL BE STABILIZED WITH PINE STRAW OR MUCLH PRIOR TO SUBMITTING FOR FINAL RELEASE

1. Contractor to adhere to all "TRPA" conditions of approval, constraints and guidelines, including attachment R. Site to be winterized per TRPA requirements by October 15th. 2. All grading except for driveway grading to the side setback must be performed within the setbacks, unless shown otherwise. Verify driveway grades and estimate edge of pavement prior to construction. 3. See landscape plan for additional information. All landscaping shall conform to the requirements for sizes and species identified in Chapter 30 of the TRPA Code of Ordinances. Fertilizer use in the backshore and shorezone area shall not be used except as outlined in TRPA Code of Ordinances section 81.7.4. 4. All barren and disturbed areas caused by construction shall be re-vegetated per TRPA <u>Handbook of Best</u> <u>Management Practices</u> and <u>Living with Fire</u>, Lake Tahoe Basin. Second Edition. 5. Maintain existing vegetation disturb only the minimum amount of area around the building footprint. No grading excavation shall be permitted except as shown on the plans. Excavation equipment shall be limited to the Enumer of the permitted except as shown on the plans, excavation equipment shall be limited to the foundation footbrint to minimize site disturbance. No grading or excavation shall be permitted outside of the building footbrint.

6. Contractor shall ensure that all trees adjacent to the construction site be fenced and protected with substantial wood fencing. Protect all existing trees to remain inside the construction activity zone with vertical 2) strapped around trees with wood pallets on ground over dripline.

Contractor shall ensure that nothing will be attached to trees.

8. Contractor shall ensure that all grading and trenching shall be located in such a way that trees and tree root systems will not be damaged. Hand dig around all tree roots encountered. 9. No excess soil to be retained on site. All soil removed during excavation to be reused as backfill. All cut material must be disposed of in a TRPA approved location. Verify compaction of soil with geotechnical engineer prior to backfilling. No fills or re-contouring, other than backfill for structures shall be allowed. All temporary soil stockpiles shall be appropriately covered with tarps and contained by temporary erosion control fences and/or coir logs with gravel bags. Ø. All Existing trees and shrubs on the lakeward side of this parcel shall be considered as scenic mitigatio These trees and shrubs shall not be removed or trimmed for view enhancement purposes without prior written TRPA approval, Any such removal or trimming shall constitute a violation of project approval. Temporary Best Management Practices (BMP's) are to be installed and maintained prior to excavation and during all phases of the

- II. All employee vehicles shall be parked on existing paved surfaces or existing compacted road shoulders only. 12. Any normal construction activities creating noise in excess of TRPA noise standards shall be considered exempt from said standards provided all work is conducted between the hours of 8:00am and 6:30pm. 13. Contractor to keep Dust Control Measures in place during construction. Broadcast mulch shall not be permitted as a dust control measure within 35 feet of structures.
- 14. Prior to release of security, photos shall be provided to TRPA taken during the construction of any subsurface BMP's or of any trenching and backfilling with gravel. 16. All exterior lighting shall be consistent with TRPA Code of Ordinances Section 36.8 Exterior Lighting standards. Specifically, all exterior lighting shall be fully shielded and directed downward so as not to produce obtrusive glare onto public right-of-way or adjoining properties. Illumination for aesthetic or dramatic purposes of any building or surrounding landscape utilizing exterior light fixtures projected above the horizontal is prohibited.

17. All Best Management Practices (BMP's) shall be maintained in perpetuity to ensure effectiveness which may require BMP's to be periodically reinstalled or replaced.

GENERAL PROJECT NOTES

- The Contractor agrees that he shall assume sole and complete responsibility for job site conditions during the course of construction of this project, including safety of all persons and property that this requirement shall apply continuously and not be limited to the normal working hours and that the Contractor shall defend, indemnify, and hold the Owner, Architect and Engineer harmless from any liability, real or alleged, in connection with the performance of work on this
- All elevations are based on existing site data. The Contractor, Owner and Architect to review drainage, building elevations and grading prior to start of construction.
- The Contractor shall be responsible for adequate temporary drainage facilities during the rainy season operation and protect all disturbed areas from erosion. He shall repair any areas of erosion prior to acceptance of grading. contact USA to locate underground utilities prior to digging.
- markers destroyed during construction shall be replaced at Contractor's expense. Contractor shall set a finish floor
- The Architect assumes no responsibilities for any changes, omissions, errors or deviations by the Owner or Contractor either accidental or intentional. Contractor to ask, in writing, any and all questions with regards to intent or interpretation of drawings and specifications prior to submitting bids and starting work. The submittal of a bid or starting work by any contractor shall be considered as his acknowledgment of his responsibility for the requirements of all sections and trades of this project (ie: civil, architectural, electrical, mechanical, structural, landscaping). The contractor shall review all project drawings and requirements prior to bid or starting work and include the cost of all materials, labor and work required to satisfy the requirements of all trades, even if these items are not addressed by the specifications or shown
- Temporary utilities and services shall be installed and maintained in accordance with local codes and regulations. These utilities and services shall not unduly infringe upon the area's natural elements such as trees, rocks, shrubs, etc. Temporary hookups such as lights and power shall have their own temporary poles and shall not utilize trees or other natural
- Temporary Best Management Practices (BMP's) are to be installed and maintained prior to excavation and during all phases of the proposed project. Removal of temporary facilities shall occur as progress of work permits and not later
- 10. Adequate measures shall be taken to protect areas outside the immediate construction zone and shall be strictly observed: a.) These areas shall include trees or groups of trees adjacent to the construction zone and shall be fenced off to insure their protection. b.) Adjacent property shall be respected and adequately protected. If it should become necessary to use the adjacent property for any reason, the reason shall be specified and written permission shall be obtained from the respective owner (s). c.) Any areas outside the construction zone affected by the construction shall
- Any material from clearing and excavation which is unsuitable for fill or landscaping shall be removed from the site.
- Back filling of trenches, foundation and other excavation shall be done in such a manner as to not disrupt natural site conditions, drainage, ground cover, etc.
- B. The Contractor shall call the Architect 48 hours prior to placing concrete in footing for steel review. Contractor is to
- f. The General Contractor is to notify the interior designer and the Architect prior to the placing and installations of all
- . Complete clean-up of the construction site and all areas outside the construction site shall be an integral part of the
- 6. Contractor shall develop and implement a Construction Waste Management Plan so that materials are recycled and/or salvaged to a minimum of 50% of non-hazardous construction and Jemolition debris per U.S. Green Building Council "MR
- 17. The Contractor is permitted one sign stating his firm and subcontractors per local regulations, verify.
- All work and materials shall conform to the latest edition of the International Residential Code and all other applicable local codes and ordinances.
- a. Structural engineering by "Richard Chesbro Engineering" shall be an integral and legally binding portion of these
- 20. Contractor shall install all utilities as per Utility and Washoe County building department requirements.
- Re-vegetate / Landscape all disturbed areas per TRPA / Washoe County standards and permit.
- 23. Temporary and permanent BMP's may be field fit by the Environmental Compliance Inspector where appropriate. 24. All Best Management Practices shall be maintained in perpetuity to ensure effectiveness which may require BMP's to be periodically reinstalled or replaced.
- 25. This site shall be winterized in accordance with the provisions of Attachment R by October 15th of each construction
- 26. Contractor to provide weekly updates to Owner and Architect with detailed photos of progress.
- 17. The General Contractor is responsible for insuring that the project, as-built, does not exceed the approved land coverage figures shown on the Site Plan. The approved land coverage figures shall supersede scaled drawings when
- 28. Geotech reports shall be an integral part of these construction documents.

- project, except for liability arising from the sole negligence of the Owner, Architect or the Engineer.
- The Contractor shall expose all existing utility lines or other underground facilities at proposed crossings or connection points to verify location and elevation. Backfill shall be included in the price for various items of work Contractor shall
- The Contractor is responsible for the protection of all existing monuments or other survey markers. All such monuments or
- . It is the Contractor's responsibility to notify the Architect immediately upon any existing conditions that will reflect in changes from the construction drawings. Contractor shall verify all dimensions prior to construction.

- notify the Architect on any deviation of plans or specifications.
- lighting fixtures, interior finishes, căbinets, etc. and sübmit samples to the designer and Architect for approval.
- work. No trash shall be allowed to accumulate during construction and shall be removed at least on a weekly basis.

- 22. General Contractor to provide general requirements per outline specifications.

DESIGN TEAM


ARCHITECT	PLANNER
Dennis Zirbel DENNIS E. ZIRBEL ARCHITECT A PROFESSIONAL CORPORATION P.O. Box 296 Truckee, CA 96160 Telephone: 530.582.8979 Fax: 530.582.8938	Ogilvy Consulting / Land Use & Development Strategies Post Office Box 6315 Tahoe City, CA 96145 Telephone: (530) 583-5800
STRUCTURAL ENGINEER	SURVEYOR
Richard Chesbro Richard Chesbro Engineering 236 Public Square Suite #101 Franklin TN 37064 Telephone: (530) 587-0129	MAPCA Surveys, Inc. 580 Mount Rose Street Reno, NV 89509 Telephone: (775) 432-2067 Fax: (775) 432-2068
CIVIL ENGINEER	MECHANICAL / ELECTRICAL
Brian Clark High Sierra Civil Engineering 15472 Archery View Truckee, CA 96161 Telephone: (530) 414-5026	MSA Engineering Consultants 4599 Longley Lane Reno, NV 89502 (775) 828-4889

FOOD SERVICE LANDSCAPE DESIGN Vern Martin

Vern Martin Design Associates 760 Robin Street Reno, NV 89509 (775) 240-2637

DESIGNWORKSHOP 128 Market Street, Suite 3E Stateline, NV 89449-5666 (775) 588-5929

EXTERIOR ELEVATION

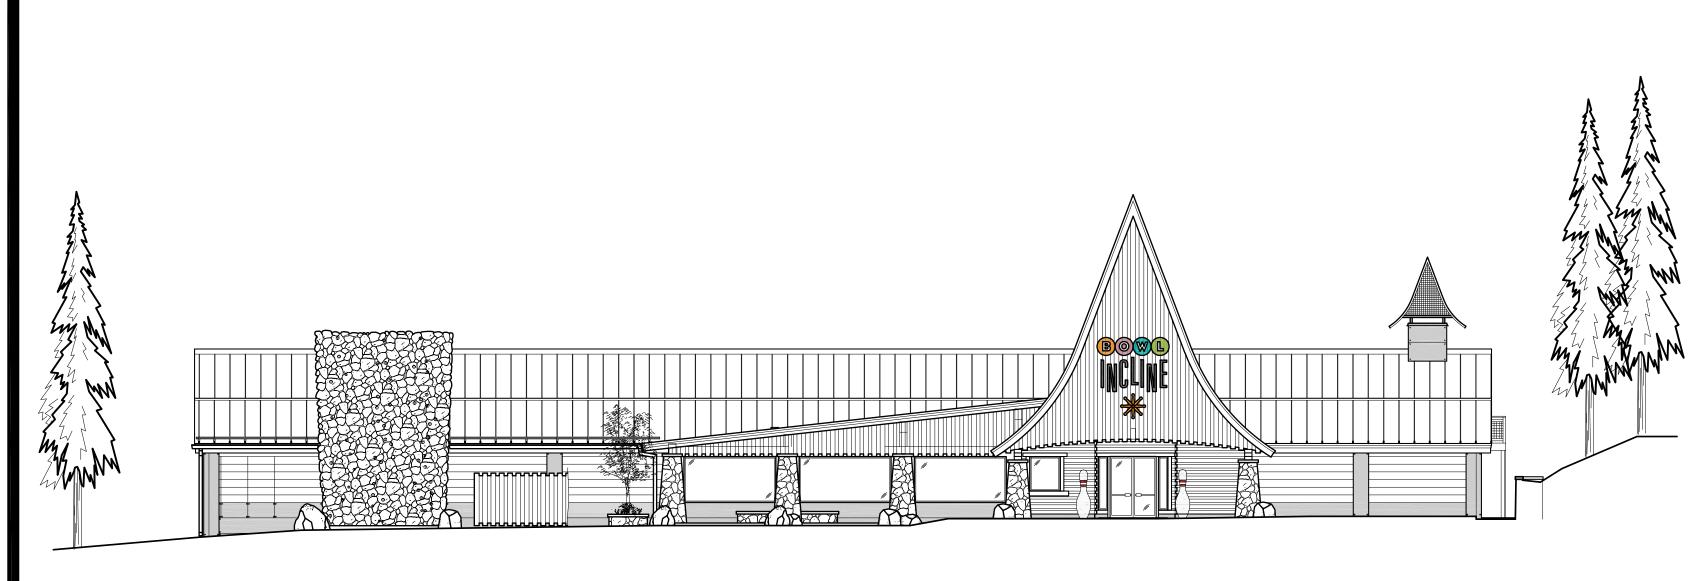

EAST ELEVATION

PERMIT NOTES VICINITY MAP

<u>Fabricator Approval Note:</u> Approval shall be based upon review of the fabricator's written procedural and quality control manuals and periodic auditing of abrication practices by an approved special inspection agency. t completion of fabrication, the approved fabricator shall submit a certificate of compliance to the building official stating that

the work was performed in accordance with the approved

onstruction documents.'

TAHOE BOULEVARD - HIGHWAY 28 VICINITY MAP

BMP CALCULATIONS

REVISIONS

AB-3 AS-BUILT UPPER LEVEL FLOOR PLAN AB-4 AS-BUILT EXTERIOR ELEVATIONS OTHER DRAWINGS

ARCHITECTURAL DRAWINGS:

ARCHITECTURAL SITE PLAN

ENTRY LEVEL FLOOR PLAN

UPPER LEVEL FLOOR PLAN

EXTERIOR ELEVATIONS

<u>ELECTRICAL DRAWINGS</u>

PROPOSED SITE PLAN

EROSION CONTROL DETAILS

<u>Landscape drawings</u>

E3.1 FIRST FLOOR PLAN - POWER AND SIGNAL

E1.1PH SITE PHOTOMETRICS

CIVIL DRAWINGS

SITE PLAN

SITE DETAILS

PLANTING PLAN

IRRIGATION PLAN IRRIGATION DETAILS IRRIGATION DETAILS

IRRIGATION DETAILS

AS-BUILT DRAWINGS

AB-2 AS-BUILT ENTRY LEVEL FLOOR PLAN

E1.1 ELECTRICAL SYMBOL LIST AND DRAWING INDEX

EXTERIOR ELEVATIONS

A-4

SHEET INDEX

TOPOGRAPHIC SURVEY

THESE DRAWINGS ARE INSTRUMENTS OF SERVICE AND ARE PROPERTY OF DENNIS E. ZIRBEL, ARCHITECT PROFESSIONAL CORPORATION. ALL DESIGNS AND OTHER INFORMATION ON THE DRAWINGS ARE FOR USE ON ' SPECIFIED PROJECT AND SHALL NOT BE COPIED OR USED OTHERWISE WITHOUT THE WRITTEN PERMISSION OF DENNIS E. ZIRBEL, ARCHITECT. WRITTEN DIMENSIONS ON THESE DRAWINGS SHALL HAVE PRECEDENCE OVER SCALED DIMENSIONS. CONTRACTORS SHALL VERIFY AND BE RESPONSIBLE FOR ALL DIMENSIONS AND CONDITIONS ON THE JOB. THIS OFFICE SHALL BE NOTIFIED AS TO ANY VARIATION FROM THE DIMENSIONS AND CONDITIONS SHOWN BY THESE DRAWINGS. @

12/8/2020


NOTE

- THERE ARE NO POTENTIAL HAZARDS.
 THERE ARE NO ACTIVE FAULT ZONES.
- THIS PROJECT SHALL COMPLY WITH ALL
 APPLICABLE PROVISIONS OF THE WASHOE
- APPLICABLE PROVISIONS OF THE WASHOE
 COUNTY DEVELOPMENT CODE.

 THERE ARE NO SIGNIFICANT HYDROLOGICAL
- THERE ARE NO FLOOD HAZARDS.

RESOURCES.

- AN APPROVED BACKFLOW PREVENTION
 DEVICE SHALL BE REQUIRED ON ALL
 LANDSCAPE IRRIGATION SYSTEMS.
- SEE FLOOR PLANS, CIVIL, AND LANDSCAPE PLANS FOR ADDITIONAL INFO.

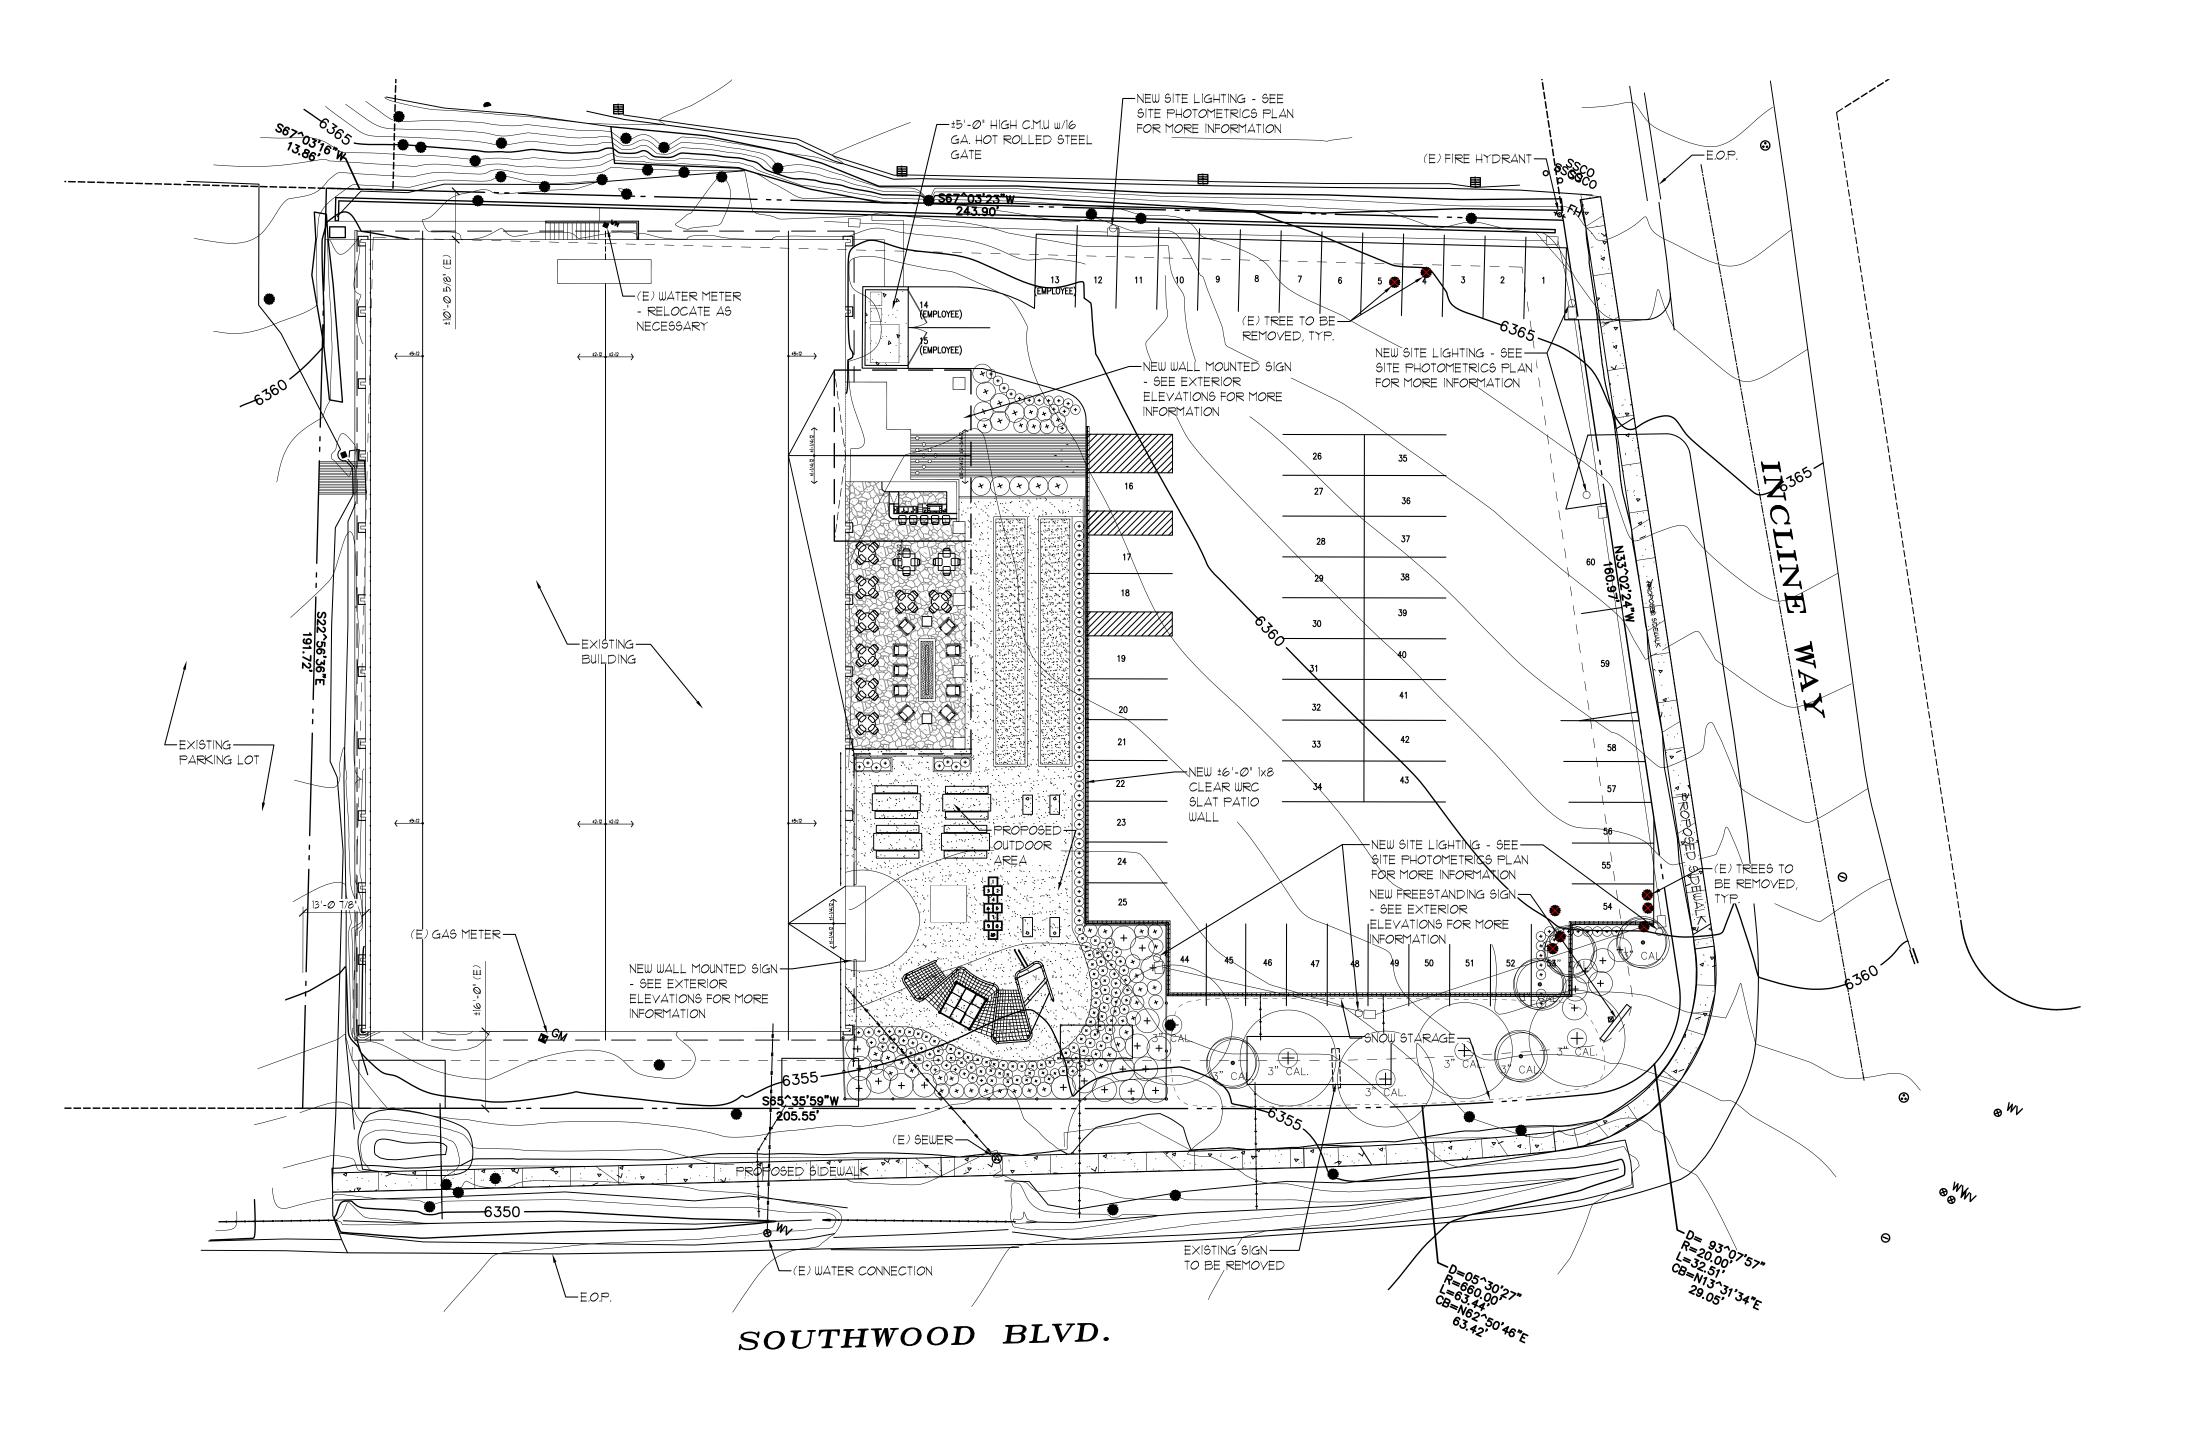



ARCHITECTURAL SITE PLAN

REVISIONS

BOWL INCLINE

RENOVATION/REMODEL

920 Southwood Boulevard Incline Village Washoe County, Nevada


DENNIS E. ZIRBEL


ARCHITECT
A PROFESSIONAL CORPORATION
P.O. Box 296 Truckee, CA 96160
Telephone: 530.582.8979
Fax: 530.582.8938
www.zirbelarchitect.com

A-1

DRAWN:	DE/YM	
DATE:	12/8/2020	
SCALE:	1"=20'-0"	
OB No. :	2Ø17	


THESE DRAWINGS ARE INSTRUMENTS OF SERVICE AND ARE PROPERTY OF DENNIS E. ZIRBEL, ARCHITECT A PROFESSIONAL CORPORATION. ALL DESIGNS AND OTHER INFORMATION ON THE DRAWINGS ARE FOR USE ON THE SPECIFIED PROJECT AND SHALL NOT BE COPIED OR USED OTHERWISE WITHOUT THE WRITTEN PERMISSION OF DENNIS E. ZIRBEL, ARCHITECT. WRITTEN DIMENSIONS ON THESE DRAWINGS SHALL HAVE PRECEDENCE OVER SCALED DIMENSIONS. CONTRACTORS SHALL VERIFY AND BE RESPONSIBLE FOR ALL DIMENSIONS AND CONDITIONS ON THE JOB. THIS OFFICE SHALL BE NOTIFIED AS TO ANY VARIATION FROM THE DIMENSIONS AND CONDITIONS SHOWN BY THESE DRAWINGS. ©

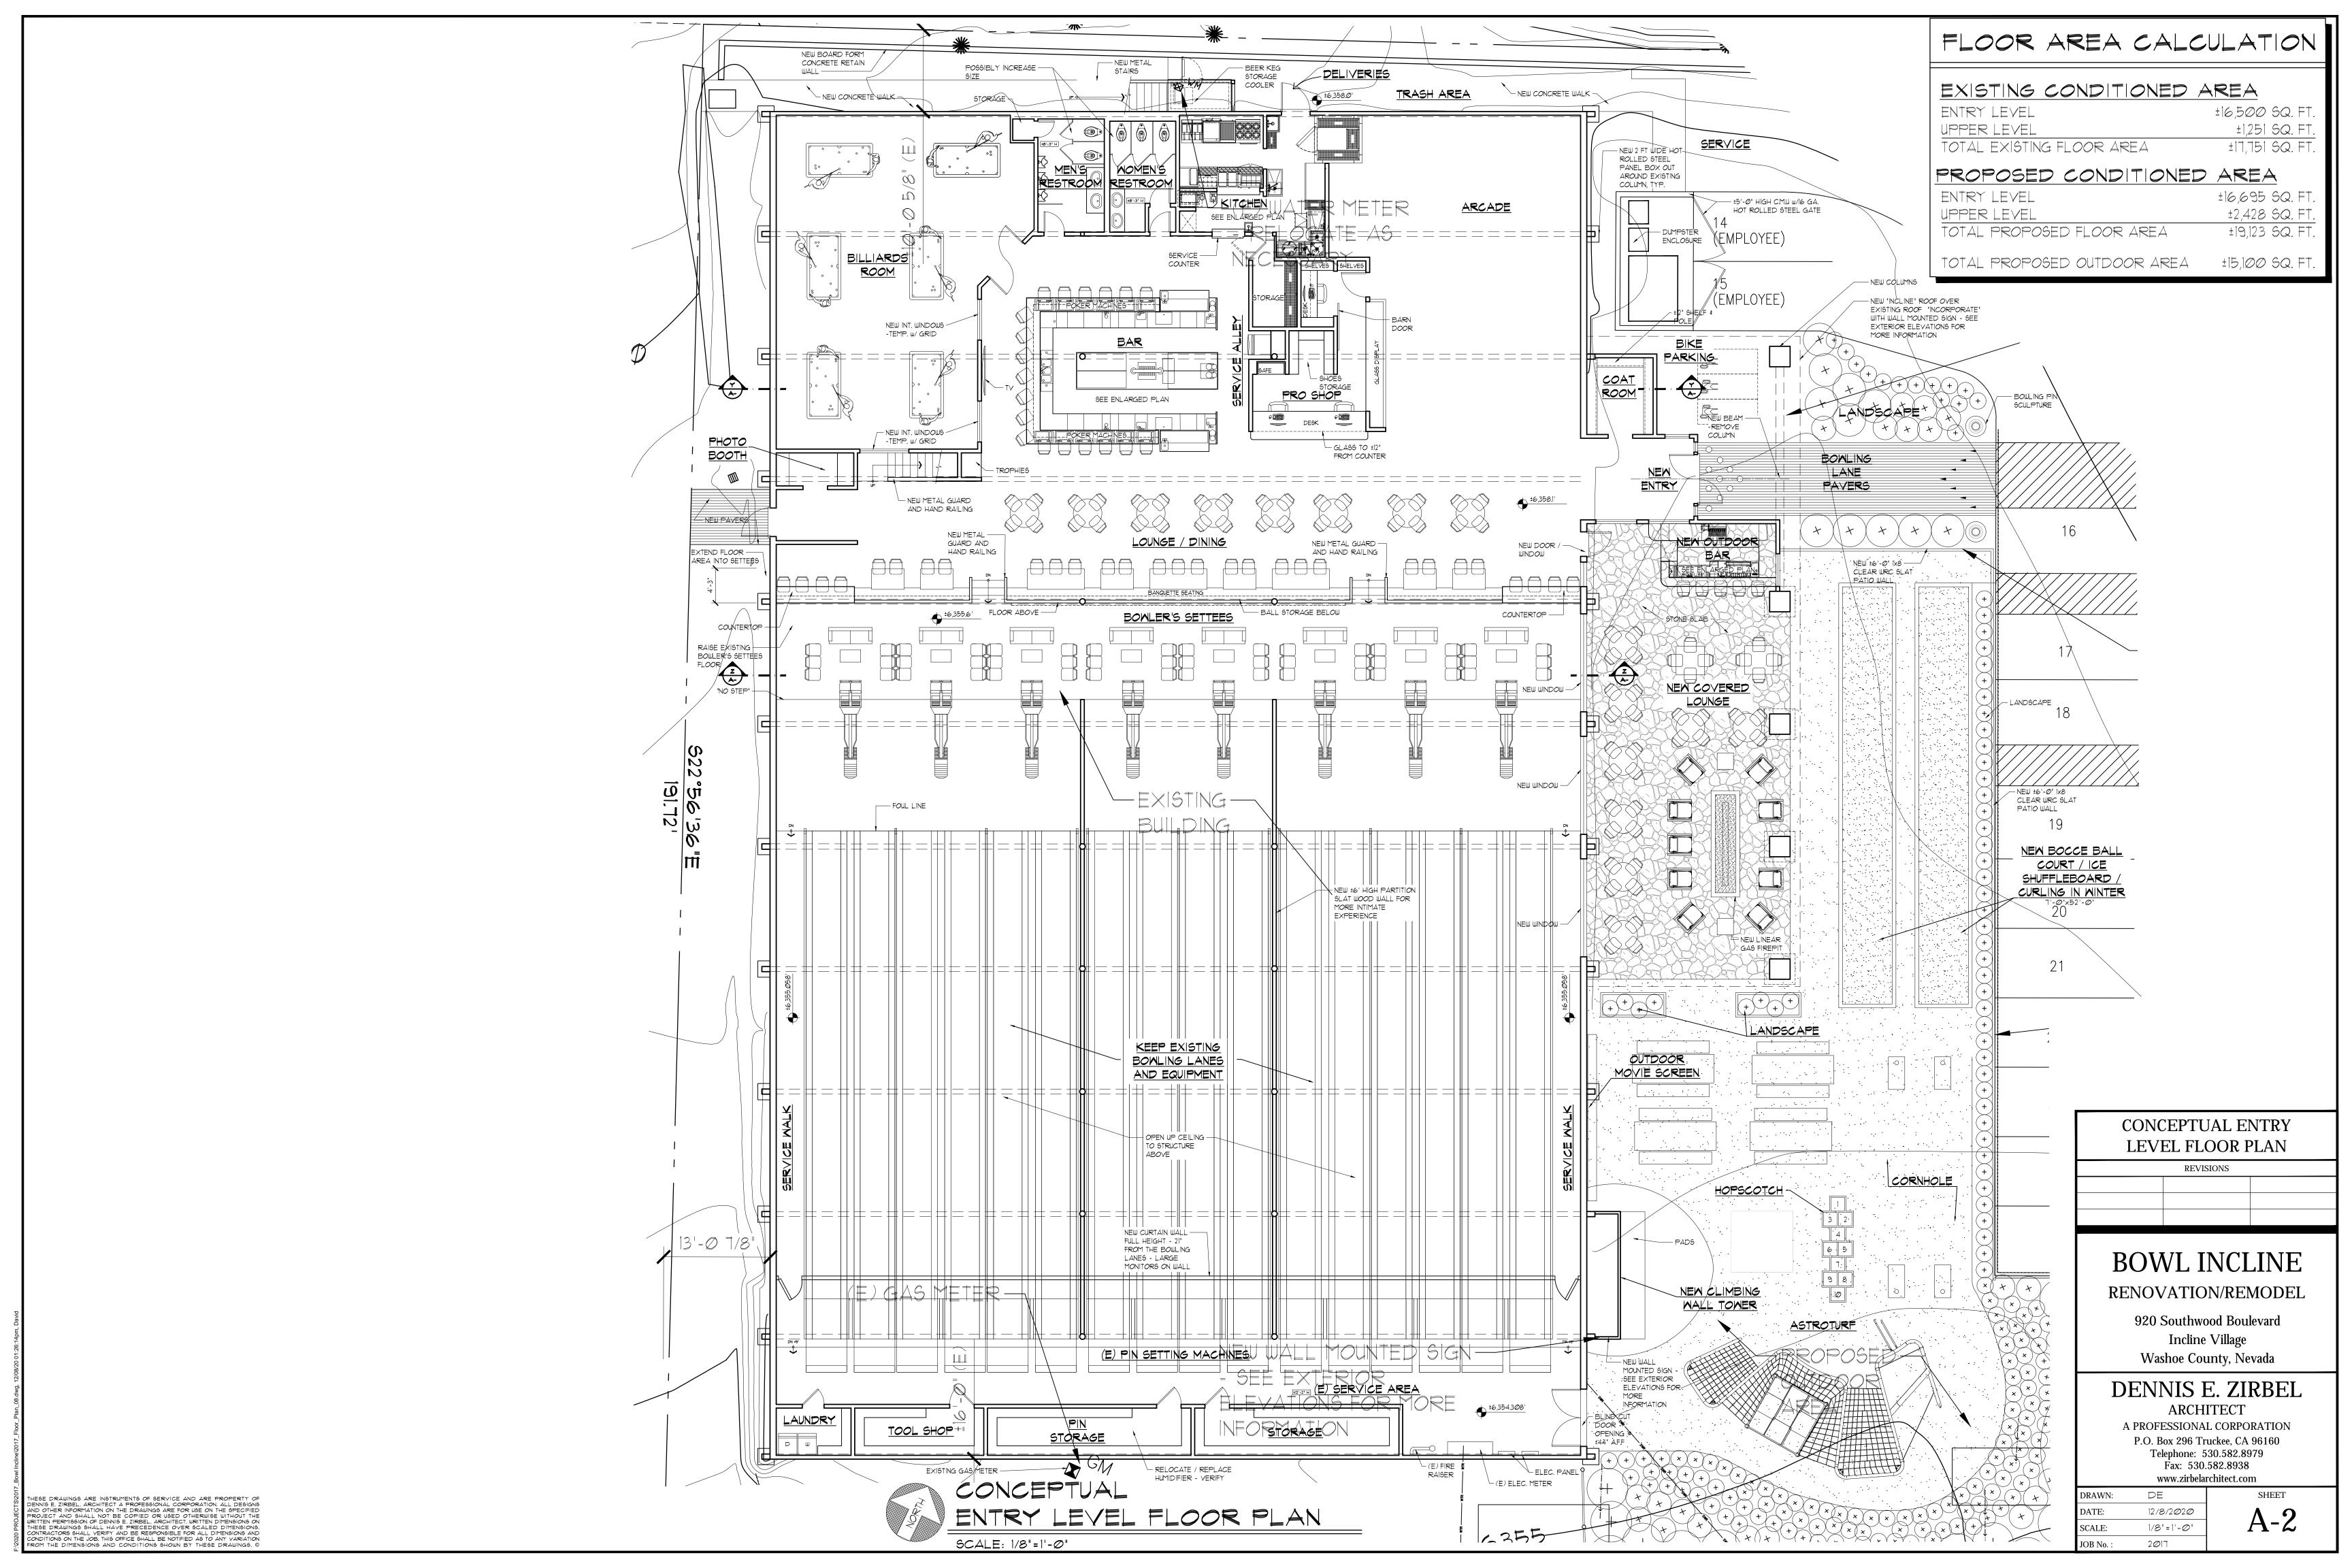

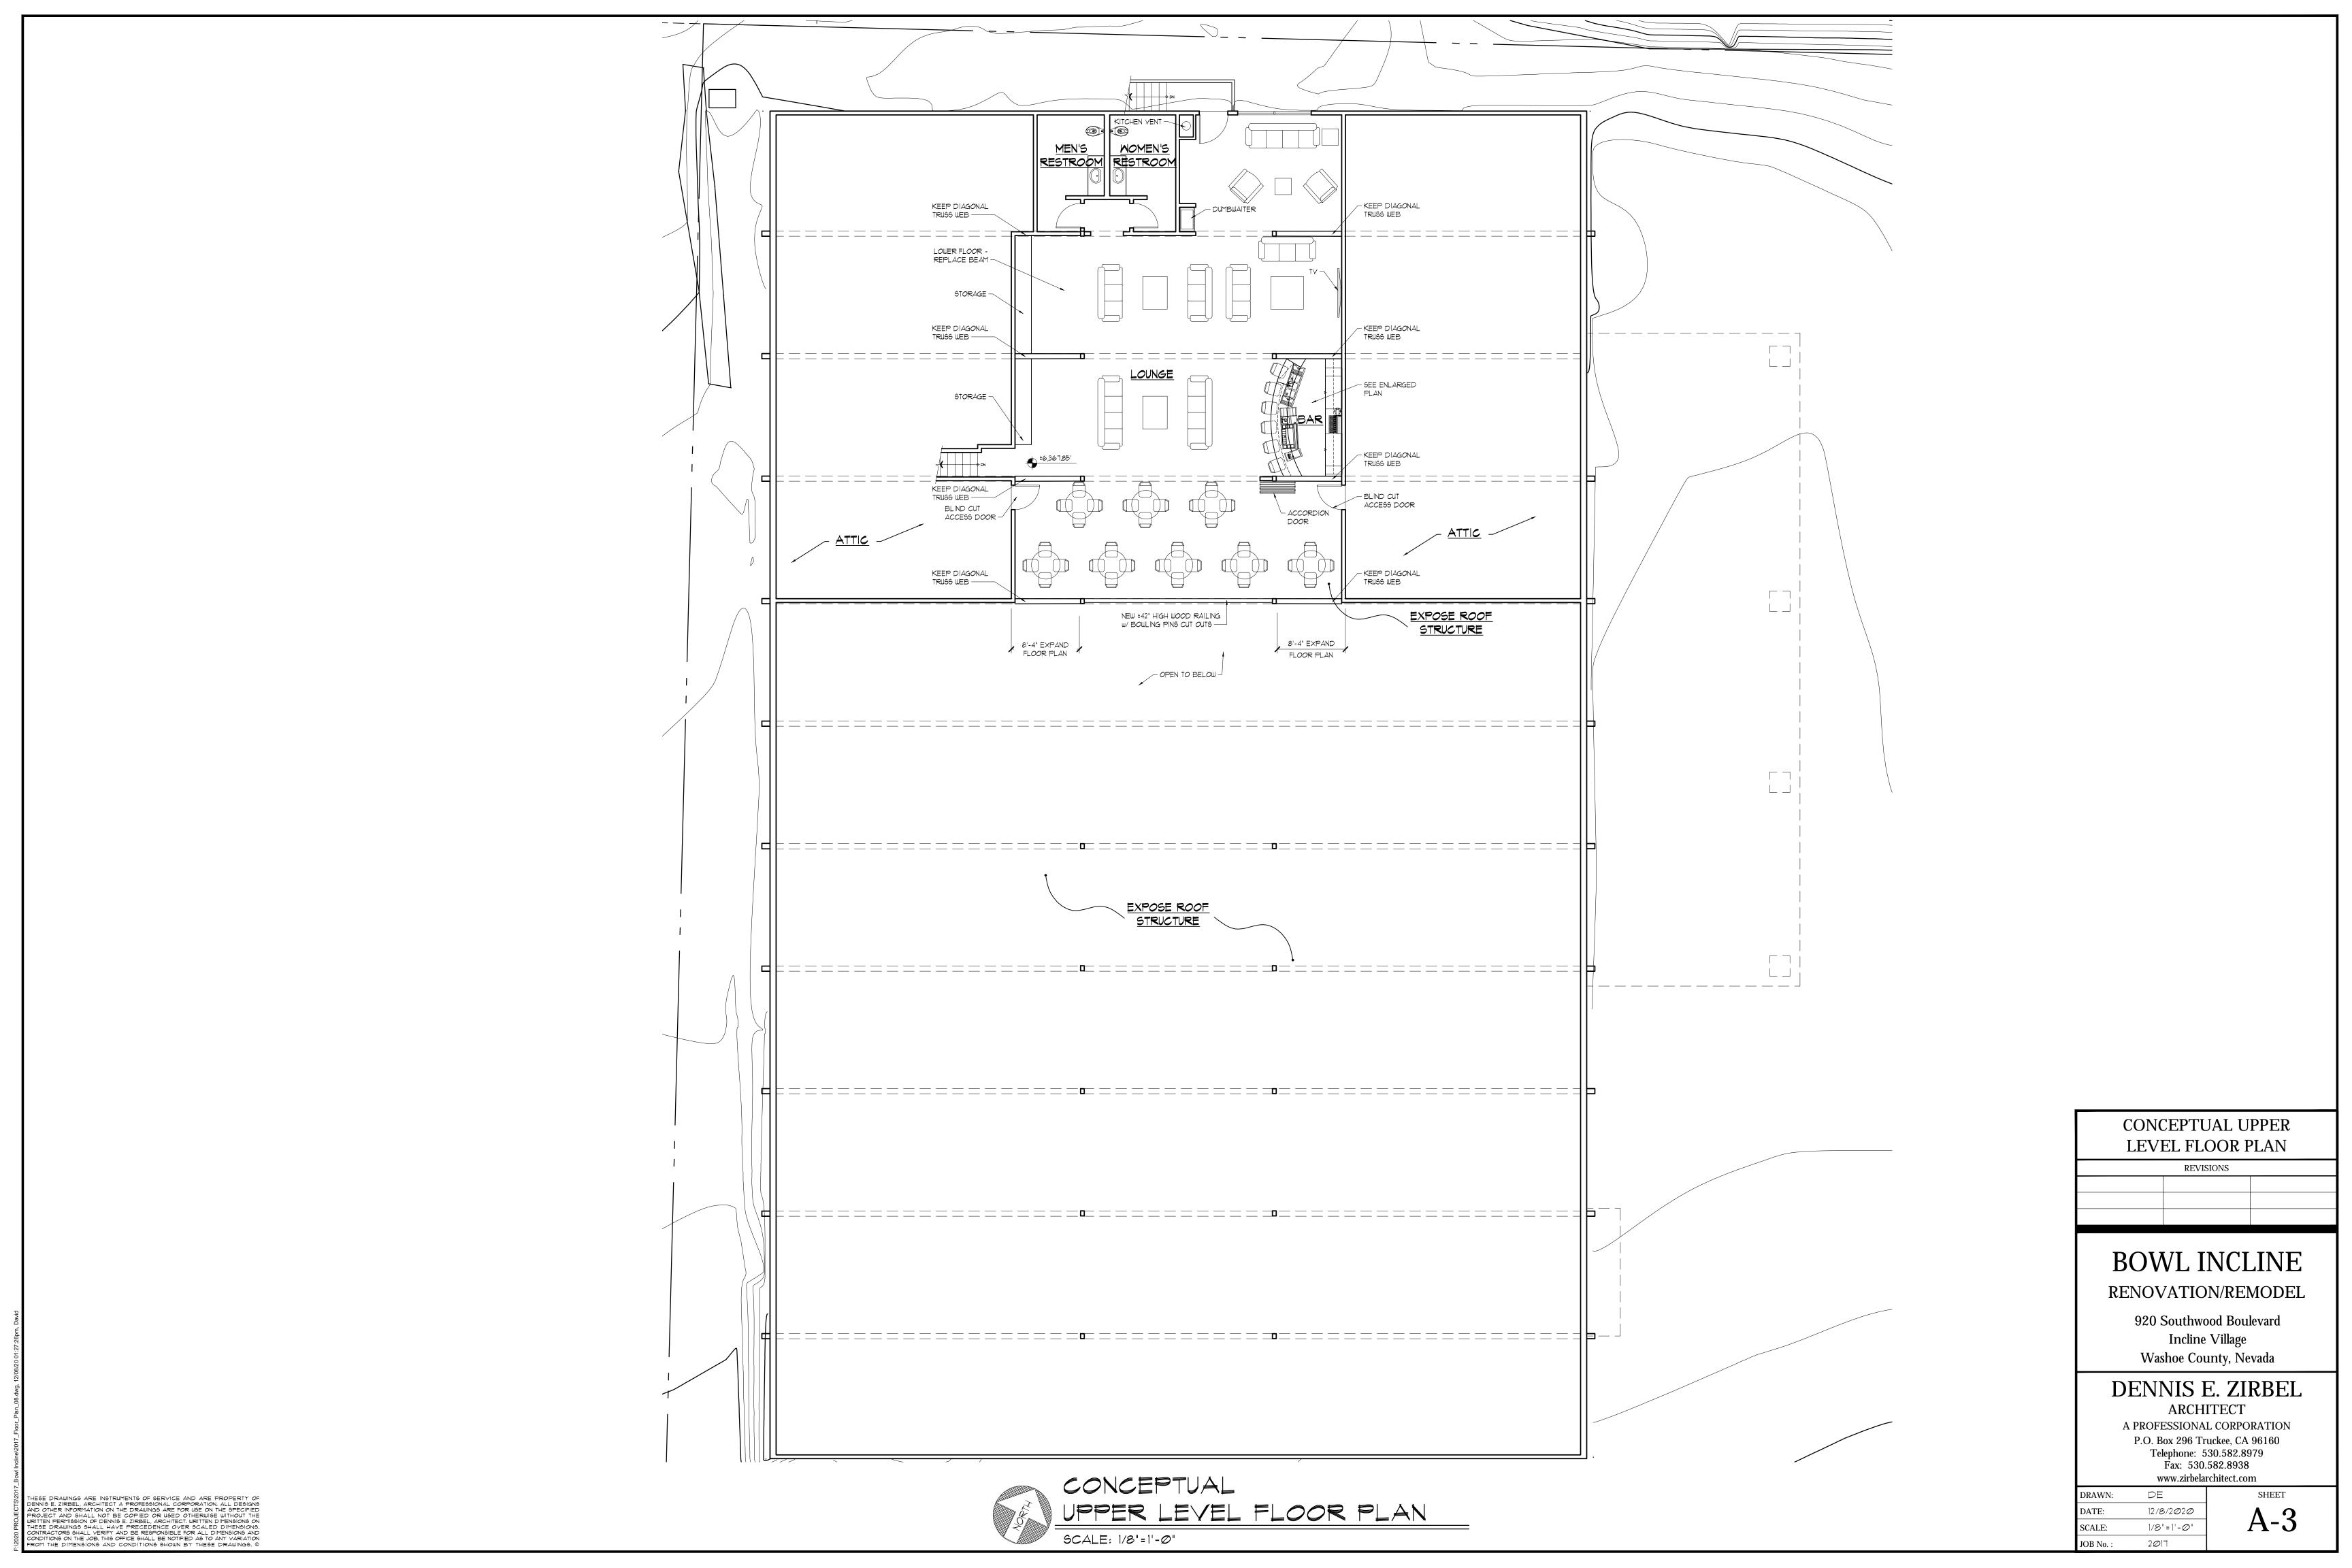




SCALE: 3/8"=1'-0"

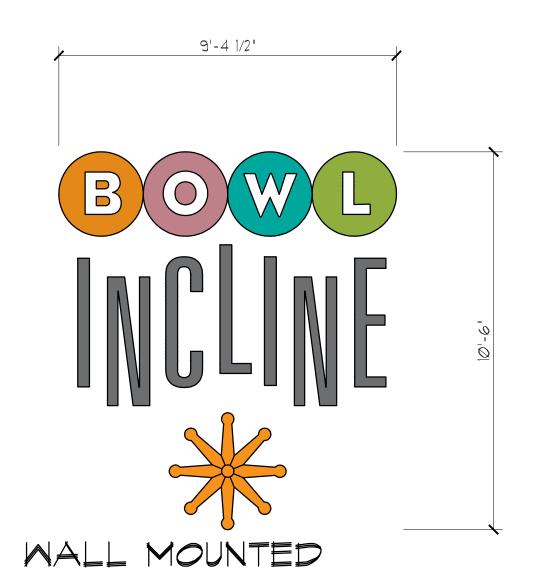

SIGN @ MAIN ENTRY

SCALE: 3/8"=1'-0"

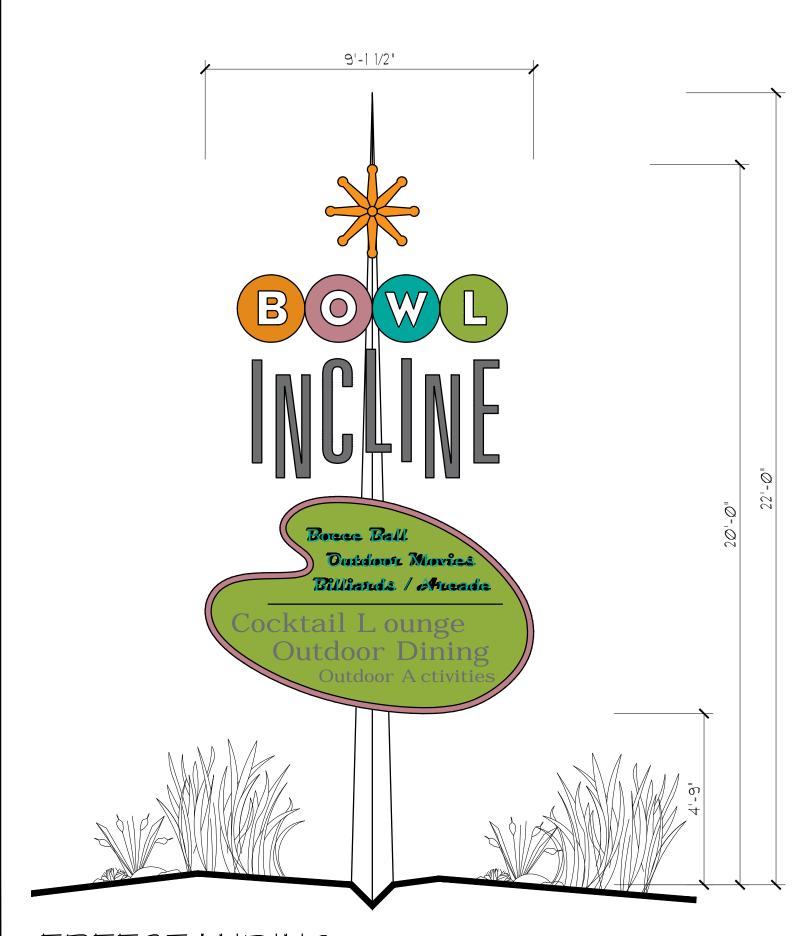


FREESTANDING

SIGN @ PROPERTY SE CORNER SCALE: 3/8"=1'-0"

NEW "INCLINE" ENTRY ROOF — SNOW FENCE PER 'TRA" - GENERAL CONTRACTOR
16 TO HAVE SNOW FENCE DESIGN ENGINEERED PROVIDE SHOP DRAWINGS FOR ARCH. REVIEW
4-1 - NEW CLIMBING WALL BOWL SNOW FENCE PER 'TRA" - GENERAL CONTRACTOR 15 TO HAVE SNOW FENCE DESIGN ENGINEERED -PROVIDE SHOP DRAWINGS FOR ARCH. REVIEW -GUTTER W/ DOWNSPOUT -PROVIDE HEAT CABLE IN GUTTER W/ DOWNSPOUT - PROVIDE HEAT CABLE IN L 2x8 CLEAR WRC SLATS W/ - NEW WOOD - NEW 2 FT WIDE HOT NEW BOARD FORM CONCRETE RETAIN WALL L NEW BOWLING LANES SIDING ROLLED STEEL L NEW 2 FT WIDE HOT NEW IX8 CLEAR W.R.C. ±6'-0" HIGH SLAT WALL - NOT "ANCHOR" L NEW GAS FIREPIT L NEW STONE VENEER - PAINT / REPAIR L NEW BOWLING PIN SCULPTURES NEW 8 FT TALL
EXTERIOR GLASS
DOORS ROLLED STEEL PANEL BOULDER EXISTING SIDING, TYP. BOX OUT AROUND COMPLETED SHOWN FOR EXISTING COLUMN, TYP.

EXTERIOR ELEVATION

SCALE: 1/8"=1'-0"

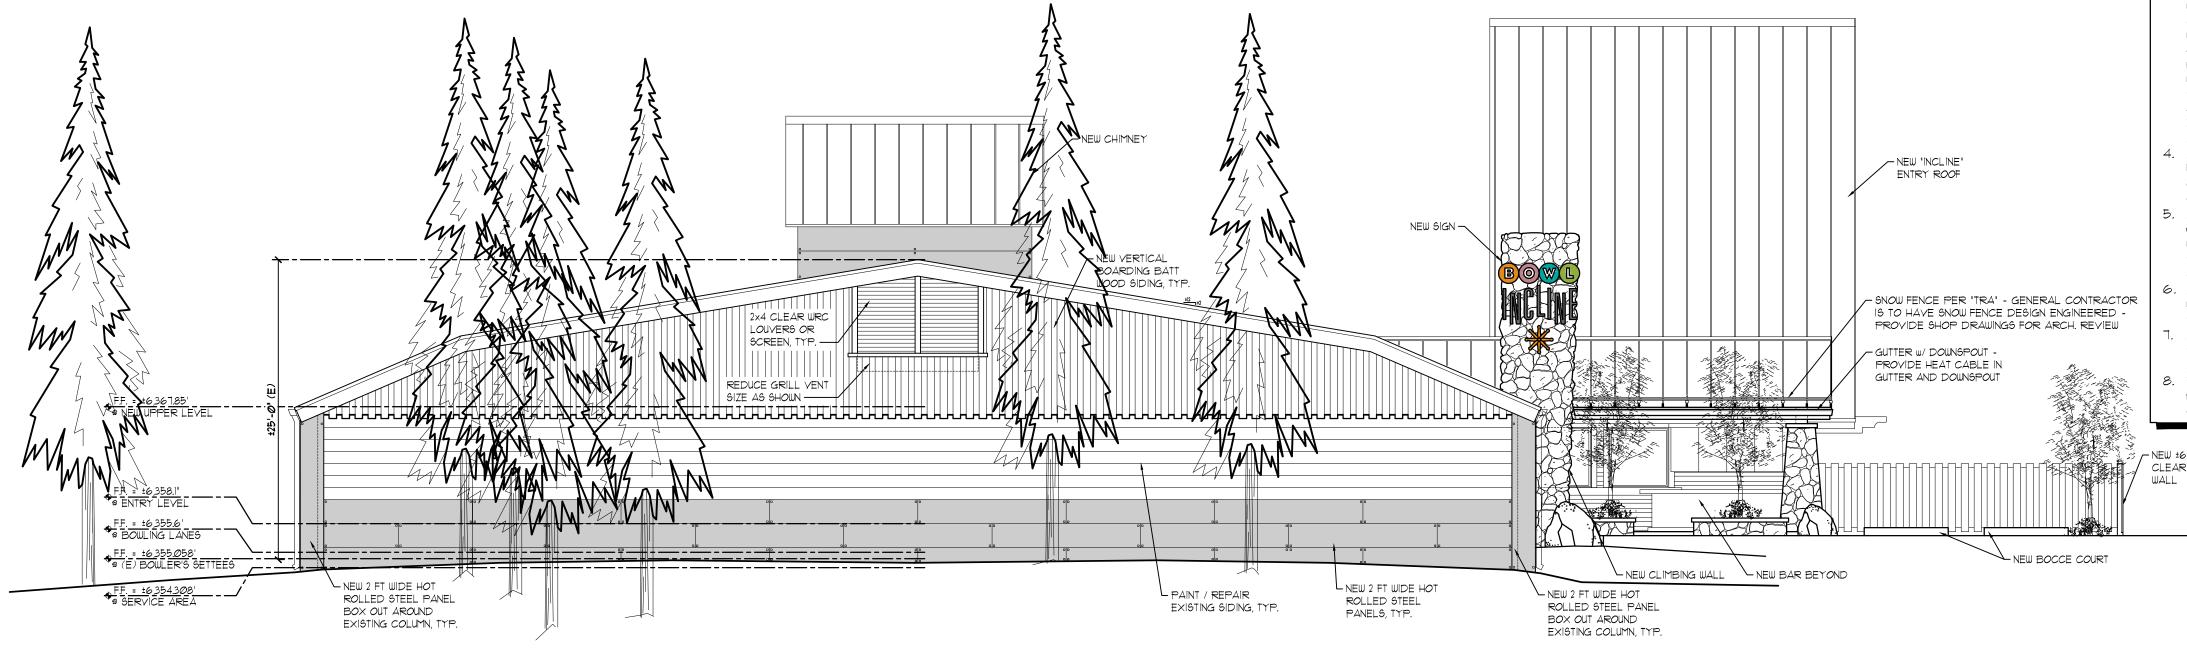

SOUTH EXTERIOR ELEVATION

SCALE: 1/8"=1'-0"

GENERAL EXTERIOR NOTES

All existing horizontal exterior siding is a bevel siding to be primered and painted. Color to be determined. All new vertical exterior siding to be 2x10 STK WRC square edge boards w/ 2x8 STK WRC square edge batts. All new horizontal exterior siding to be 2x8 STK WRC square edge boards W/ 2x6 STK WRC square edge batts. - no groove, both sidings to be "Circle Sawn" "Montana Timber Products" "Ranchwood" in Eastern color. All trim to be 2x STK WRC "Wire Brushed" per plan with matching finish to siding. Verify details and color with Architect.

All structural members (i.e.: columns, beams & rafters) to be resawn douglas fir, stained with "Olympic" semi-transparent stain #913. All exposed metal flashing on beam/roof shall be 20 ga. g.i. painted. Submit samples to

3. All Metal Roofs to be "Metal Sales" Magna-Loc w/ pencil ribs & PVDF (Kynar 500) paint system, medium bronze. Verify color

w/ Architect. Provide (2) layers
of "Grace" "Ultra" roof underlayment at all
roofs. "Bithuthene" up full height on rake walls & side
walls. Use 20 ga. g.i. painted valley flashing. Verify
finish and colors with Architect. See roof plan for additional information / detail. Provide continuous 20 ga. gi. painted ridge cap per plan. Consult with Architect prior to ordering.

. All windows / exterior doors to be "Western Windows" or equal aluminum frame windows / doors with dual glazing, and bronze finish, with profile. Verify color with Architect. See window schedule.

All stone shall be ±6" thick "Select Stone" "Pipestone Granite or equal with approximately 20% of the stone with lichen. Set with deep joints in a dry stack fashion. Use "Anchor Boulders" as shown. Provide samples and mock-ups for Architect's review. . All metal siding to be 24" tall 16ga hot rolled steel

with exposed square head fasteners and "Permalac" finish or equal. Consult with Architect. All exposed concrete retaining walls to be board

formed w/ concrete cap and acid stained dark, per

Provide Architect with samples & colors of actual materials, mocked up on exterior all together, with called out finish prior to ordering.

CLEAR W.R.C. SLAT

CONCEPTUAL EXTERIOR **ELEVATIONS**

REVISIONS

BOWL INCLINE

RENOVATION/REMODEL

920 Southwood Boulevard Incline Village Washoe County, Nevada


DENNIS E. ZIRBEL

ARCHITECT A PROFESSIONAL CORPORATION

P.O. Box 296 Truckee, CA 96160 Telephone: 530.582.8979 Fax: 530.582.8938 www.zirbelarchitect.com


DE THESE DRAWINGS ARE INSTRUMENTS OF SERVICE AND ARE PROPERTY OF DENNIS E. ZIRBEL, ARCHITECT A PROFESSIONAL CORPORATION. ALL DESIGNS AND OTHER INFORMATION ON THE DRAWINGS ARE FOR USE ON THE SPECIFIED PROJECT AND SHALL NOT BE COPIED OR USED OTHERUISE WITHOUT THE WRITTEN PERMISSION OF DENNIS E. ZIRBEL, ARCHITECT, WRITTEN DIMENSIONS ON THESE DRAWINGS SHALL HAVE PRECEDENCE OVER SCALED DIMENSIONS, CONTRACTORS SHALL VERIEY AND BE RESPONSIBLE FOR ALL DIMENSIONS AND CONDITIONS ON THE JOB. THIS OFFICE SHALL BE NOTIFIED AS TO ANY VARIATION FROM THE DIMENSIONS AND CONDITIONS SHOWN BY THESE DRAWINGS. © 12/8/2020 1/8"=1'-0"

A-4

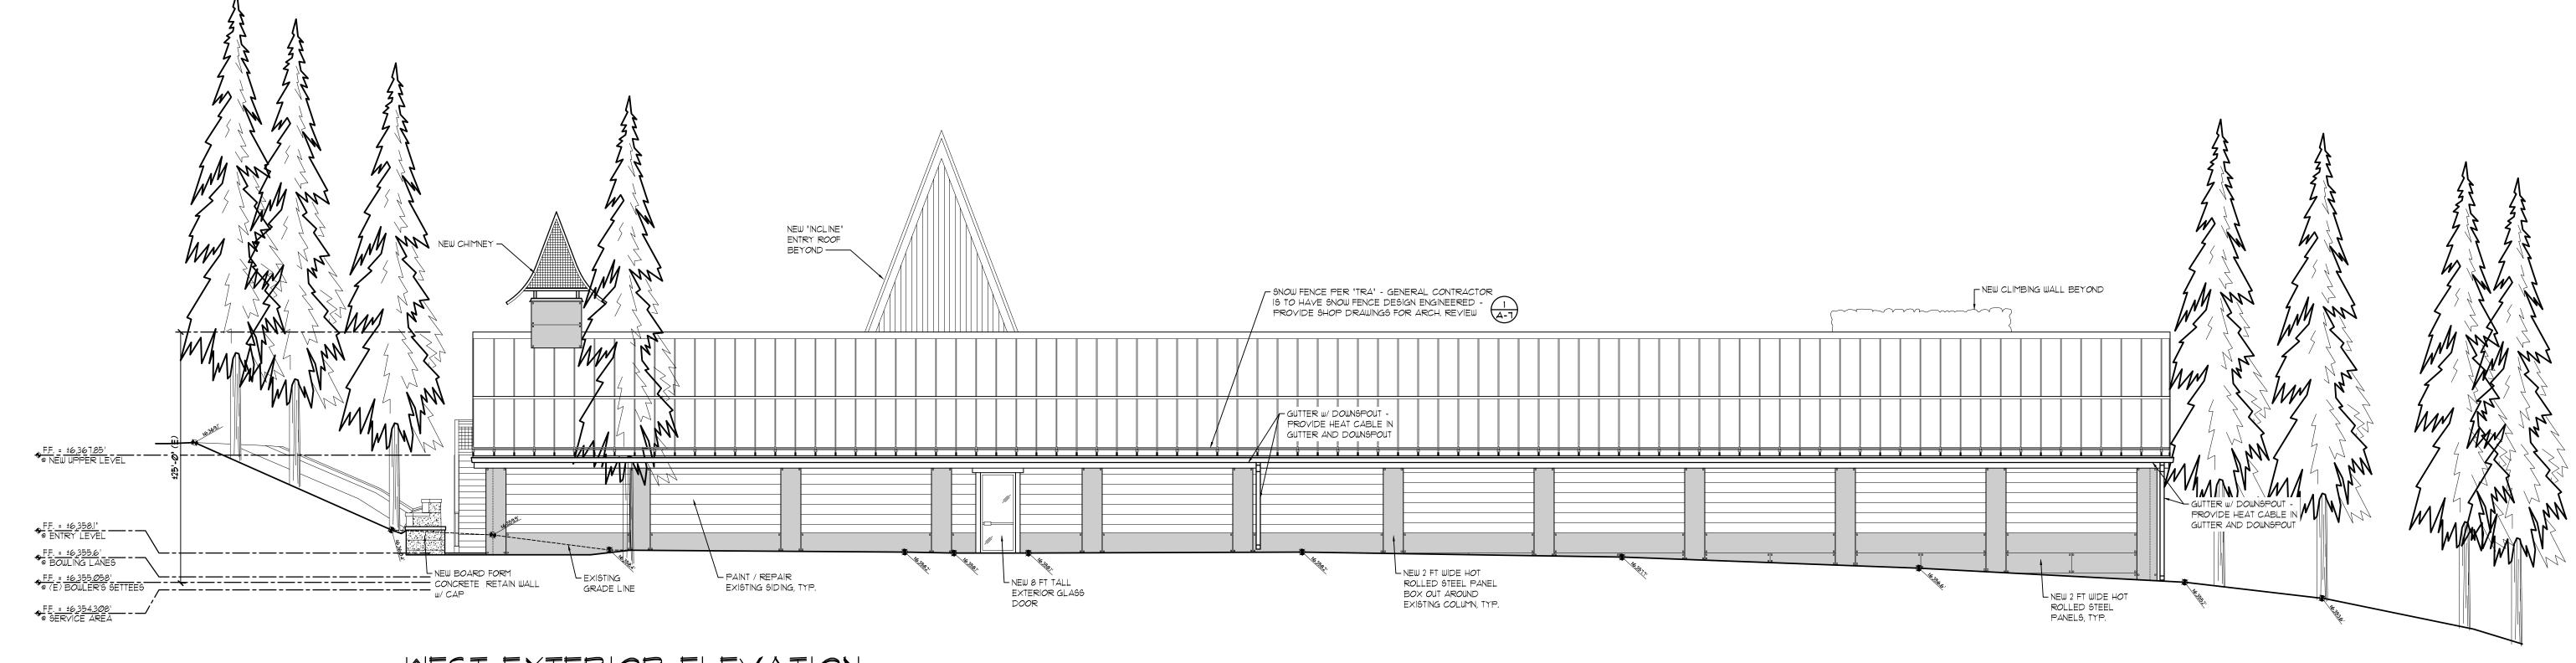

WEST EXTERIOR ELEVATION

SCALE: 1/8"=1'-0"

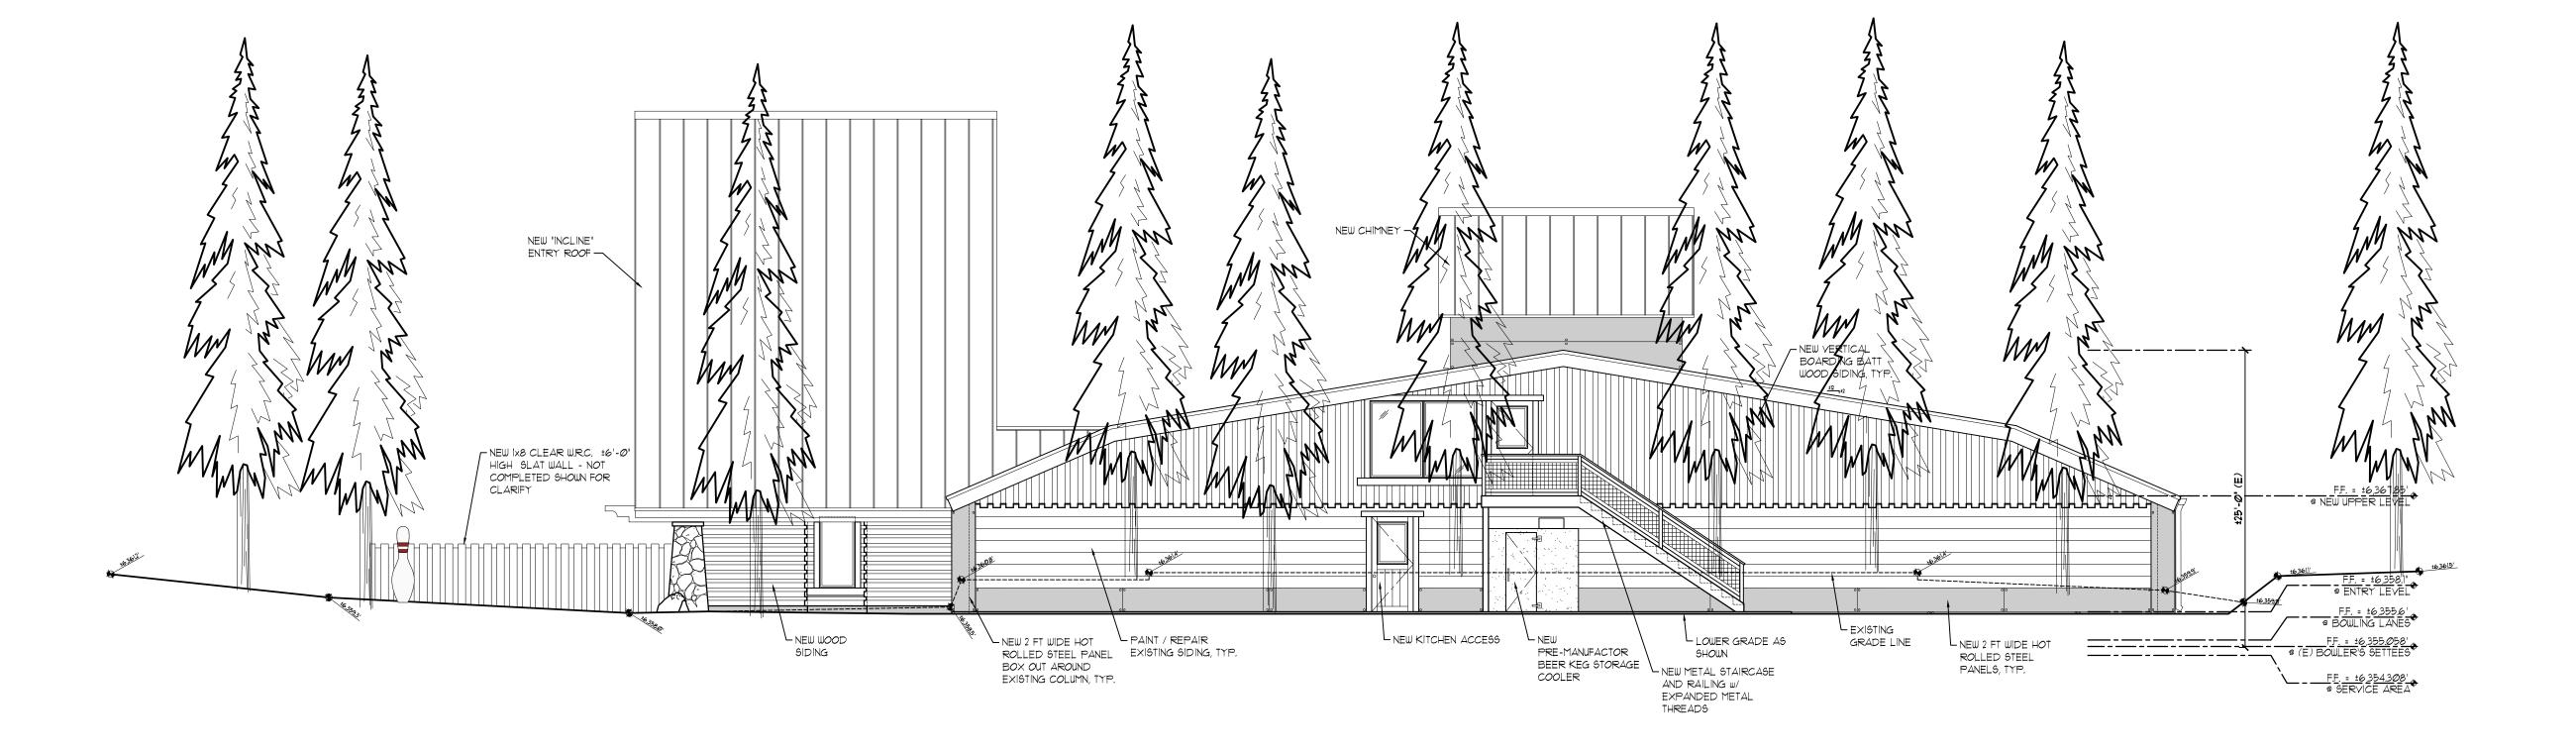

NORTH EXTERIOR ELEVATION

SCALE: 1/8"=1'-0"

CONCEPTUAL EXTERIOR ELEVATIONS

REVISIONS

BOWL INCLINE

RENOVATION/REMODEL

920 Southwood Boulevard Incline Village Washoe County, Nevada

DENNIS E. ZIRBEL

ARCHITECT
A PROFESSIONAL CORPORATION
P.O. Box 296 Truckee, CA 96160
Telephone: 530.582.8979
Fax: 530.582.8938

www.zirbelarchitect.com

 DRAWN:
 YM


 DATE:
 12/8/2020


 SCALE:
 1/8" = 1' - ∅"


 JOB No. :
 2017

A-5

THESE DRAWINGS ARE INSTRUMENTS OF SERVICE AND ARE PROPERTY OF DENNIS E. ZIRBEL, ARCHITECT A PROFESSIONAL CORPORATION. ALL DESIGNS AND OTHER INFORMATION ON THE DRAWINGS ARE FOR USE ON THE SPECIFIED PROJECT AND SHALL NOT BE COPIED OR USED OTHERWISE WITHOUT THE WRITTEN PERMISSION OF DENNIS E. ZIRBEL, ARCHITECT. WRITTEN DIMENSIONS ON THESE DRAWINGS SHALL HAVE PRECEDENCE OVER SCALED DIMENSIONS. CONTRACTORS SHALL VERIFY AND BE RESPONSIBLE FOR ALL DIMENSIONS AND CONDITIONS ON THE JOB. THIS OFFICE SHALL BE NOTHED AS TO ANY VARIATION FROM THE DIMENSIONS AND CONDITIONS SHOWN BY THESE DRAWINGS. ©

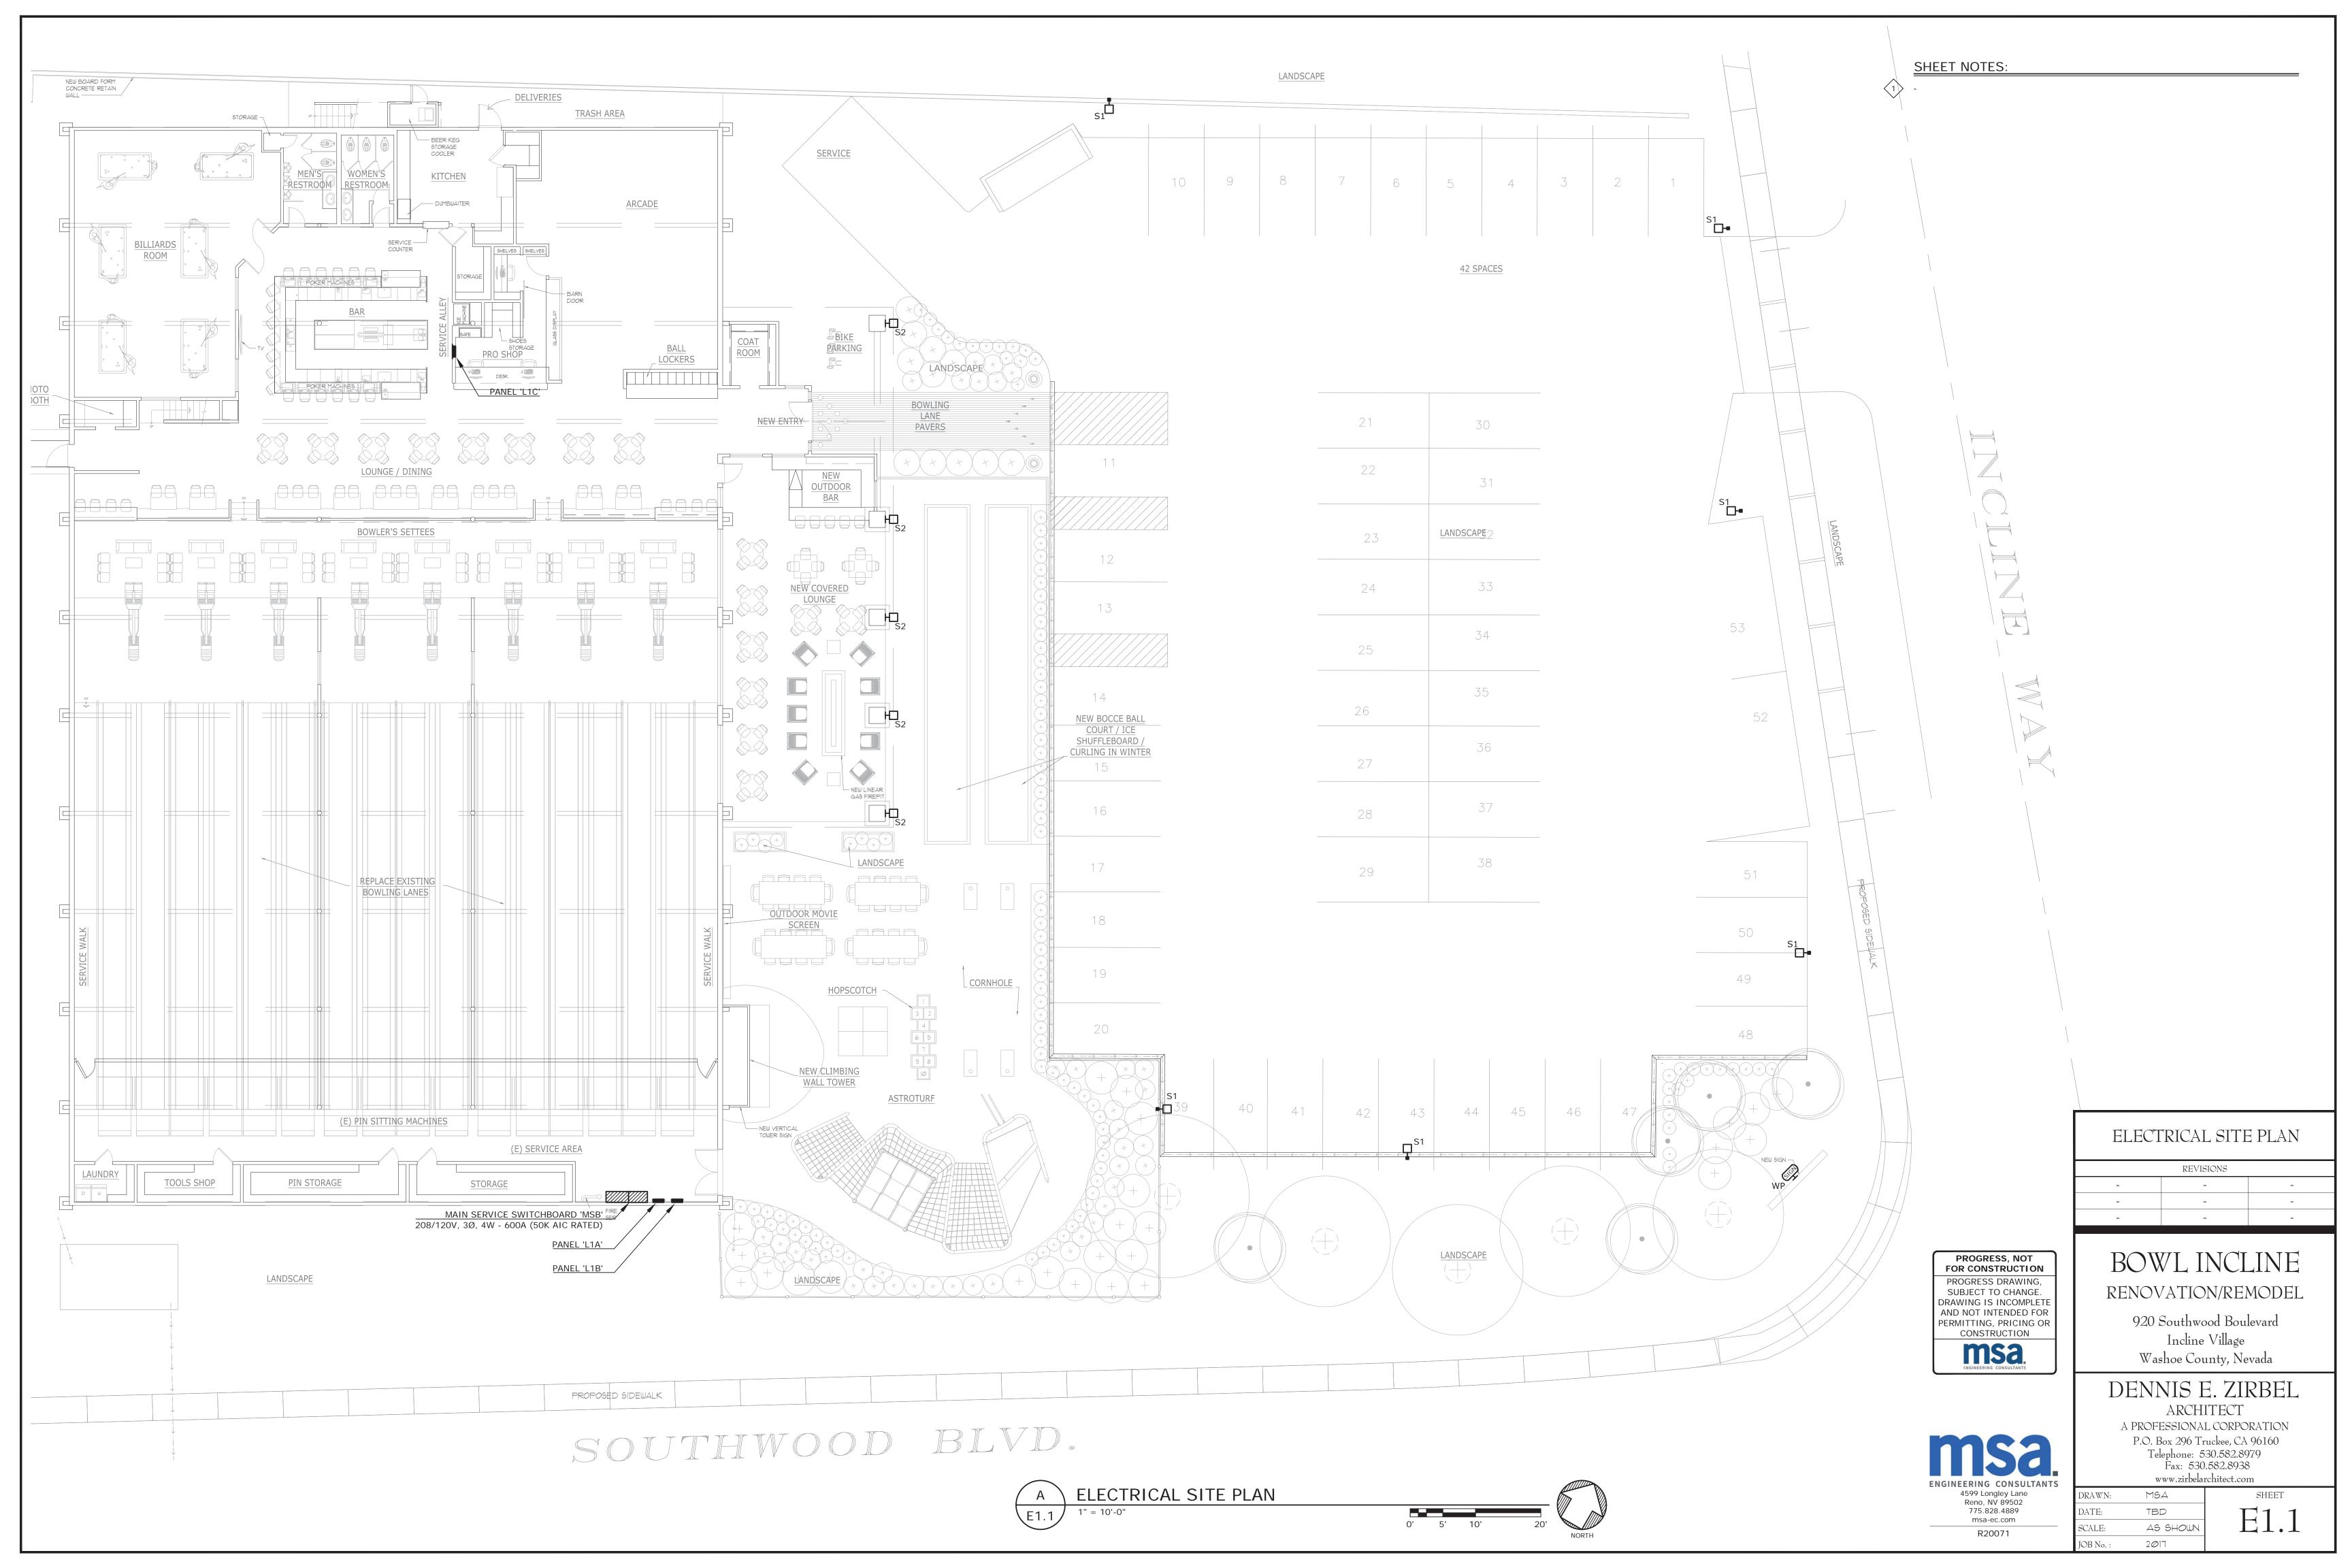

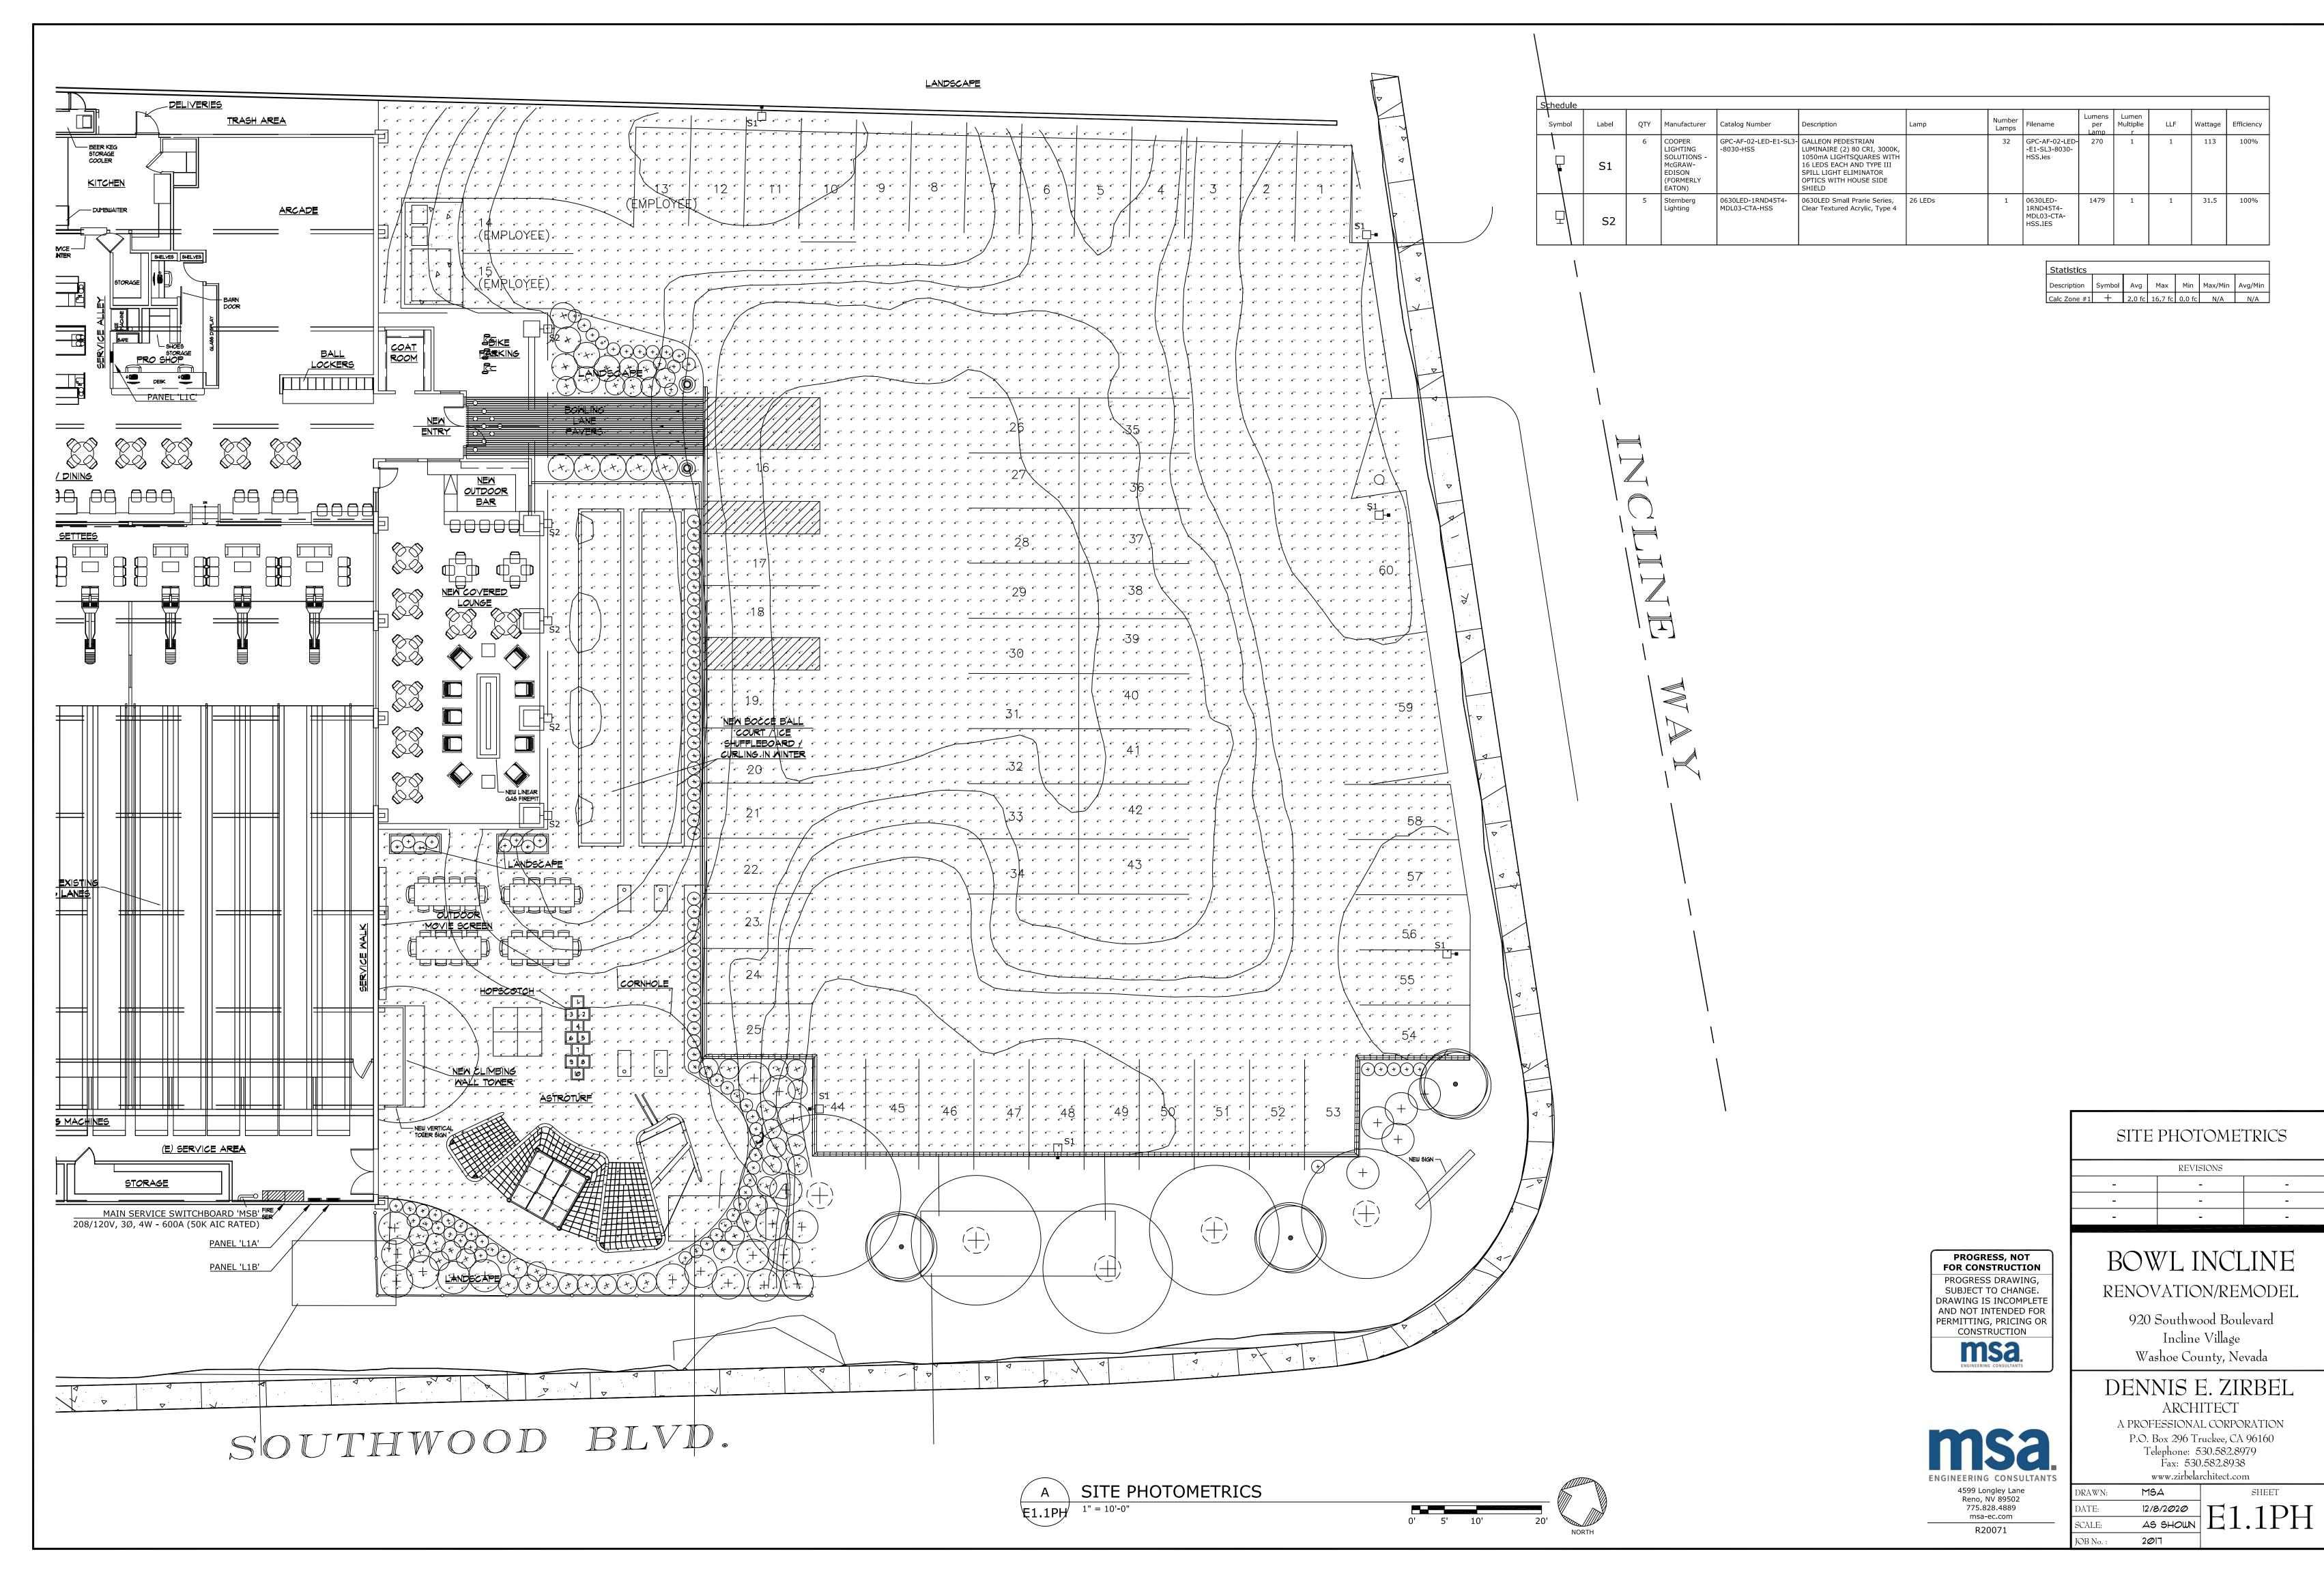

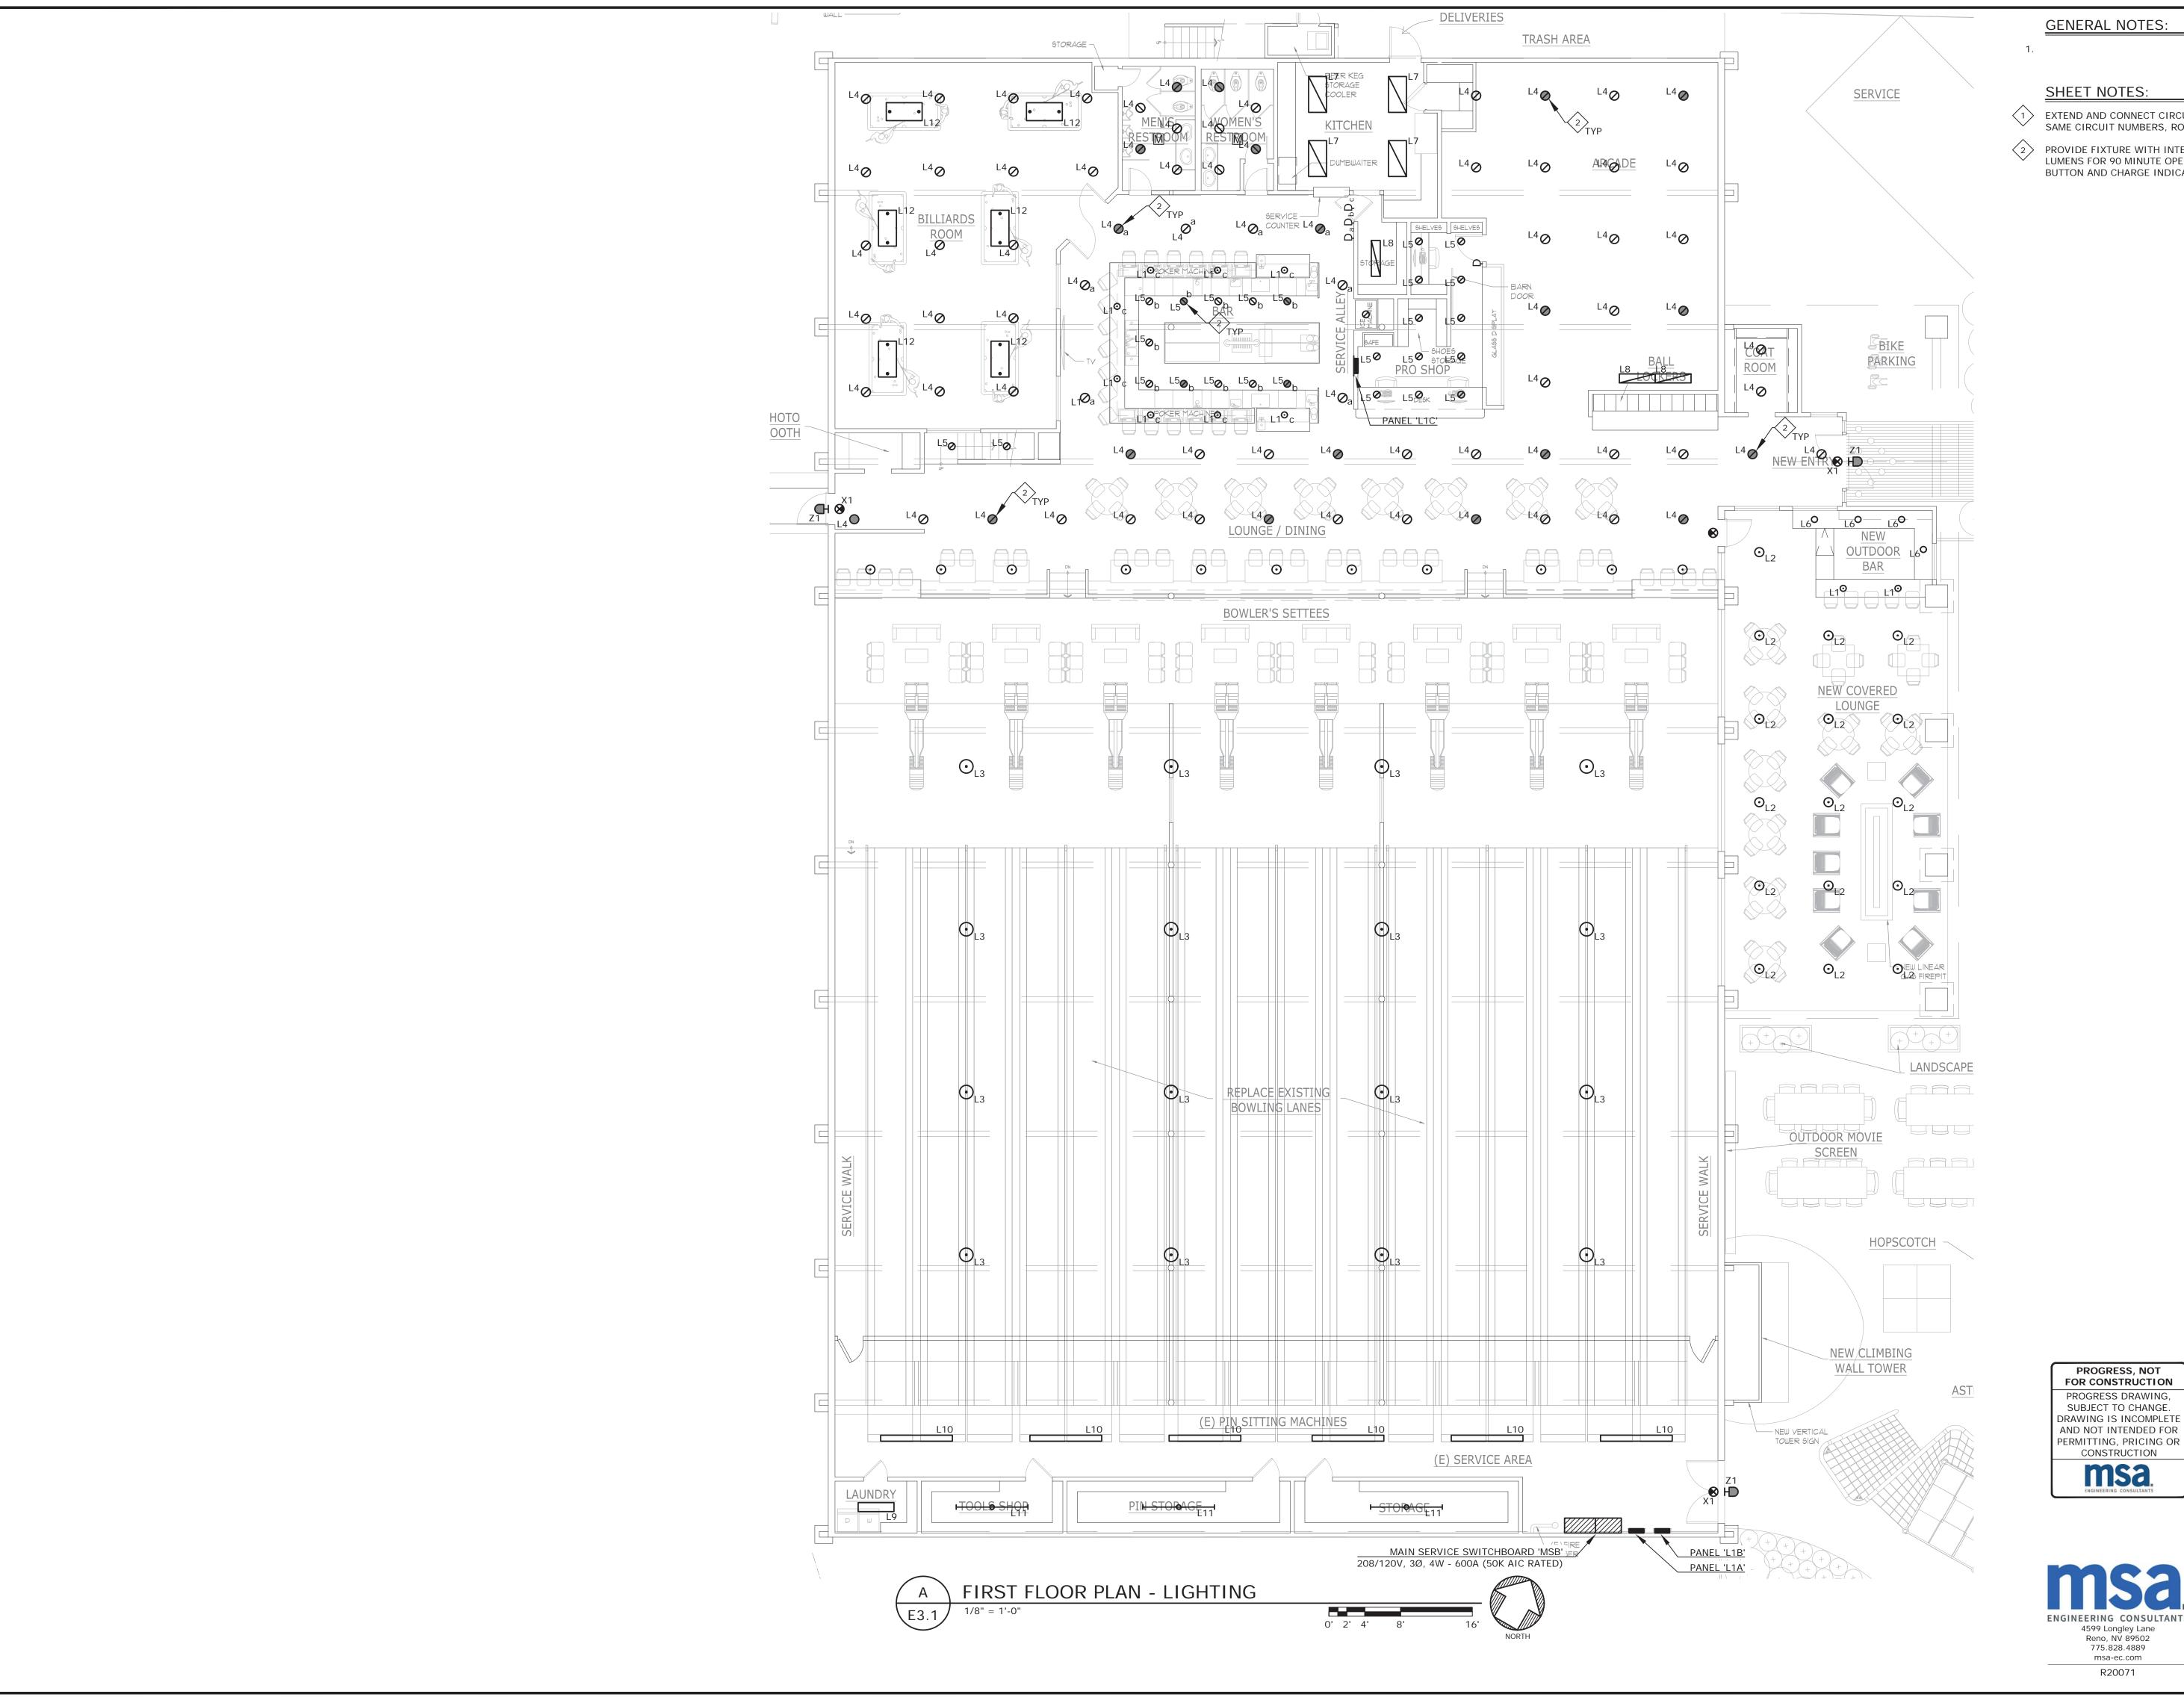

GENERAL NOTES:

SHEET NOTES:

EXTEND AND CONNECT CIRCUITING FROM JUNCTION BOX TO OUTLETS IN AREA WITH SAME CIRCUIT NUMBERS, ROUTE #12 CONDUCTORS (MINIMUM) THROUGHOUT, UON.

PROVIDE FIXTURE WITH INTEGRAL/REMOTE BATTERY PACK FOR APPROXIMATELY 1/2 LUMENS FOR 90 MINUTE OPERATION DURING POWER LOSS. INCLUDE REMOTE TEST BUTTON AND CHARGE INDICATOR LED RED LIGHT.

FIRST FLOOR PLAN -LIGHTING REVISIONS

BOWL INCLINE PROGRESS, NOT FOR CONSTRUCTION PROGRESS DRAWING,

RENOVATION/REMODEL

920 Southwood Boulevard Incline Village Washoe County, Nevada

DENNIS E. ZIRBEL

ARCHITECT
A PROFESSIONAL CORPORATION P.O. Box 296 Truckee, CA 96160
Telephone: 530.582.8979
Fax: 530.582.8938

NTS		www.zirbela	rchitect.
	DRAWN:	MSA	
	DATE:	TBD	
	COLLE	A.C. C.I.O.II.N.I	

untect.com
SHEET E3.1 AS SHOWN JOB No. : 2017

GENERAL NOTES:

CONSTRUCTION NOISE: THE CONTRACTOR SHALL INSURE THAT ALL CONSTRUCTION VEHICLES OR EQUIPMENT, FIXED OR MOBILE, OPERATED WITHIN CLOSE PROXIMITY OF A RESIDENTIAL DWELLING SHALL BE EQUIPPED WITH PROPERLY OPERATING AND MAINTAINED MUFFLERS AT ALL TIMES DURING PROJECT CONSTRUCTION. IT IS THE OWNER'S RESPONSIBILITY TO OBTAIN THE SERVICES OF A QUALIFIED ACOUSTICAL PROFESSIONAL TO VERIFY PROPER EQUIPMENT MUFFLERS IF CONCERNS RELATING TO THE ISSUE ARISE.


CONSTRUCTION NOISE EMANATING FROM ANY CONSTRUCTION ACTIVITIES FOR WHICH A BUILDING PERMIT OR GRADING PERMIT IS REQUIRED IS PROHIBITED ON SUNDAYS AND FEDERAL HOLIDAYS, AND SHALL ONLY OCCUR:


- A) MONDAY THROUGH FRIDAY, 7:00 AM TO 8:00 PM
- B) SATURDAY, 8:00 AM TO 5:00 PMC) SUNDAY, 10:00 AM TO 4:00 PM


ADVISORY COMMENT: ESSENTIALLY, QUIET ACTIVITIES, WHICH DO NOT INVOLVE HEAVY EQUIPMENT OR MACHINERY, MAY OCCUR AT OTHER TIMES.

- 2. THE CONTRACTOR SHALL TAKE ALL NECESSARY AND PROPER PRECAUTIONS TO PROTECT EXISTING IMPROVEMENTS WITHIN THE RIGHT OF WAY AS WELL AS ADJACENT PROPERTIES FROM ANY AND ALL DAMAGE THAT MAY RESULT FROM ANY AND ALL WORK IN CONNECTION WITH CONSTRUCTION. CONTRACTOR SHALL BE RESPONSIBLE TO RESTORE ANY DAMAGE DUE TO CONSTRUCTION ACTIVITIES.
- 3. THE CONTRACTOR SHALL PROVIDE ALL NECESSARY HORIZONTAL AND VERTICAL TRANSITIONS BETWEEN NEW CONSTRUCTION AND EXISTING SURFACES TO PROVIDE FOR PROPER DRAINAGE AND INGRESS/EGRESS TO SAID CONSTRUCTION. THE EXTENT OF TRANSITION IS TO BE DETERMINED BY THE ENGINEER.
- 4. ALL ROADSIDE DITCHES AND SHOULDERS SHALL BE RECONSTRUCTED TO ORIGINAL GRADES AND CONDITIONS.
- 5. ALL GRADING AND PAVING WORK SHALL CONFORM TO THE RECOMMENDATIONS CONTAINED IN THE PROJECT PLANS AND SPECIFICATIONS.
- 6. HORIZONTAL AND VERTICAL LAYOUT SHALL BE VERIFIED BY A LICENSED LAND SURVEYOR PRIOR TO CONSTRUCTION.
- 7. THE ENGINEER ASSUMES NO RESPONSIBILITY BEYOND THE ADEQUACY OF HIS DESIGN CONTAINED HEREIN.
- 8. THE FOLLOWING STANDARDS AND SPECIFICATIONS ARE REQUIREMENTS APPLICABLE TO THIS PROJECT AND SHALL BE MAINTAINED EXCEPT AS EXPLICITLY MODIFIED OR SUPPLEMENTED BY THESE PLANS. ALL REFERENCE STANDARDS AND SPECIFICATIONS ARE THE LATEST EDITIONS.
- A. TRPA STANDARDS AND BMP GUIDELINESB. WASHOE COUNTY STANDARDS
- 9. SHOULD IT APPEAR THAT THE WORK TO BE COMPLETED, OR ANY MATTER RELATIVE THERETO, IS NOT SUFFICIENTLY DETAILED OR EXPLAINED ON THESE PLANS, THE CONTRACTOR SHALL CONTACT HIGH SIERRA ENGINEERING FOR SUCH FURTHER EXPLANATIONS AS MAY BE NECESSARY. PHONE: (530) 414-5026.
- 10. ALL LOCATIONS OF EXISTING UTILITIES SHOWN HAVE BEEN ESTABLISHED BY FIELD OBSERVATION OR OBTAINED FROM AVAILABLE RECORDS AND SHOULD THEREFORE BE CONSIDERED APPROXIMATE ONLY AND NOT NECESSARILY COMPLETE. IT IS THE SOLE RESPONSIBILITY OF THE CONTRACTOR TO INDEPENDENTLY VERIFY THE ACCURACY OF THE UTILITY LOCATIONS SHOWN AND TO FURTHER DISCOVER AND AVOID ANY OTHER UTILITIES NOT SHOWN HEREON WHICH MAY BE AFFECTED BY THESE PLANS. THE CONTRACTOR SHALL EXPOSE AND VERIFY ELEVATIONS OF EXISTING UTILITIES AND CLEARANCES OF UTILITY CROSSINGS AT LEAST 48 HOURS IN ADVANCE OF PIPELINES AND PUMP STATION EXCAVATIONS.
- 11. THE UTILITY LOCATIONS SHOWN AND TO FURTHER DISCOVER AND AVOID ANY OTHER UTILITIES NOT SHOWN HEREON WHICH MAY BE AFFECTED BY THESE PLANS. THE CONTRACTOR SHALL EXPOSE AND VERIFY ELEVATIONS OF EXISTING UTILITIES AND CLEARANCES OF UTILITY CROSSINGS AT LEAST 48 HOURS IN ADVANCE OF PIPELINES AND PUMP STATION EXCAVATIONS.
- 12. CONTRACTOR AGREES THAT THEY SHALL ASSUME SOLE AND COMPLETE RESPONSIBILITY FOR JOB SITE CONDITIONS DURING THE COURSE OF CONSTRUCTION OF THIS PROJECT, INCLUDING SAFETY OF ALL PERSONS AND PROPERTY, THAT THIS REQUIREMENT SHALL APPLY CONTINUOUSLY AND NOT BE LIMITED TO NORMAL WORKING HOURS, AND THAT THE CONTRACTOR SHALL DEFEND, INDEMNIFY AND HOLD THE OWNER AND THE ENGINEER HARMLESS FROM ANY AND ALL LIABILITY, REAL OR ALLEGED, IN CONNECTION WITH THE PERFORMANCE OF WORK ON THIS PROJECT, EXCEPTING FOR LIABILITY ARISING FROM THE SOLE NEGLIGENCE OF THE OWNER OR THE ENGINEER.
- 13. THE CONTRACTOR SHALL EXPOSE AND CHECK ELEVATIONS OF EXISTING UTILITIES AND CLEARANCES OF UTILITY CROSSINGS BEFORE CONSTRUCTING NEW PIPELINES.

LEGEND

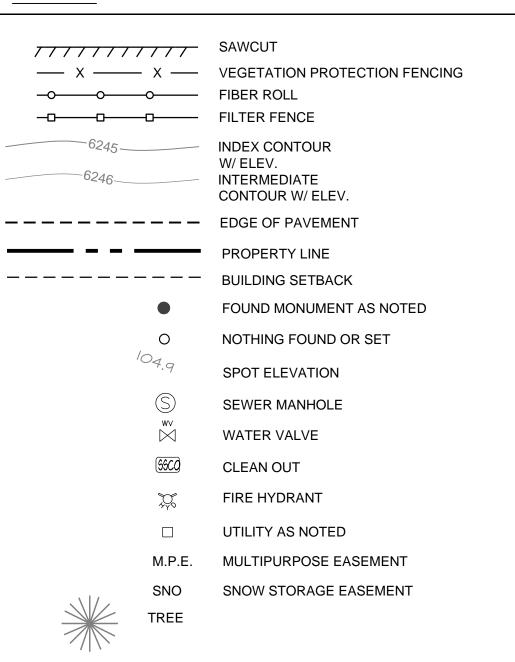

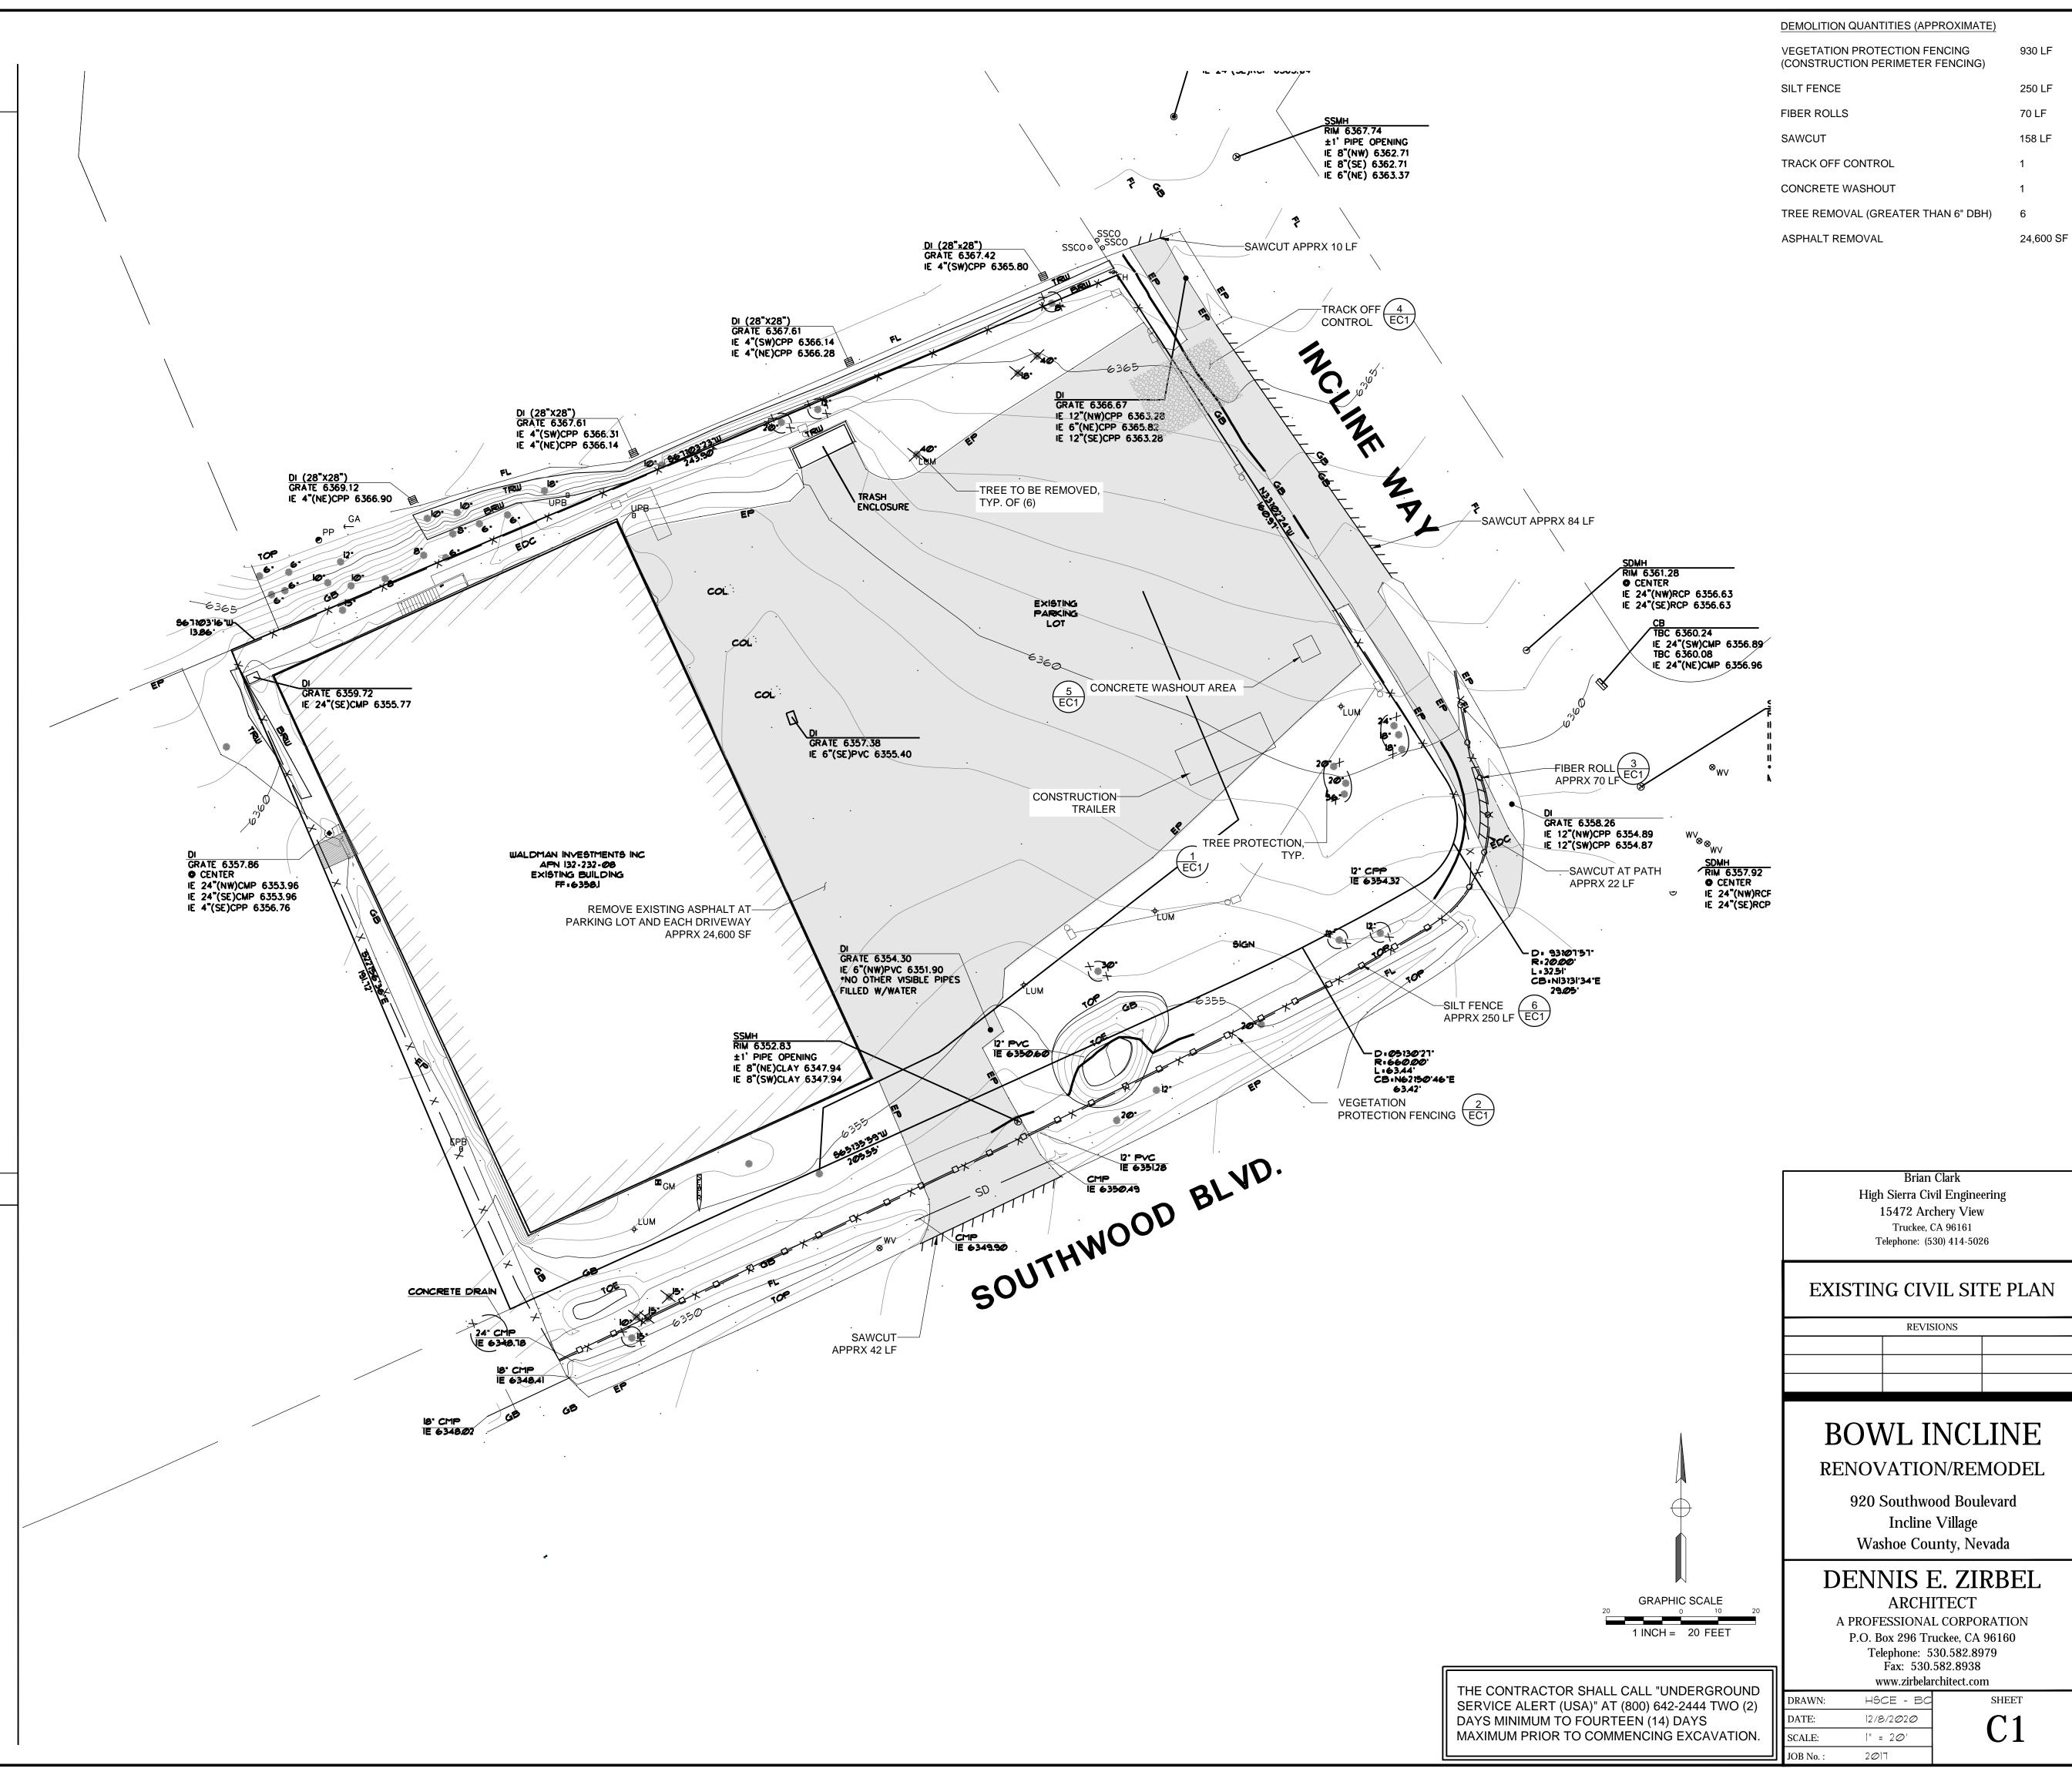

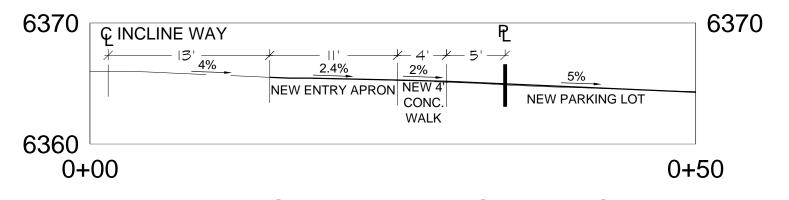

EROSION CONTROL NOTES:

NECESSARY TO INSURE PROPER FUNCTION.

THE SATISFACTION OF WASHOE COUNTY

CARRIED OUT UTILIZING BMPs.

WITH PINE STRAW OR MULCH.

SEDIMENTATION.

APPROVED METHOD (PROJECT STAGING AREA INCLUDED).

PRIOR TO FORECAST RAIN OR SNOW EVENTS EXCEEDING 50% PROBABILITY (AS

DISTURBED AREAS SHALL BE STABILIZED WITH PINE NEEDLES, MUCH OR OTHER

REMOVAL OF NATIVE VEGETATION SHALL BE MINIMIZED. ALL DISTURBED AREAS

SHALL BE STABILIZED WITH A 3-INCH LAYER OF MULCH OR COVERED WITH AN

TEMPORARY EROSION CONTROL MEASURES AND DETAILS AS SHOWN ON THIS

PLAN ARE SUGGESTED MINIMUM METHODS OF CONTROLLING EROSION DURING

MEASURES AS DICTATED BY FIELD CONDITIONS TO CONTROL EROSION AND

IF INCLEMENT WEATHER IS FORECAST, CONTRACTOR SHALL TAKE NECESSARY

STEPS TO PROTECT AREAS DISTURBED BY CONSTRUCTION FROM EROSION AND/OR SUBSEQUENT DISCHARGE OF EARTHEN MATERIALS FROM THE SITE

ALL TEMPORARY EROSION CONTROL FEATURES SHALL BE INSPECTED DAILY

AND PRIOR TO INCLEMENT WEATHER AND CORRECTIVE ACTION TAKEN AS

ALL AREAS DISTURBED BY CONSTRUCTION OF OFFSITE UTILITIES, INCLUDING ROADWAY SURFACES, SHOULDERS AND OTHER AREAS WILL BE RESTORED TO

ALL DISTURBED AREAS SHALL BE REVEGETATED OR OTHERWISE PROTECTED

TO THE SATISFACTION OF THE ENGINEER. ONLY NATIVE BRUSH AND GRASS

DISTURBANCE WITHIN EACH PHASE SHALL BE RESTORED PURSUANT TO BEST

MANAGEMENT PRACTICES (BMPs). THIS INCLUDES REVEGETATION OF EXISTING DIRT ROADS WHICH WILL NO LONGER BE UTILIZED FOR VEHICULAR ACCESS.

THE AREAS OF SOIL AND VEGETATION DISTURBANCE SHALL BE LIMITED TO THAT

REQUIRED FOR CONSTRUCTION PURPOSES. EXCEPT WHERE REQUIRED FOR

ACCESS, THERE SHALL BE NO DISTURBANCE IN AREAS TO BE LEFT IN A

ETC.) OR OTHER DESIGNATED ROUTES APPROVED BY THE ENGINEER.

NATURAL STATE. CONSTRUCTION TRAFFIC SHALL BE LIMITED TO AREAS TO BECOME PERMANENT CIRCULATION (E.G., ROADWAYS AND PARKING AREAS,

DISTURBANCE CREATED BY CONSTRUCTION SHALL BE STABILIZED WITHIN 24 HOURS OF CESSATION OF TRAVEL INTO SUCH AREAS. IF WORK HAS CEASED IN

AN AREA OR IF AN AREA IS FOUND TO BE SUBJECT TO POTENTIAL EROSION

EFFORTS TO STABILIZE SUCH AREAS SHALL BE INITIATED THE NEXT WORK DAY

A. CONDUCT MAJOR DUST-GENERATING ACTIVITIES WHEN WIND VELOCITIES

B. SPRINKLE WORK AREAS, CONSTRUCTION EQUIPMENT TRAVEL ROUTES,

PROBLEMS ASSOCIATED WITH VEGETATION LOSS AND SOIL COMPACTION,

FOLLOWING THE INSPECTION. STABILIZATION OF THESE AREAS SHALL BE

10. THE CONTRACTOR SHALL MAINTAIN ADEQUATE DUST CONTROL. MEASURES

C. PREVENT CONSTRUCTION VEHICLES FROM TRACKING MUD ONTO

ALL DISTURBED AREAS WILL BE REVEGETATED WITH THE WASHOE COUNTY

APPROVED SEED MIX, AND ALL AREAS OF EXPOSED SOIL WILL BE STABILIZED

SHALL INCLUDE BUT NOT BE LIMITED TO THE FOLLOWING:

AND EQUIPMENT TO CONTROL DUST.


NEIGHBORING ROADS AND HIGHWAYS.

SPECIES SHALL BE USED FOR REVEGETATION. EXISTING AREAS OF

CONSTRUCTION. THE CONTRACTOR SHALL IMPLEMENT ADDITIONAL

SHOWN ON THE NOAA.ORG WEBSITE) AND AFTER PROJECT COMPLETION ALL

Driveway Centerline Cross Section

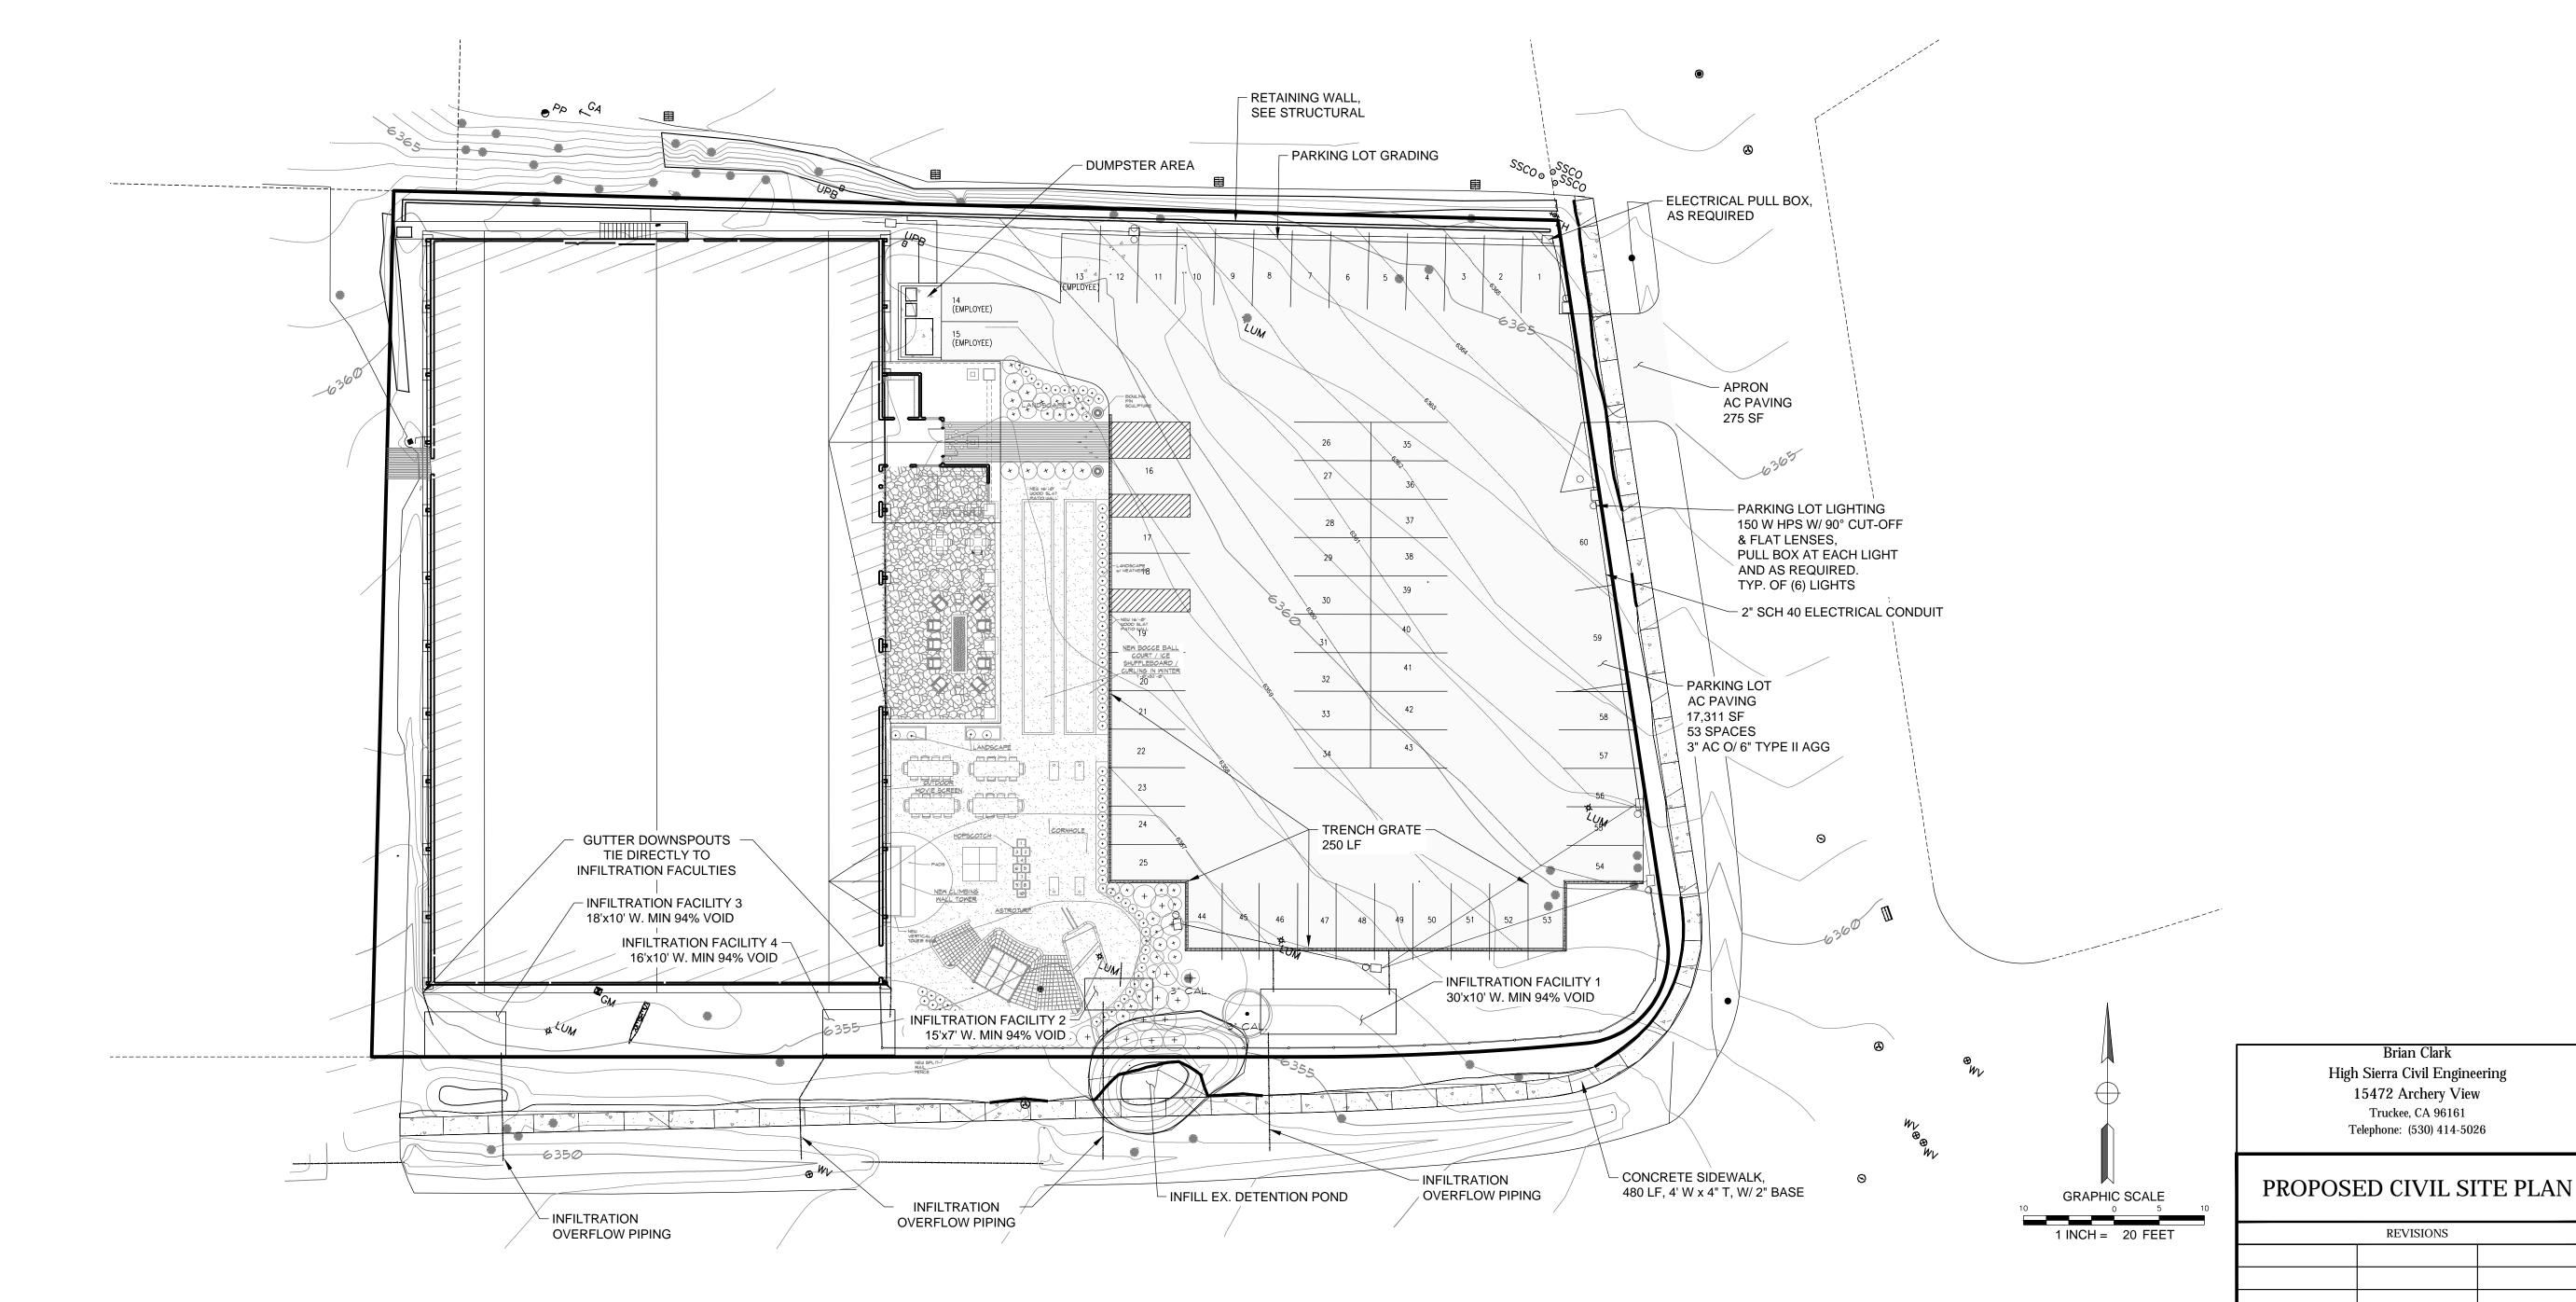

THE CONTRACTOR SHALL CALL "UNDERGROUND SERVICE ALERT (USA)" AT (800) 642-2444 TWO (2) DAYS MINIMUM TO FOURTEEN (14) DAYS MAXIMUM PRIOR TO COMMENCING EXCAVATION.

Incline Village Washoe County, Nevada DENNIS E. ZIRBEL

Brian Clark

High Sierra Civil Engineering

15472 Archery View

Truckee, CA 96161

Telephone: (530) 414-5026

REVISIONS

BOWL INCLINE

RENOVATION/REMODEL

920 Southwood Boulevard

IMPROVEMENT QUANTITIES (APPROXIMATE)

17,586 SF

480 LF

250 LF

200 LF (+/-)

CUT: 215 CY

FILL: 77 CY

AC PAVING & AGG BASE

CONCRETE SIDEWALK

DRAINAGE FACILITIES

DRAINAGE PIPING, 6" PVC

LIGHTS W/ PULL BOX & LIGHT POLE BASE

TRENCH GRATE

(PREFAB W/ MIN. 94% VOID SPACE)


(LOT & APRON)

GRADING


ARCHITECT A PROFESSIONAL CORPORATION P.O. Box 296 Truckee, CA 96160 Telephone: 530.582.8979

Fax: 530.582.8938 www.zirbelarchitect.com DRAWN: HSCE - BC

12/8/2020 1" = 20' SCALE: 2017 OB No.:

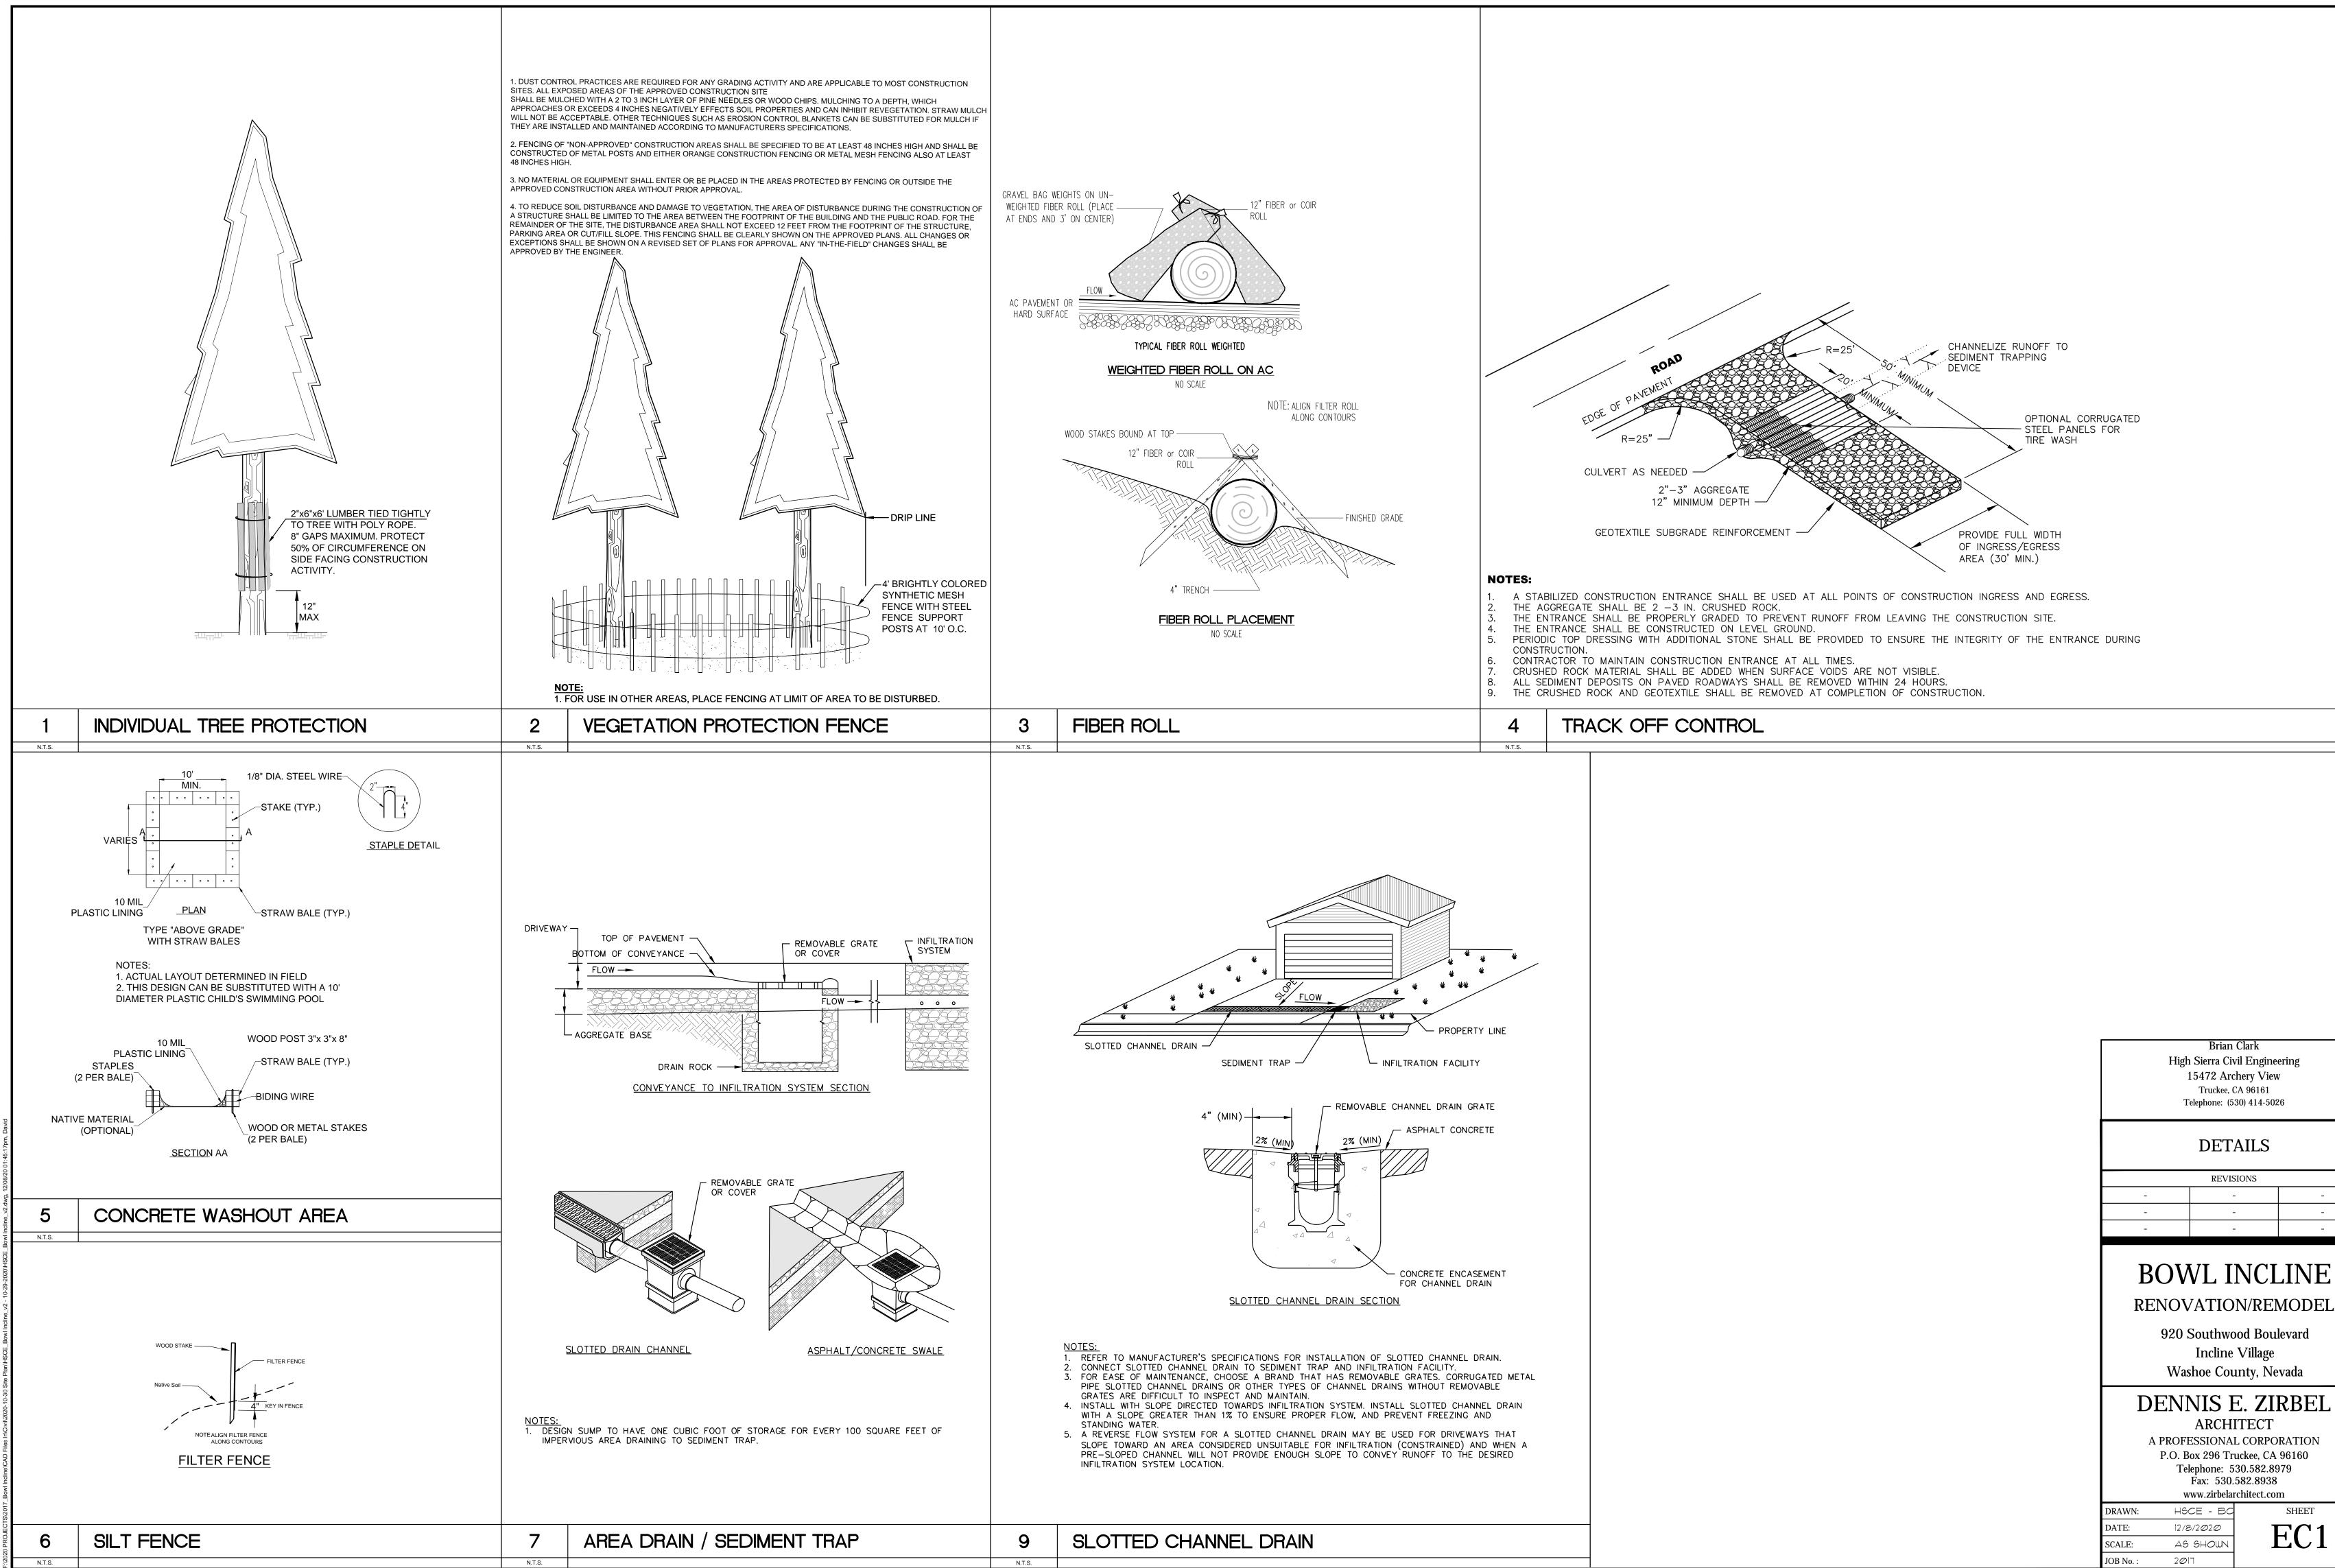

EC1

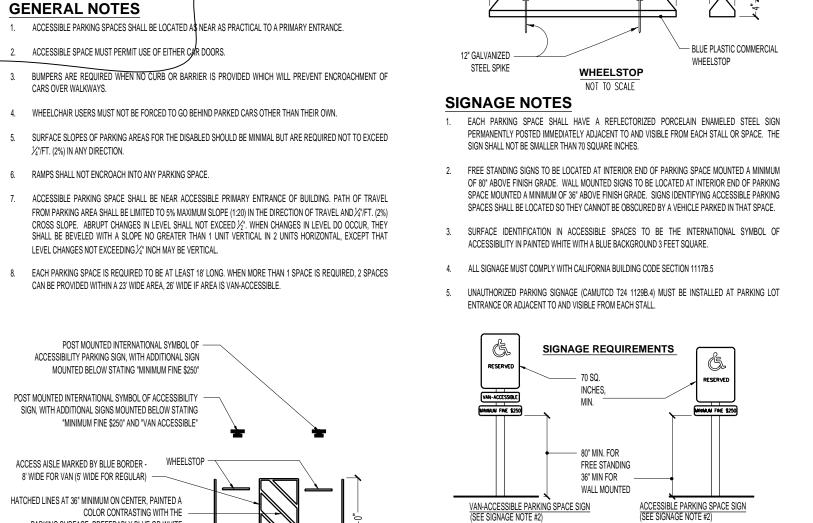

PARKING SURFACE, PREFERABLY BLUE OR WHITE

WORDS "NO PARKING" PAINTED IN

WHITE ON THE GROUND-MINIMUM 12" HIGH

8' FOR VAN ACCESSIBLE PARKING -


ADJACENT ACCESSIBLE PARKING AS REQUIRED ——

36" SQUARE INTERNATIONAL SYMBOL OF ACCESSIBILITY PAVEMENT SIGN




BACKGROUND


WHITE SYMBOL & —— BACKGROUND

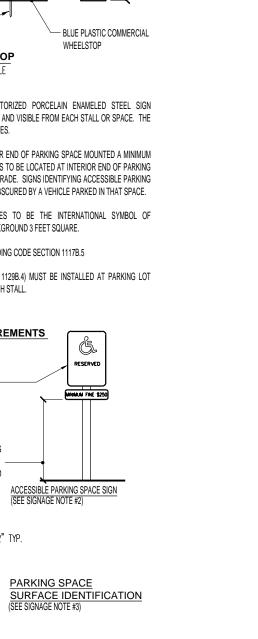

PARKING SPACE

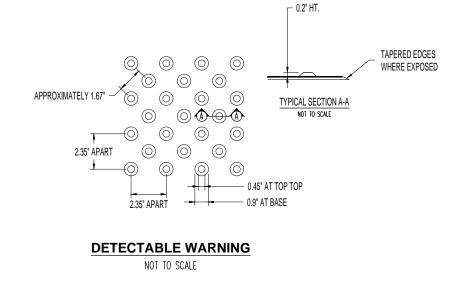



TRUNCATED DOMES NOT TO SCALE

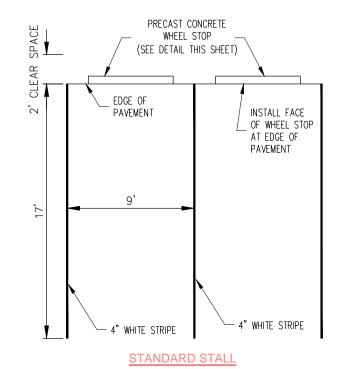

PARKING STALL DETAILS (3)NOT TO SCALE

|**~** 2' MIN. **→**

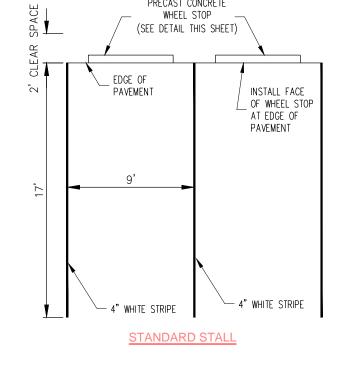

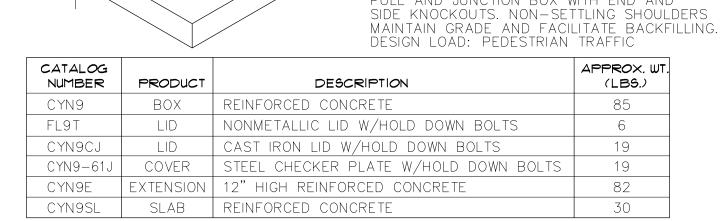

FOR COMPLETE DESIGN AND PRODUCT INFORMATION, CONTACT JENSEN PRECAST.

NOTE: METRIC DIMENSIONS

• ETCHED POLYETHYLENE FACE NO. 3-1/2 ELECTRICAL

19-3/4"

(500)

PULL BOX

JENSEN PRECAST N9

SPECIFICATION

CYN9T/FL9T/CYN9CJ

BEAD WELDED

STEEL COVERS FIT

OVER ENTIRE BOX

MARKINGS

A HIGH DENSITY REINFORCED CONCRETE


PULL AND JUNCTION BOX WITH END AND

MEETS ADOT NO. 3-1/2

• FACE ANCHORED IN CONCRETE


• ULTRAVIOLET INHIBITOR


ROUNDED TO NEAREST 5 MM.

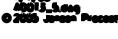

(305)



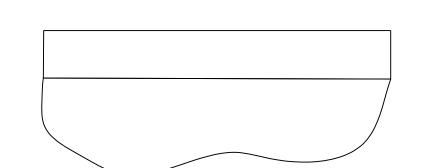

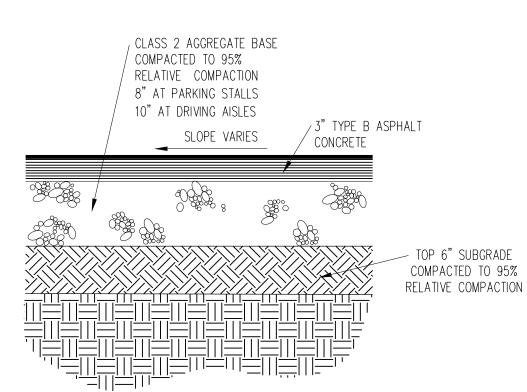





920 Southwood Boulevard Incline Village Washoe County, Nevada

-


-

Brian Clark High Sierra Civil Engineering 15472 Archery View Truckee, CA 96161


DENNIS E. ZIRBEL ARCHITECT

A PROFESSIONAL CORPORATION P.O. Box 296 Truckee, CA 96160 Telephone: 530.582.8979 Fax: 530.582.8938

HSCE - BC 12/8/2020 AS SHOWN 2017

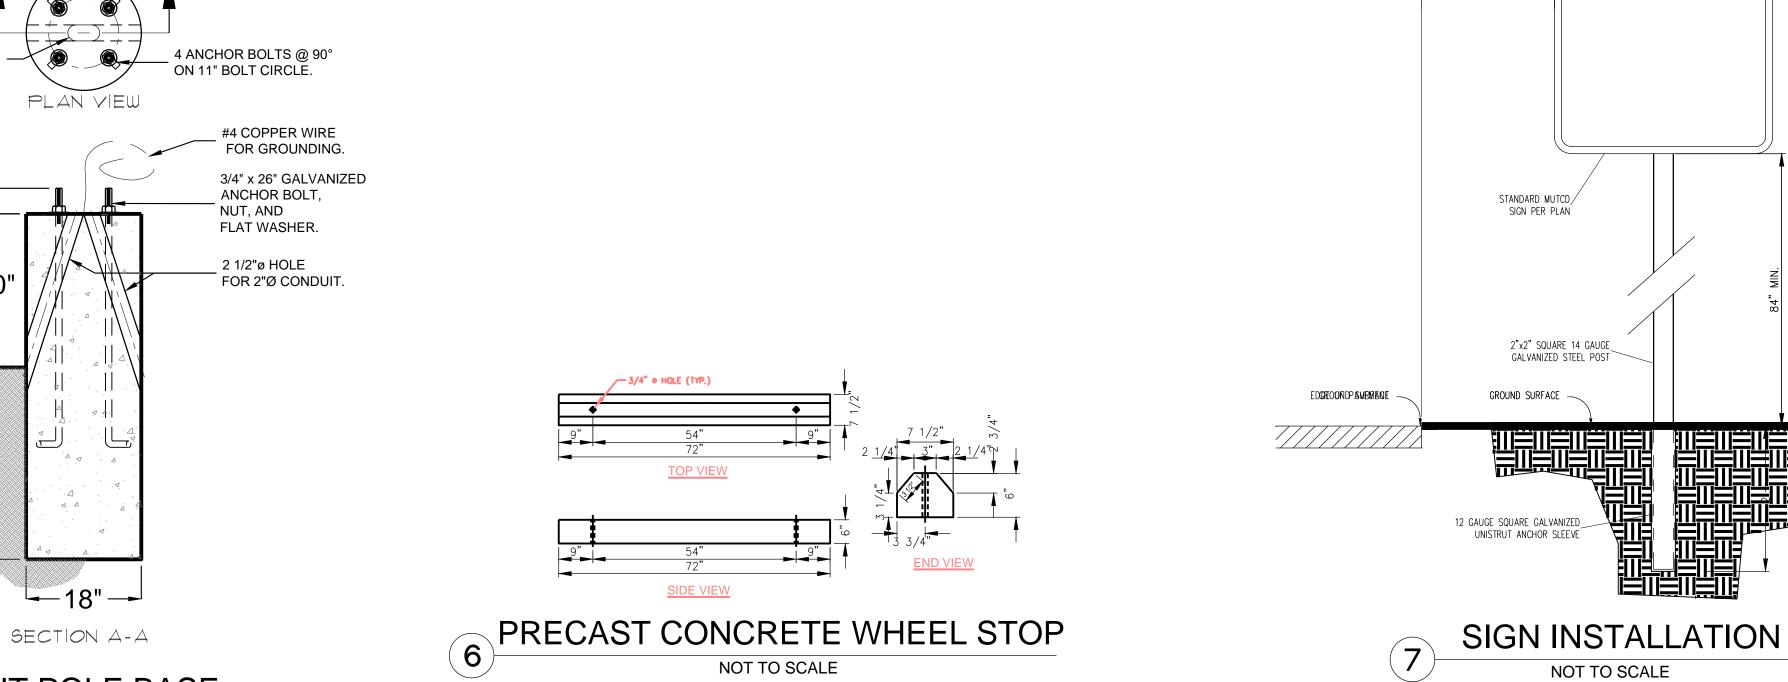


NOT TO SCALE

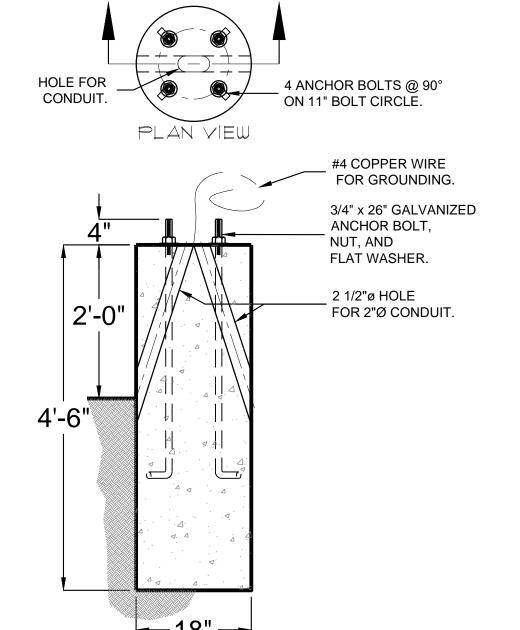



LIGHT POLE BASE NOT TO SCALE

5

www.zirbelarchitect.com

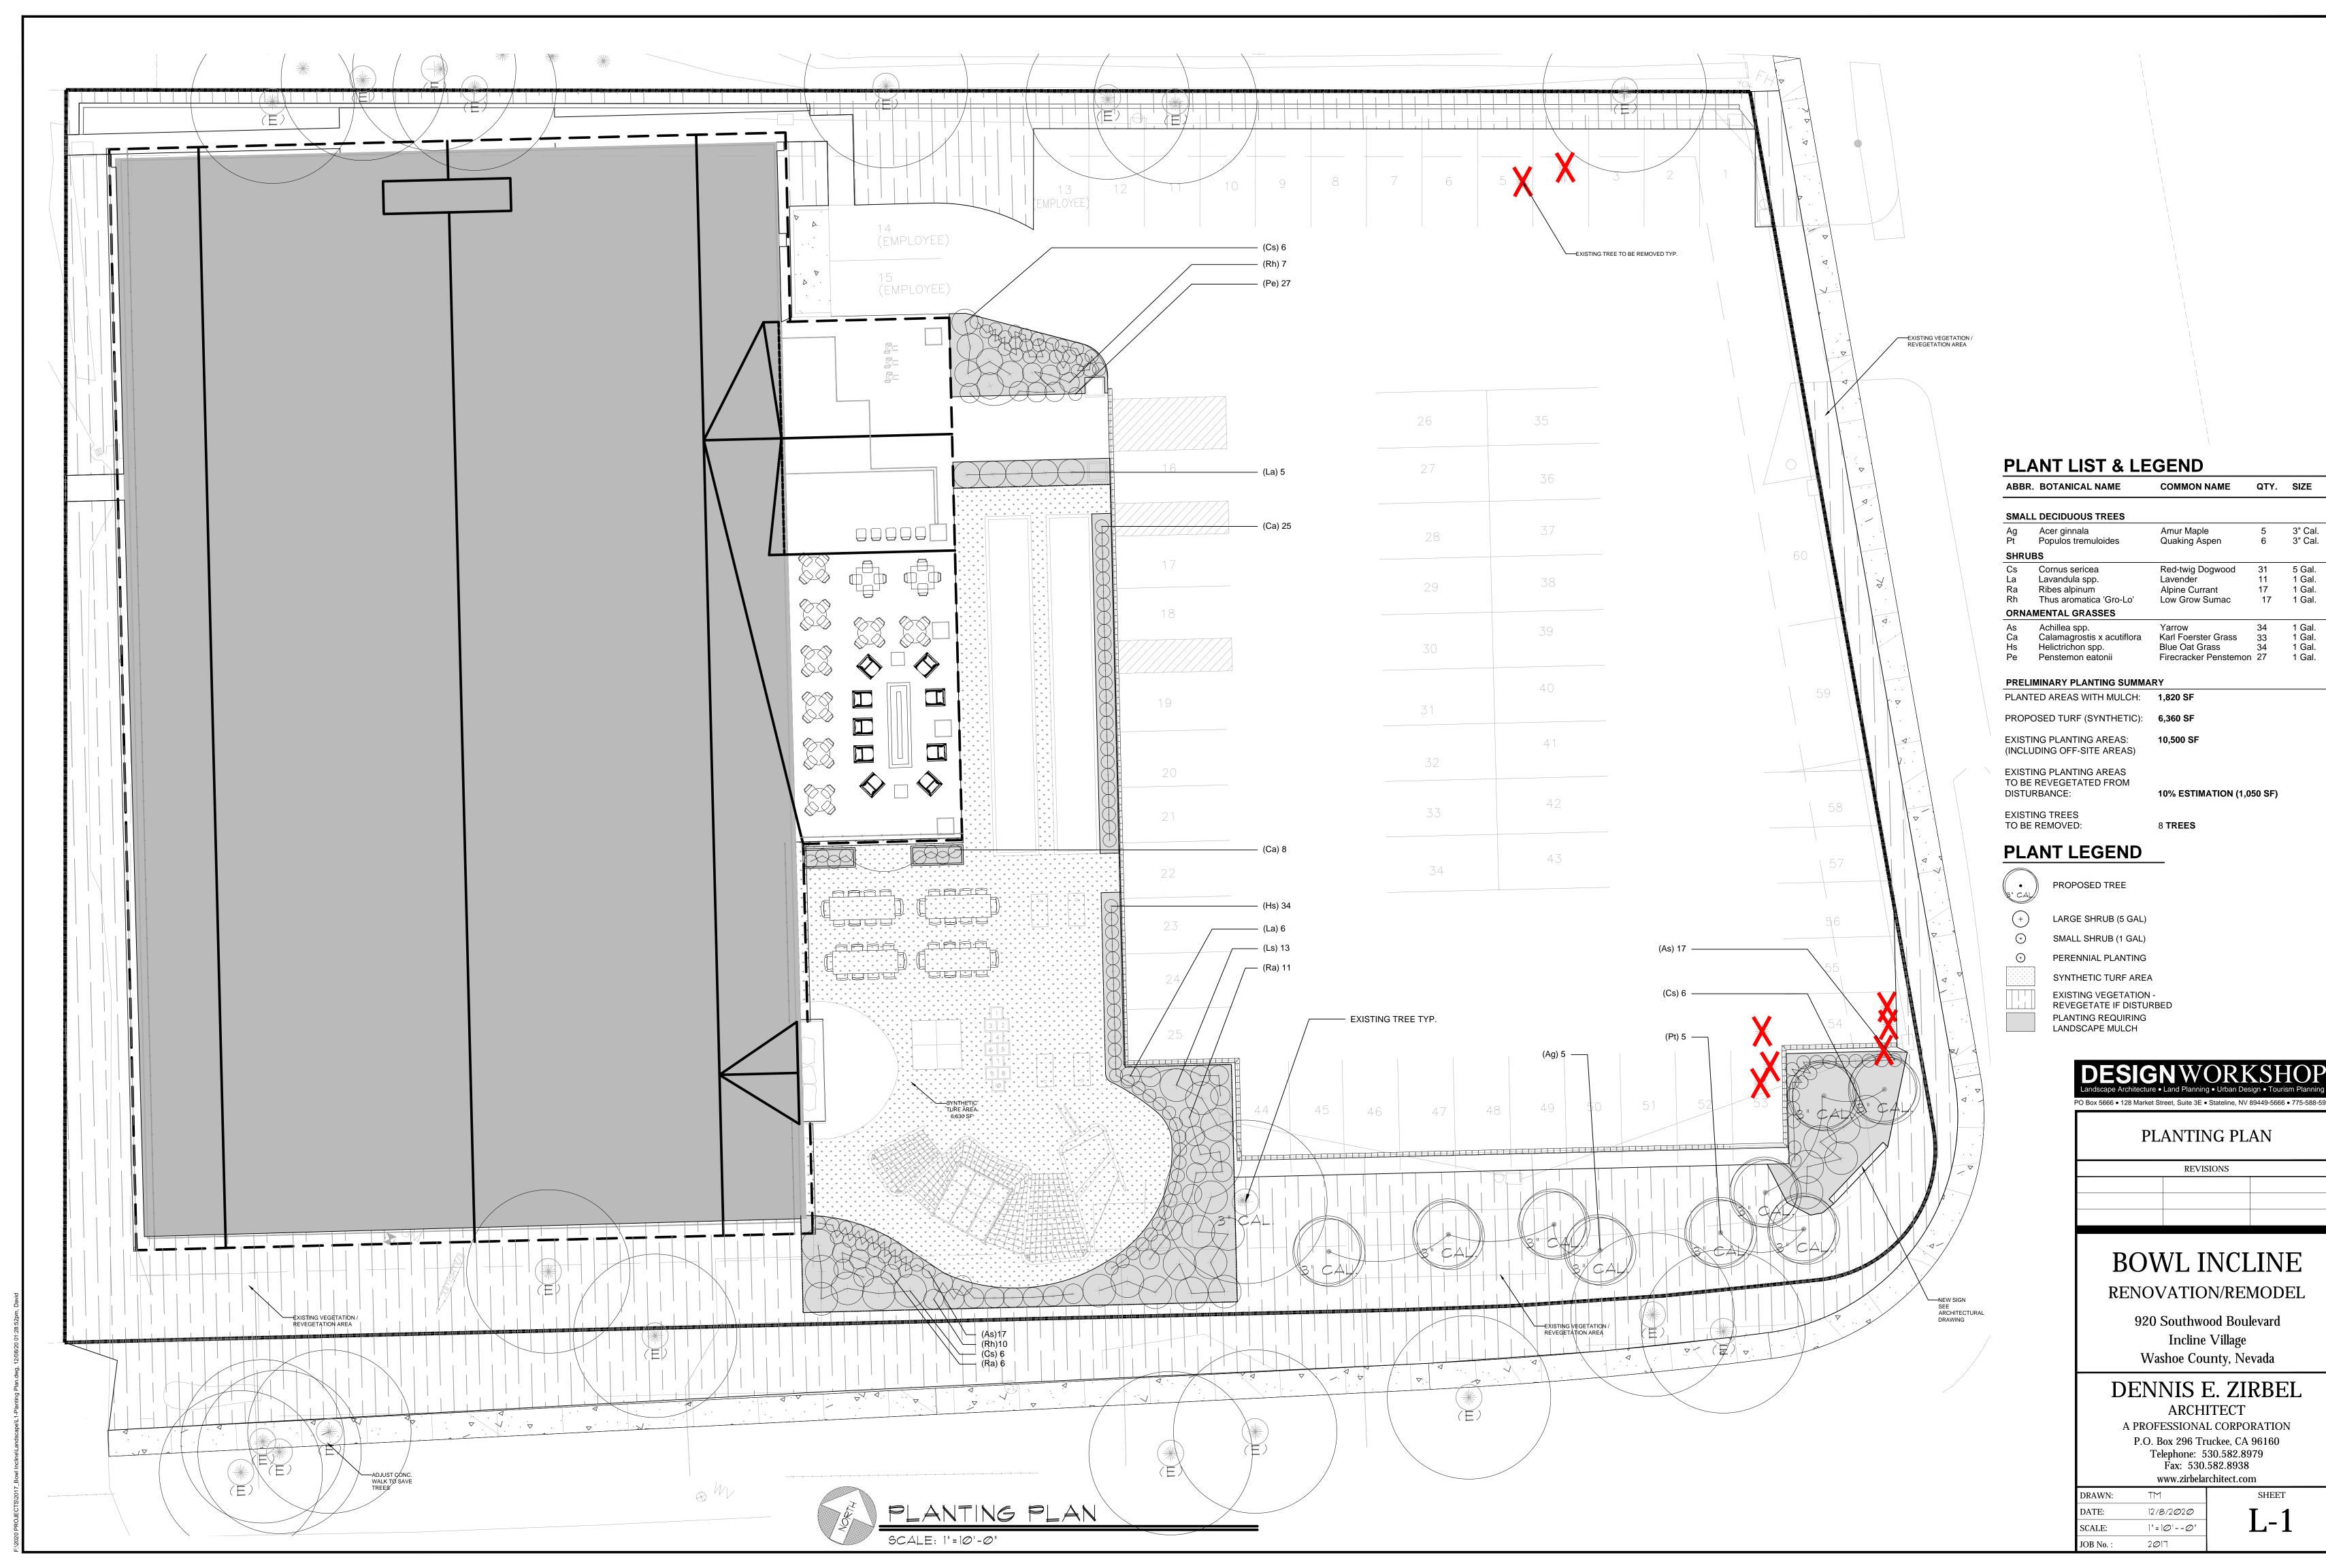

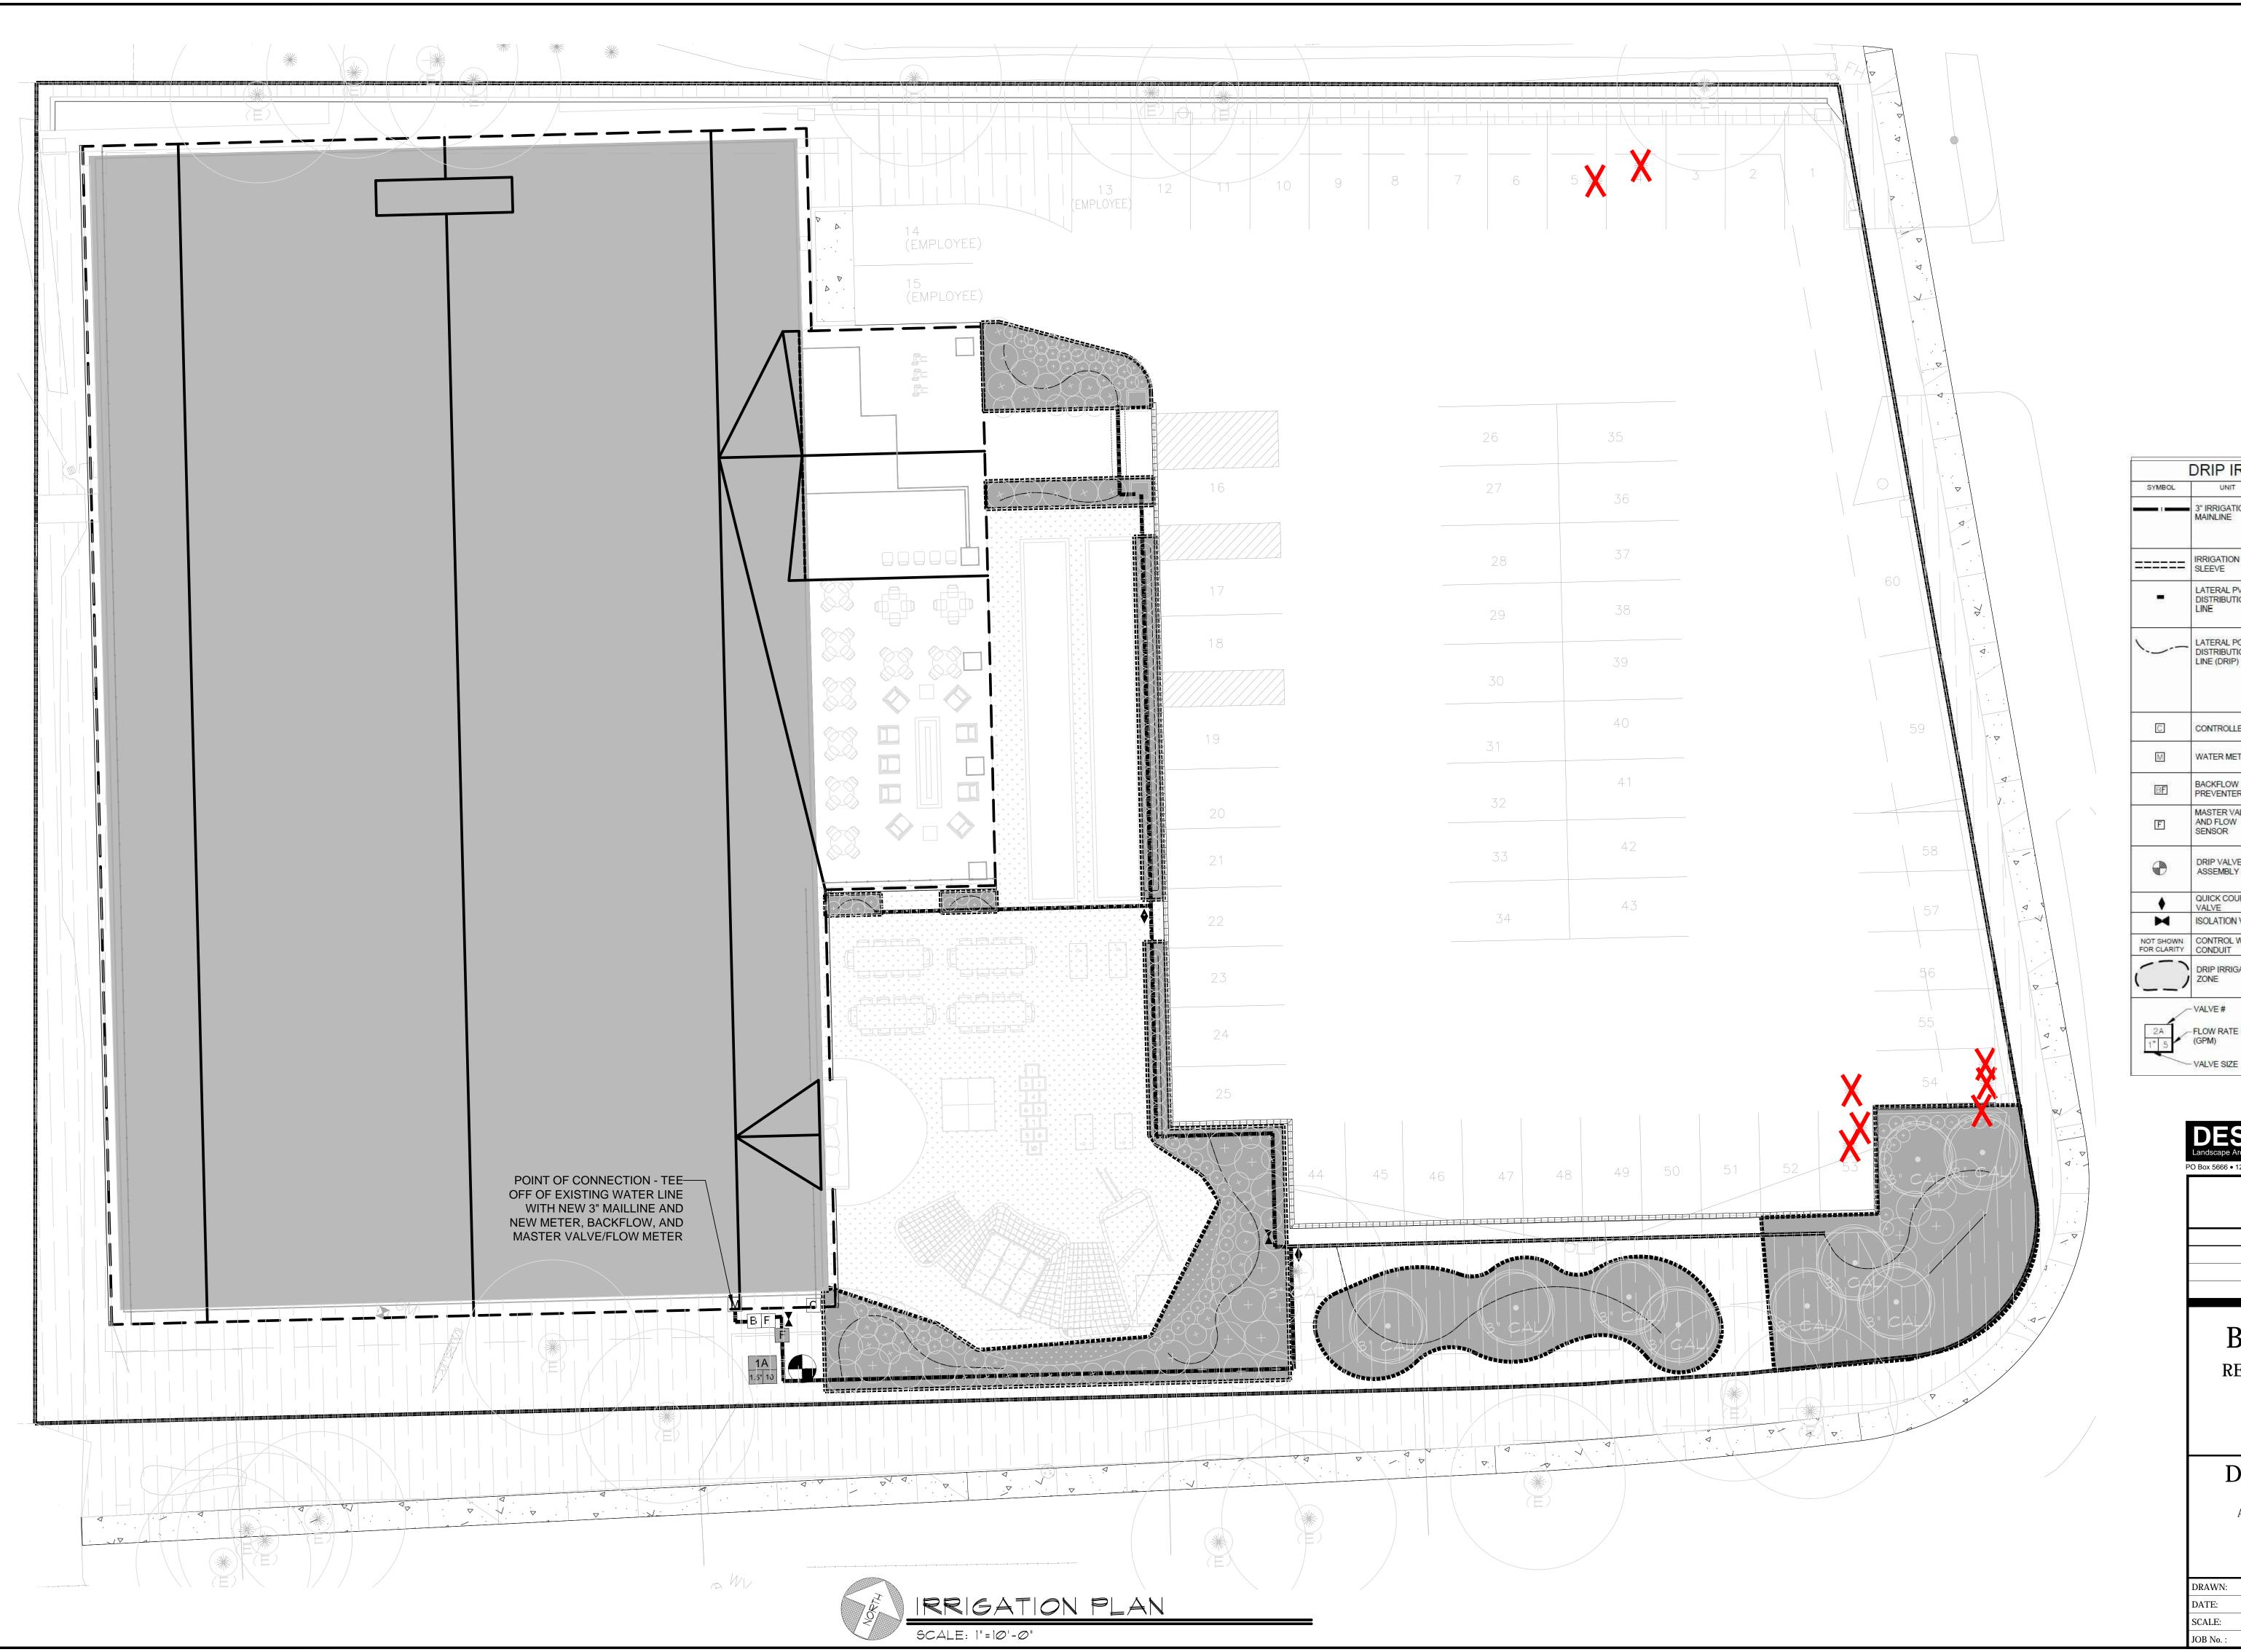

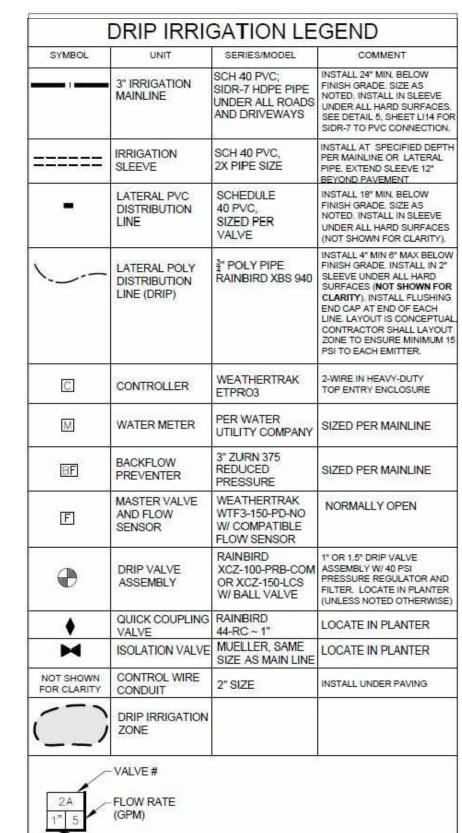

IRRIGATION PLAN

REVISIONS

BOWL INCLINE

RENOVATION/REMODEL

920 Southwood Boulevard Incline Village

Washoe County, Nevada

DENNIS E. ZIRBEL

ARCHITECT A PROFESSIONAL CORPORATION P.O. Box 296 Truckee, CA 96160 Telephone: 530.582.8979 Fax: 530.582.8938

www.zirbelarchitect.com

	WWW.Zhi bela	remeeet.com
DRAWN:	DE/YM	SH
DATE:	12/8/2020	Т Т
SCALE:	1"=10"-0"	L
JOB No.:	2017	

MEATHERTRAK ET PROS 2-MIRE TOP ENTRY ENCLOSURE

Wire Length Limits for the 2-Wire Path

WeatherTRAK 2-Wire provides easy installation and wire extending options. This section describes the 2-wire path length limits both worst-case and typical.

Typical 2-Wire Path Length Limits

This represents the typical scenario where decoders are installed evenly along the 2-wire path.

Number of simultaneous	Valves evenly distributed along 2-wire (ft.)			
valves	AWG 16	AWG 14		
1	11,000	17,800		
2	10,200	16,300		
3	8,800	14,100		
4	7,800	12,500		
5	7,000	11,200		
6	6,300	10,100		
7	5,800	9,200		
8	5,300	8,500		

Worst Case 2-Wire Path Length Limits

This represents the worst-case scenario where all the installed decoders are at the end of the

Number of	Maximum wire length (ft.) assuming #16/2-wire	
active valves		
on 2-wire path		
1	6,200	
2	5,600	
3	4,900	
4	4,300	

Station Decoder to Solenoid

1 STAINLESS STEEL AUTOMATIC CONTROLLER ENCLOSURE ASSEMBLY. SEE IRRIGAITON LEGEND

3 WEATHERTRAK ET PRO3 2-WIRE CONTROLLER. SEE DRAWINGS AND SPECIFICATIONS FOR

6 OPTIONAL CONVENTIONAL FLOW SENSOR CABLE AND MASTER VALVE WIRES PER

8 1" PVC SWEEP ELL AND CONDUIT FOR 120 VAC FROM METERED POWER SUPPLY.

(14) RAIN SENSOR WITHIN VIT RAIN SENSOR ENCLOSURE (PT# RGVRSS) PER SPEC.

9 2" PVC SWEEP ELL AND CONDUIT FOR OPTIONAL CONVENTIONALLY WIRED FLOW SENSOR

NOTE: MINIMUM CONCRETE BASE REQUIREMENTS. CONTRACTOR SHALL VERIFY NUMBER AND SIZE

OF CONDUITS REQUIRED FOR EACH ENCLOSURE INSTALLATION. USE ENCLOSURE MANUFACTURER'S

TEMPLATE FOR PROPER LAG BOLT PLACEMENT. PROVIDE A MINIMUM 2" OF CONCRETE FROM LAG

AND MODEL. 2 LOW PROFILE ANTENNA

(4) INFORMATION. CONTROLLER TRANSFORMER.

AND MASTER VALVE WIRES.

10 POURED CONCRETE BASE. SLOPE TO DRAIN

12 FILL VOIDS WITH CONCRETE SLURRY MIX.

11) FINISH GRADE. 2" BELOW TOP OF CONCRETE BASE.

BOLT TO OPENING IN CONCRETE BASE FOR CONDUITS.

13 NEATLY BUNDLE WIRES AND SECURE WITH WIRE TIRES. (TYPICAL)


5 GFI ON/OFF POWER SWITCH RECEPTACLE. (OPTIONAL)

SPECIFICATIONS.

3" PVC SWEEP ELL AND CONDUIT FOR CONTROL WIRES.

ADDITIONAL

Each irrigation control valve must be connected to a WeatherTRAK 2-Wire Station Decoder (WT2W-SVD-11). Each station decoder is programmed with a station number. The station decoder must be connected to the 2-wire path and the solenoid using the included 3M DBR/Y-6 splice kits. The decoder and splice kits should be based in a valve box for easier troubleshooting and diagnostics.

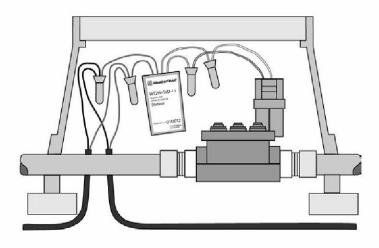

WeatherTRAK 2-Wire systems are NOT compatible with the following solenoids:

- DC latching solenoids
- Toro Spike-Guard™ solenoids
- Netafim Aquative Plus® solenoids

Rain Bird DV Series valve solenoids are NOT recommended for use with the WeatherTRAK 2-Wire system due to their high current draw.

CONTROLLER NOTES:

WEATHERTRAK 2 WIRE COMPONENTS FOR CARSON CITY IRRIGATION SYSTEM

WIRING:

- 1. WIRING TYPE TO BE DOUBLE-JACKETED PVC TWO-CONDUCTOR SOLID CORE, WITH 3/16" INSULATION HIGH DENSITY AND SUNLIGHT RESISTANT. POLYETHYLENE OUTER JACKET TO CONFORM WITH ICEA S-GL-402, WITH A WALL THICKNESS OF .045 INCHES. ALL WIRE INSULATION SHALL BE INTACT, FREE OF ANY NICKS OR CUTS. WIRE SIZE TO BE #14, WITH A MAXIMUM DISTANCE TO THE FURTHEST VALVE SET PER MANUFACTURERS RECOMMENDATIONS.
- 2. CONNECTORS TO THE DECODERS TO BE TW-SPLICE-14 OR EQUAL GEL FILLED CONNECTORS. CONTRACTOR TO TEST ALL CONNECTIONS BEFORE IMMERSING THE WIRE NUT IN THE GEL-FILLED CAP. TWIST WIRES TO PROVIDE A SOLID MECHANICAL CONNECTION BEFORE SECURING THE ATTACHMENT BY ADDING THE WIRE NUT. ADHERE TO ALL LOCAL AND NATIONAL BUILDING AND ELECTRICAL CODES.

GROUNDING RODS AND PLATES

RESISTANCE, ITEM A.

- 1. ALL GROUNDING RODS SHALL BE BARE COPPER OF 5/8" DIAMETER OR LARGER AND 8 FEET LONG OR LARGER.
- 2. ALL GROUNDING PLATES SHALL BE 4" X 96", AS OUTLINED IN THE ASIC EARTH GROUNDING GUIDELINES. 100-2002 3. A MEASURED RESISTANCE READING OF NO MORE THAN 25 OHMS IS REQUIRED AT EACH LIGHTNING ARRESTOR ARRESTOR TO BE TW-LA-1, INSTALLED EVERY 500 FEET ALONG THE TWO WIRE PATH. INSTALL IN AN IRRIGATION VALVE BOX SET TO PLANTER GRADE. ARRESTOR TO BE CONNECTED TO THE TWO-WIRE CABLE THAT MEETS
- 4. ALL CONNECTIONS TO THE GROUNDING RODS SHALL CONFORM TO ASIC EARTH GROUNDING GUIDELINE 100-2002 AND SHALL CONSIST OF A "CADWELD" TYPE OF CONNECTION.

RAIN MASTER'S TW-CAB-14 CABLE SPECIFICATIONS. REFER TO ASIC SPEC SECTION 7.0 - MEASURING

VALVE DECODERS


1. DECODERS SHALL BE LOCATED AT EACH VALVE (1 PER VALVE). LOCATE THE DECODERS PER MANUFACTURER'S RECOMMENDATIONS. DECODERS SHALL BE WEATHERTRAK DECODER, OR APPROVED EQUIVALENT THAT IS COMPATIBLE WITH CONTROLLER.. INSTALL DECODERS PER MANUFACTURER'S RECOMMENDATIONS.

FLOW SENSOR

- 1. THE FLOW SENSOR SHALL BE WEATHERTRAK FLOW3 HYDROMETER WITH POWER SUPPLY AND UNION PHOTO DIODE HYDROMETER, 1.5", 1.8-55 GPM, MAX 235 PSI. PVC SLIP TYPE CONNECTION. APPROXIMATE PRESSURE AT THE EXISTING POINT OF CONNECTION IS APPROXIMATELY 70 PSI - CONTRACTOR TO TEST PRESSURE FOR VERIFICATION.
- 2. INSTALL THE FLOW SENSOR IN THE PLANTER WITH THE POINT OF CONNECTION CONFORMING TO THE REQUIREMENTS FOR PIPE SPACING BETWEEN MASTER VALVE AND FLOW SENSOR.
- 3. SEE PLANS FOR THE TYPE AND LOCATION OF THE MASTER VALVE. THE MASTER VALVE SHALL BE WIRED TO THE CONTROLLER FOR AUTOMATIC SHUT- DOWN OF THE SYSTEM.

EXISTING RAINMASTER CONTROLLER RETROFIT

1. CONTRACTOR SHALL REPLACE EXISTING RAINMASTER CONTROLLER WITH SITEONE LANDSCAPE SUPPLY WEATHERTRAK 2-WIRE CONTROLLER AND CONVENTIONAL WIRE RETROFIT KIT. SEE SPEC FOR MODEL NUMBERS. CONTACT JAMES WELLER AT SITEONE LANDSCAPE SUPPLY, 1675 NICHOLS DRIVE ROCKLIN, CA 95765 (925.451.1610).

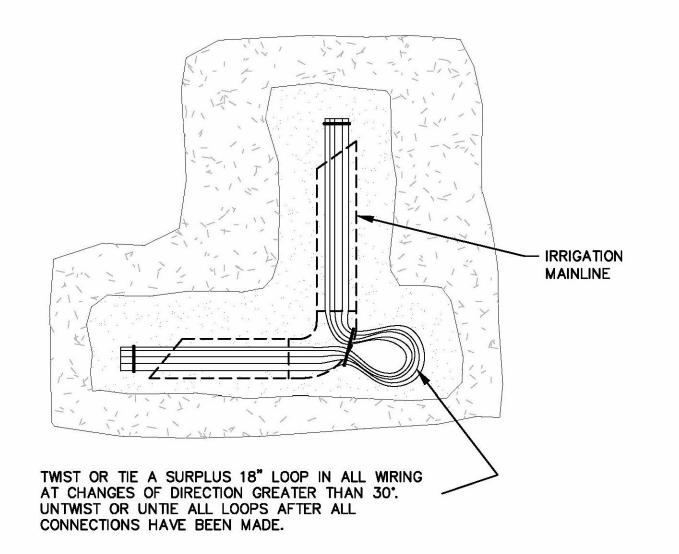

NOT TO SCALE



DESIGN WORKSHOP PO Box 5666 • 128 Market Street, Suite 3E • Stateline, NV 89449-5666 • 775-588

IRRIGATION DETAILS

REVISIONS

BOWL INCLINE

RENOVATION/REMODEL

920 Southwood Boulevard Incline Village Washoe County, Nevada

DENNIS E. ZIRBEL


ARCHITECT A PROFESSIONAL CORPORATION P.O. Box 296 Truckee, CA 96160 Telephone: 530.582.8979 Fax: 530.582.8938


www.zirbelarchitect.com

DRAWN: 12/8/2020 2Ø17

SCALE:

L-3

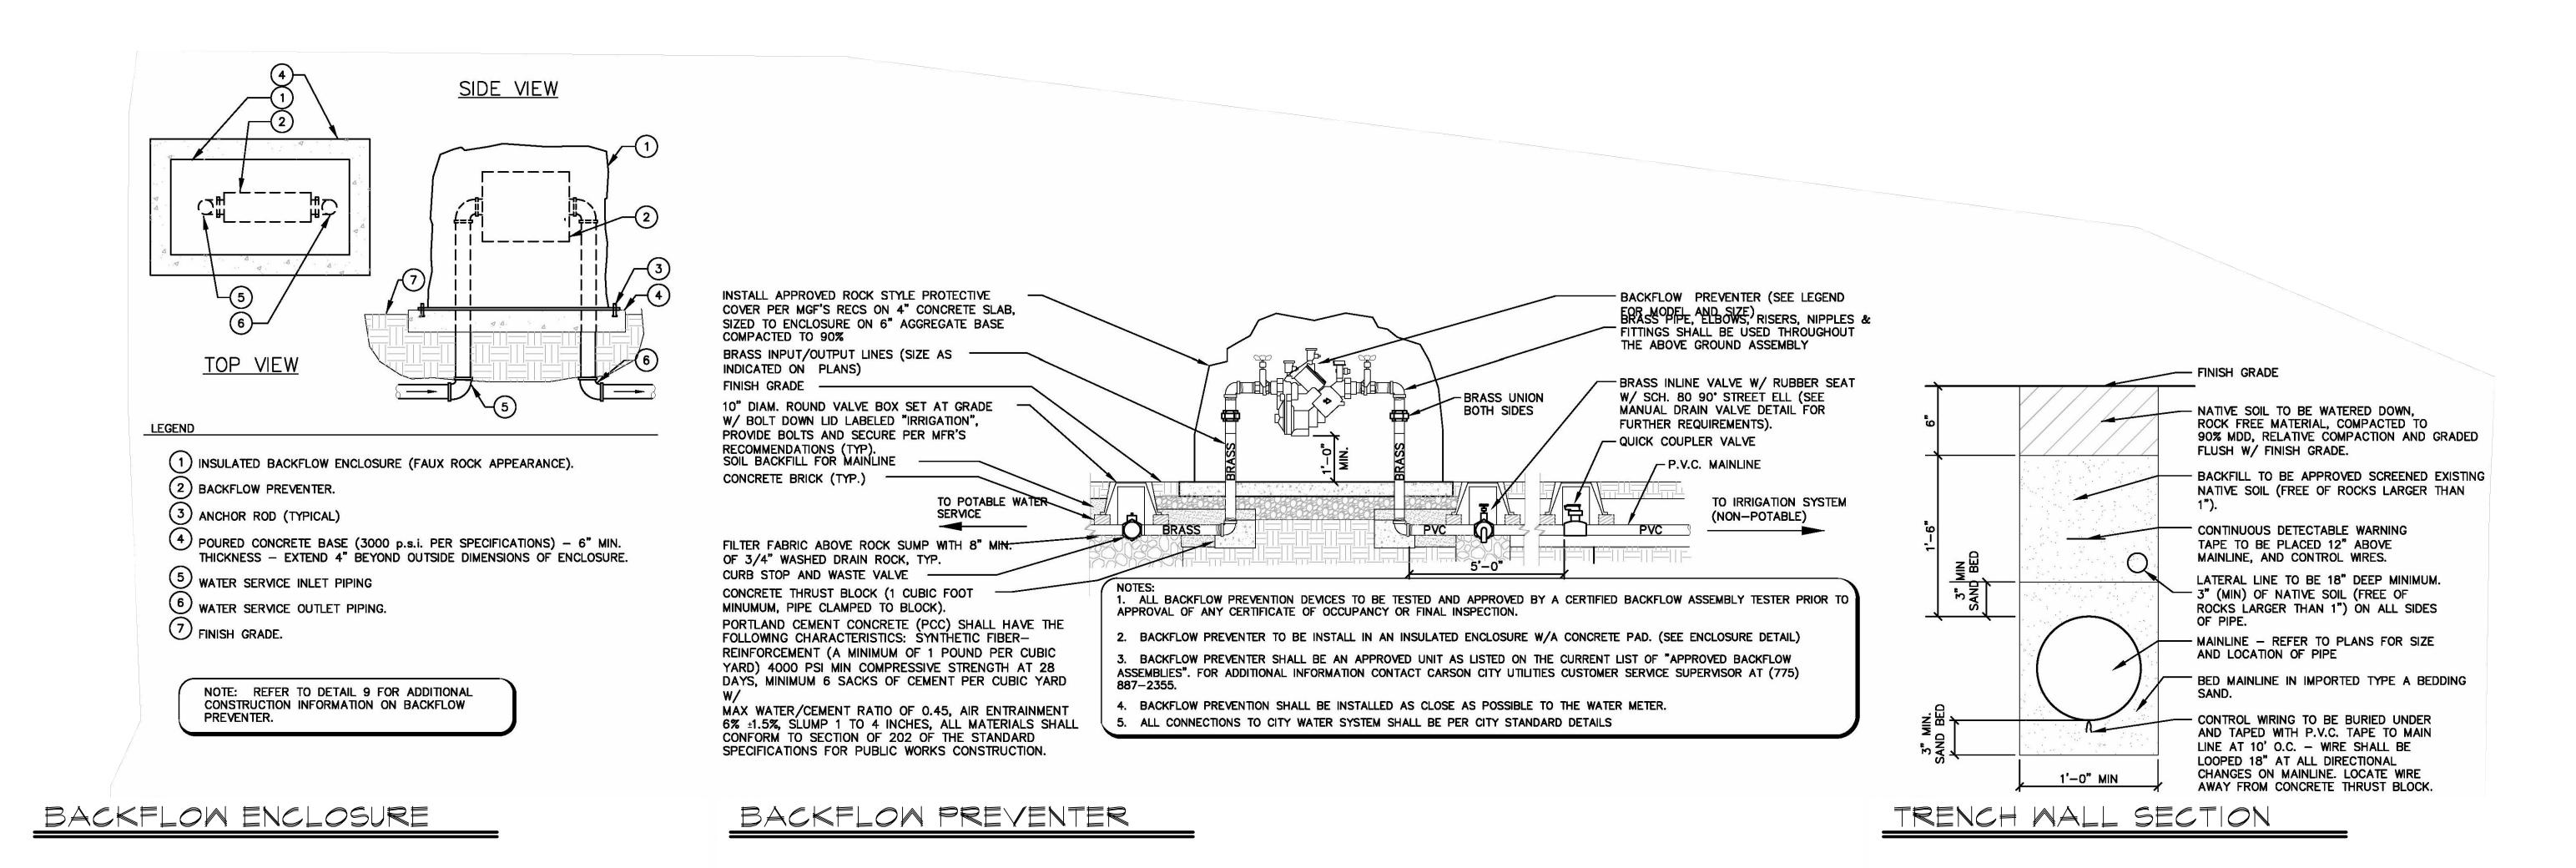

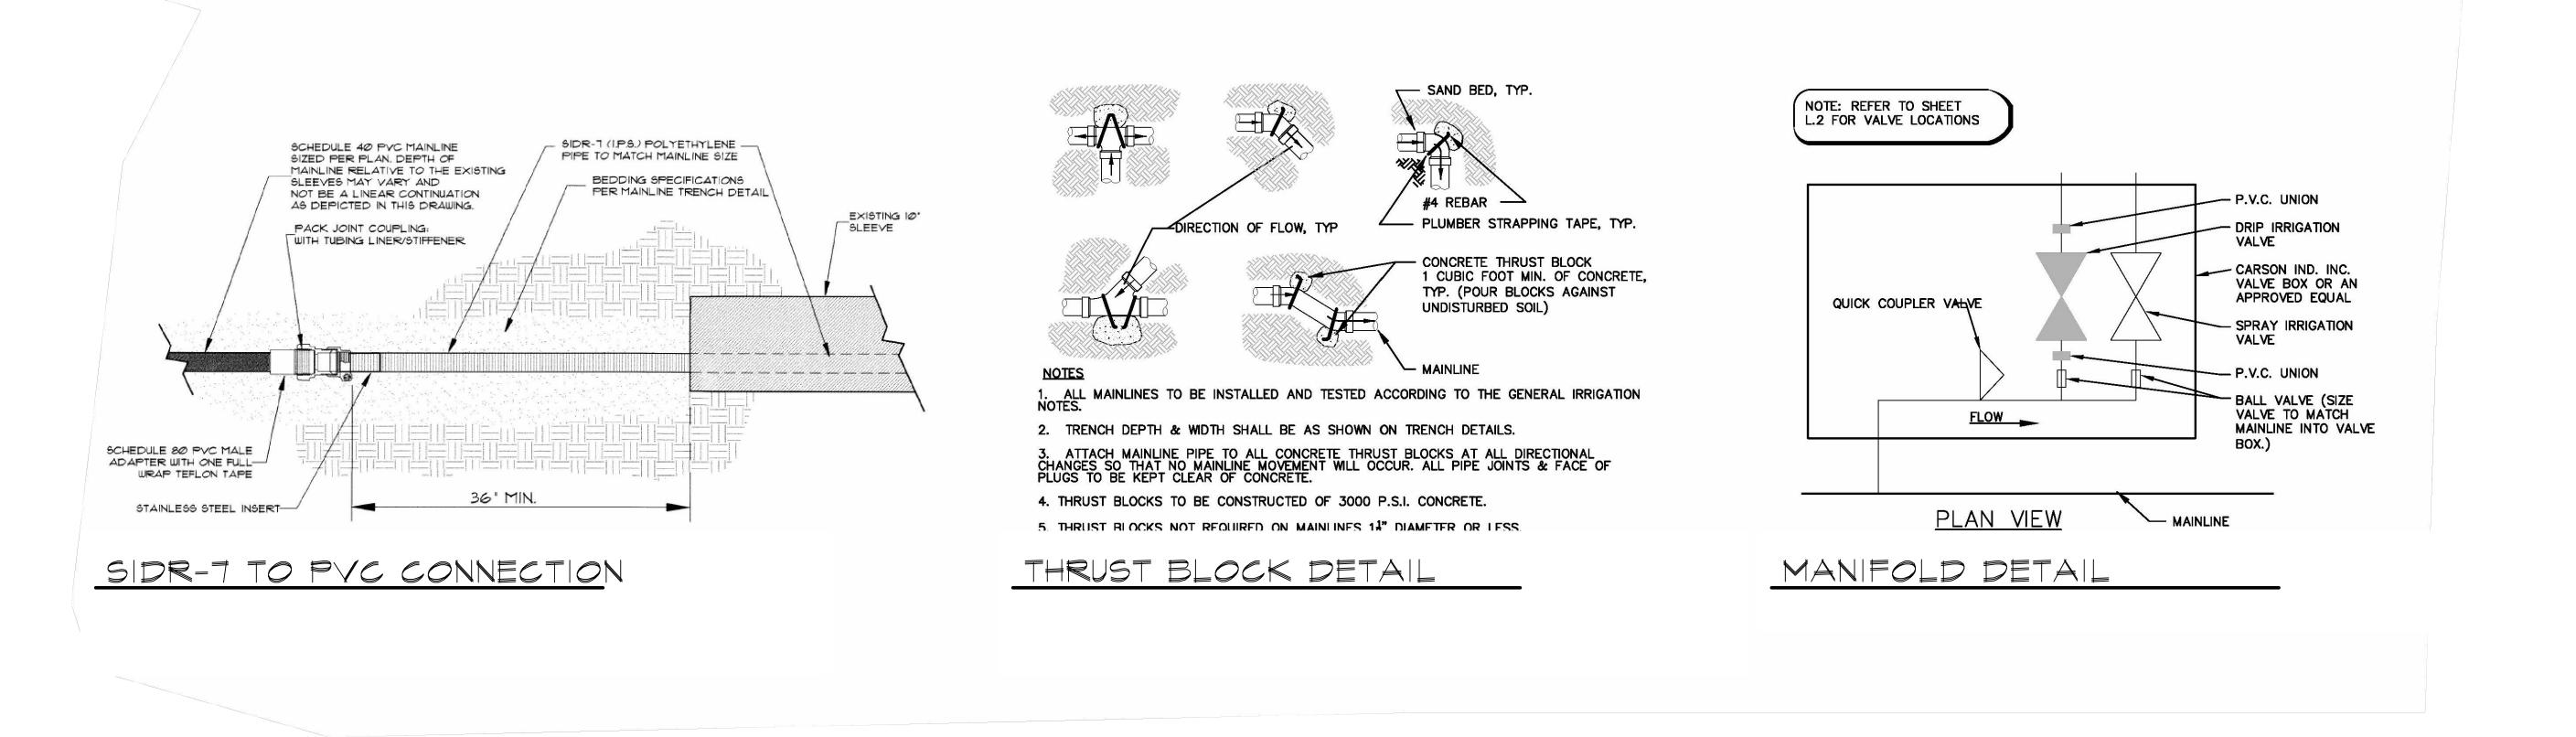

PO Box 5666 • 128 Market Street, Suite 3E • Stateline, NV 89449-5666 • 775-588-5 IRRIGATION DETAILS REVISIONS **BOWL INCLINE** RENOVATION/REMODEL 920 Southwood Boulevard Incline Village Washoe County, Nevada

DESIGN WORKSHOP

DENNIS E. ZIRBEL **ARCHITECT**


A PROFESSIONAL CORPORATION P.O. Box 296 Truckee, CA 96160 Telephone: 530.582.8979 Fax: 530.582.8938


DRAWN:


SCALE:

SHEET 12/8/2020 L-4 2Ø17

www.zirbelarchitect.com

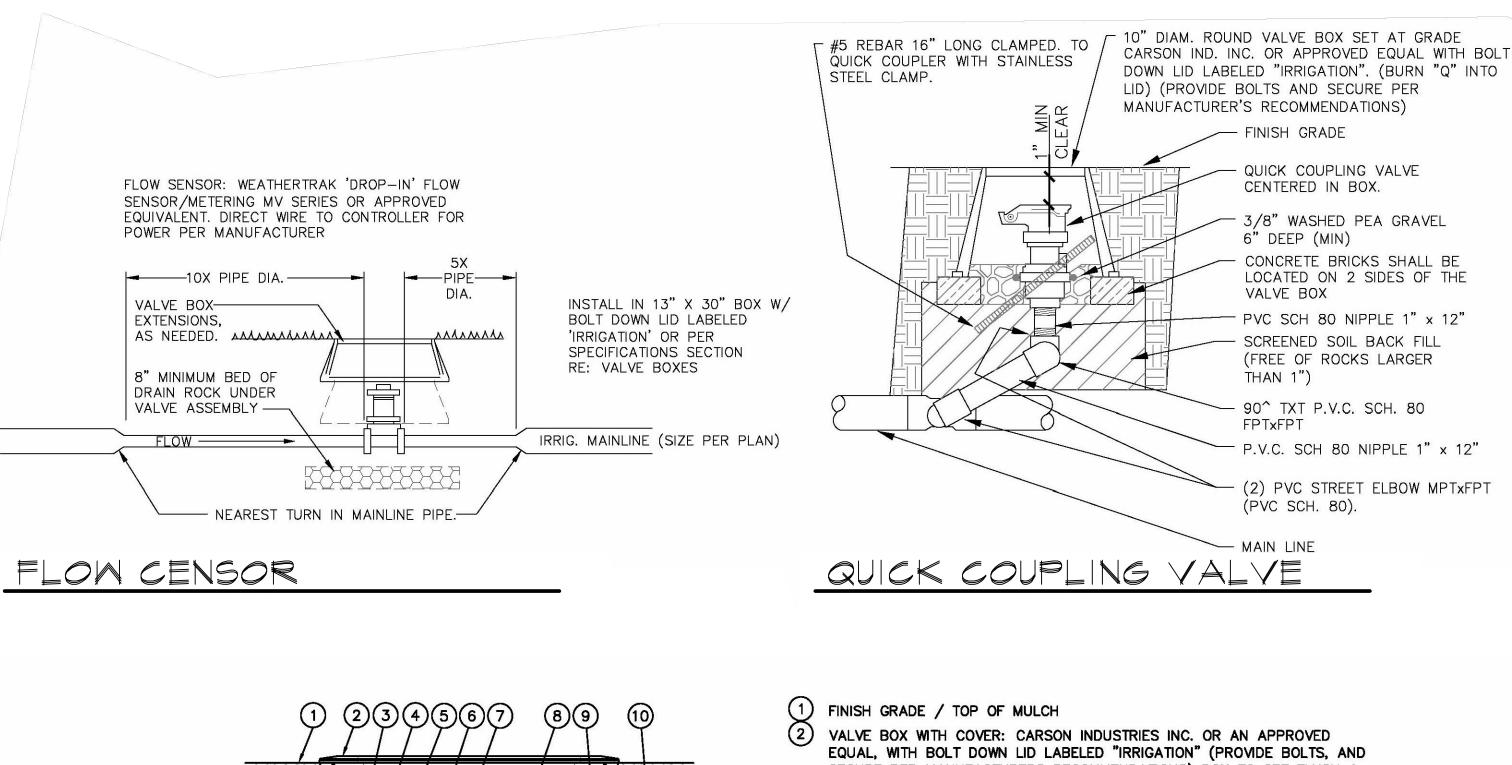


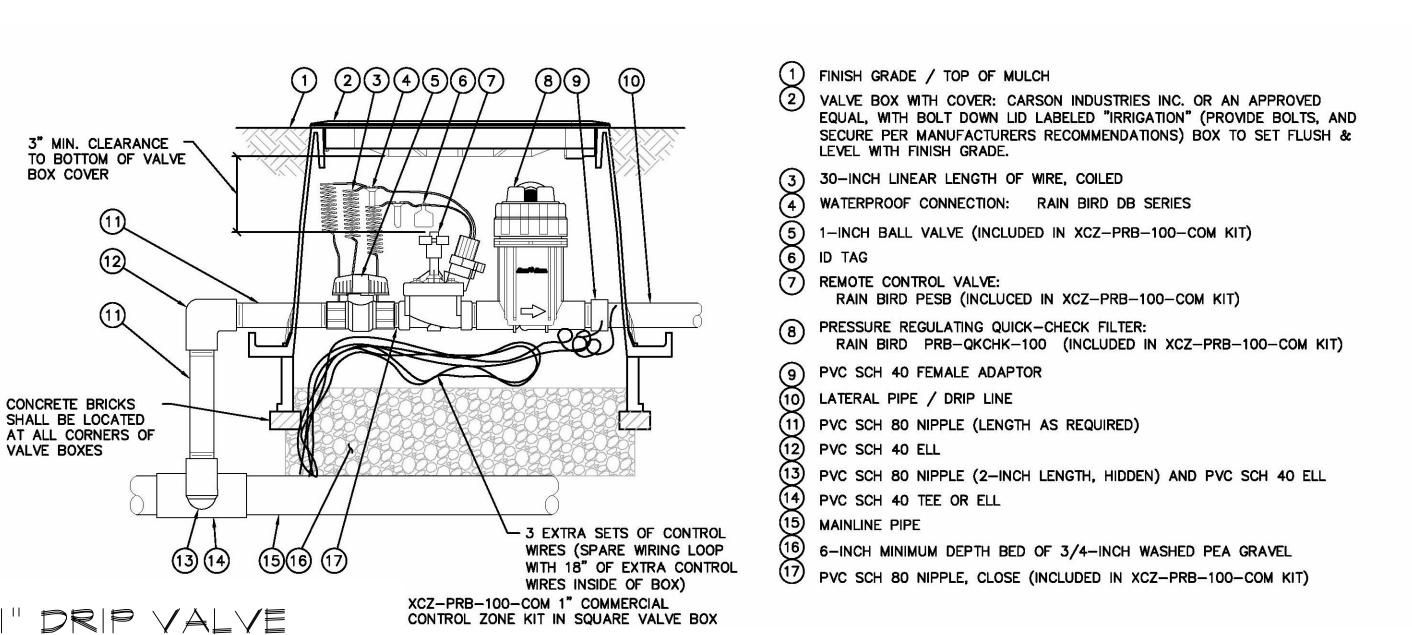

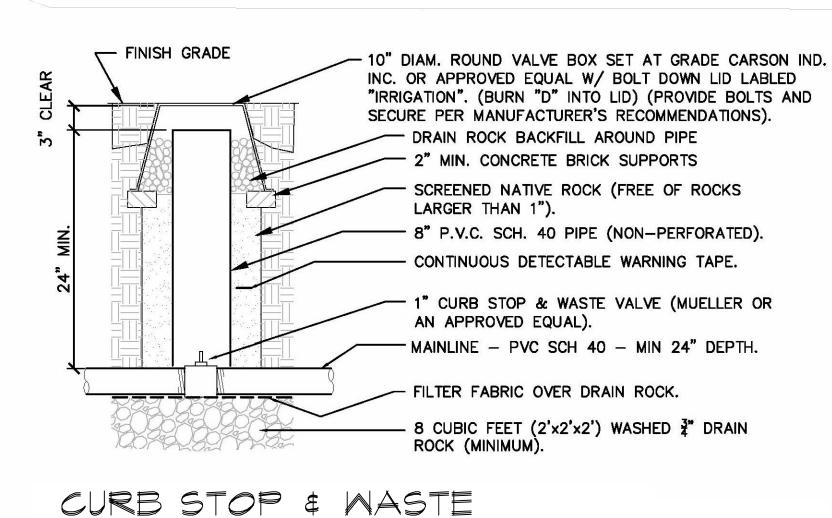

1. ALL VALVE BOXES TO BE CARSON INDUSTRIES INC. OR AN APPROVED EQUAL.

> 2. ALL DRAIN ROCK IN VALVE BOXES TO BE 3/8" WASHED PEA GRAVEL.

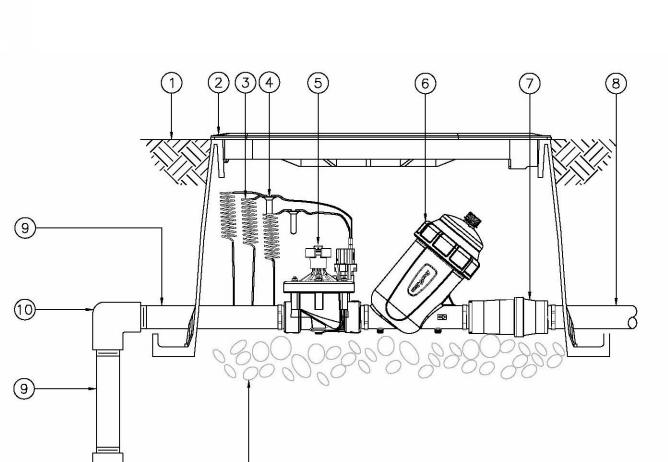

1) 12 13

1.5" DRIP VALVE

(1) FINISH GRADE/TOP OF MULCH

(2) JUMBO VALVE BOX WITH COVER: RAIN BIRD VB-JUMBO

(3) 30-INCH LINEAR LENGTH OF WIRE,

4 WATERPROOF CONNECTION: RAIN BIRD DB SERIES

(5) 1 1/2" PEB VALVE (INCLUDED IN XCZ-150-LCS KIT)

(6) 1 1/2" FILTER - RAIN BIRD LARGE CAPACITY SCREEN FILTER (INCLUDED IN XCZ-150-LCS KIT)

(7) 1 1/2" HIGH FLOW PRESSURE REGULATOR (INCLUDED IN XCZ-150-LCS KIT)

(8) LATERAL PIPE

(9) PVC SCH 80 NIPPLE 1 1/2"


(10) PVC SCH 40 ELBOW

(11) PVC SCH 80 NIPPLE (2" LENGTH, HIDDEN) AND PVC 40 ELBOW


(12) PVC SCH 40 TEE OR ELBOW

(13) MAINLINE PIPE

(14) 3" MINIMUM DEPTH OF 3/4" WASHED GRAVEL

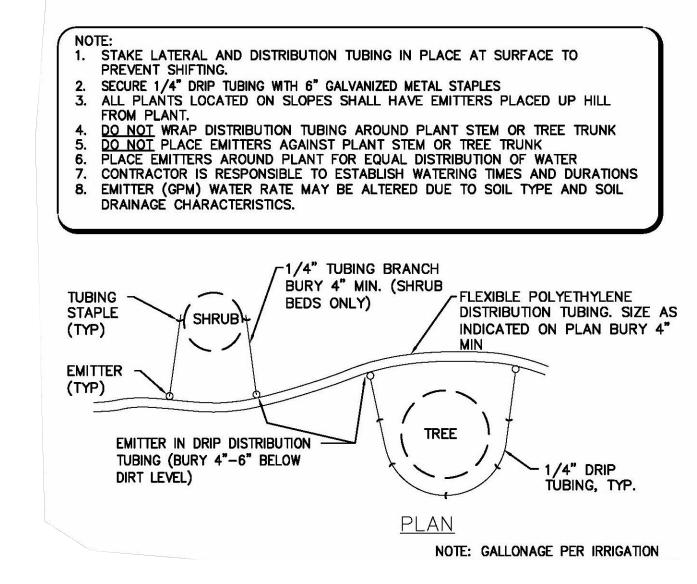

DRIP EMITTER

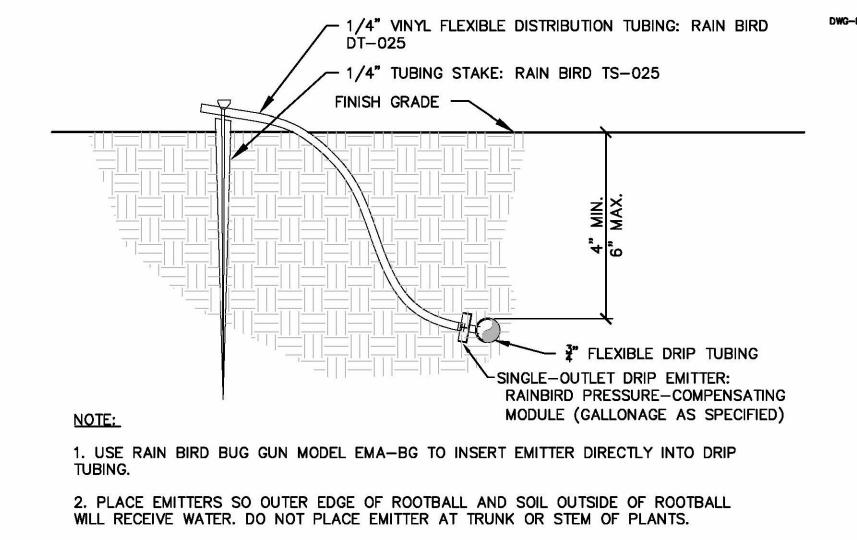

- FINISH GRADE

- QUICK COUPLING VALVE

3/8" WASHED PEA GRAVEL

CONCRETE BRICKS SHALL BE

LOCATED ON 2 SIDES OF THE

PVC SCH 80 NIPPLE 1" x 12"

- P.V.C. SCH 80 NIPPLE 1" x 12"

(2) PVC STREET ELBOW MPTxFPT

SCREENED SOIL BACK FILL

(FREE OF ROCKS LARGER

90° TXT P.V.C. SCH. 80

CENTERED IN BOX.


6" DEEP (MIN)

VALVE BOX

THAN 1")

FPTxFPT

(PVC SCH. 80).

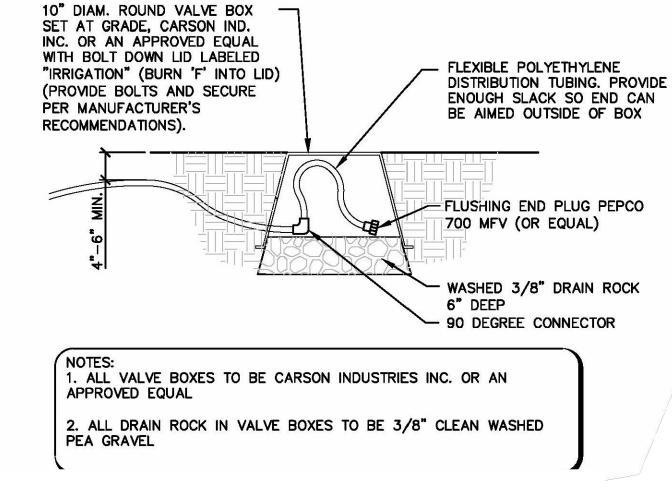

DRIP EMITTER STAKING DETAIL





BOWL INCLINE

RENOVATION/REMODEL

920 Southwood Boulevard


Incline Village Washoe County, Nevada


DENNIS E. ZIRBEL

ARCHITECT A PROFESSIONAL CORPORATION P.O. Box 296 Truckee, CA 96160 Telephone: 530.582.8979 Fax: 530.582.8938 www.zirbelarchitect.com

DRAWN: 12/8/2020 SCALE: JOB No. : 2Ø17

L-5

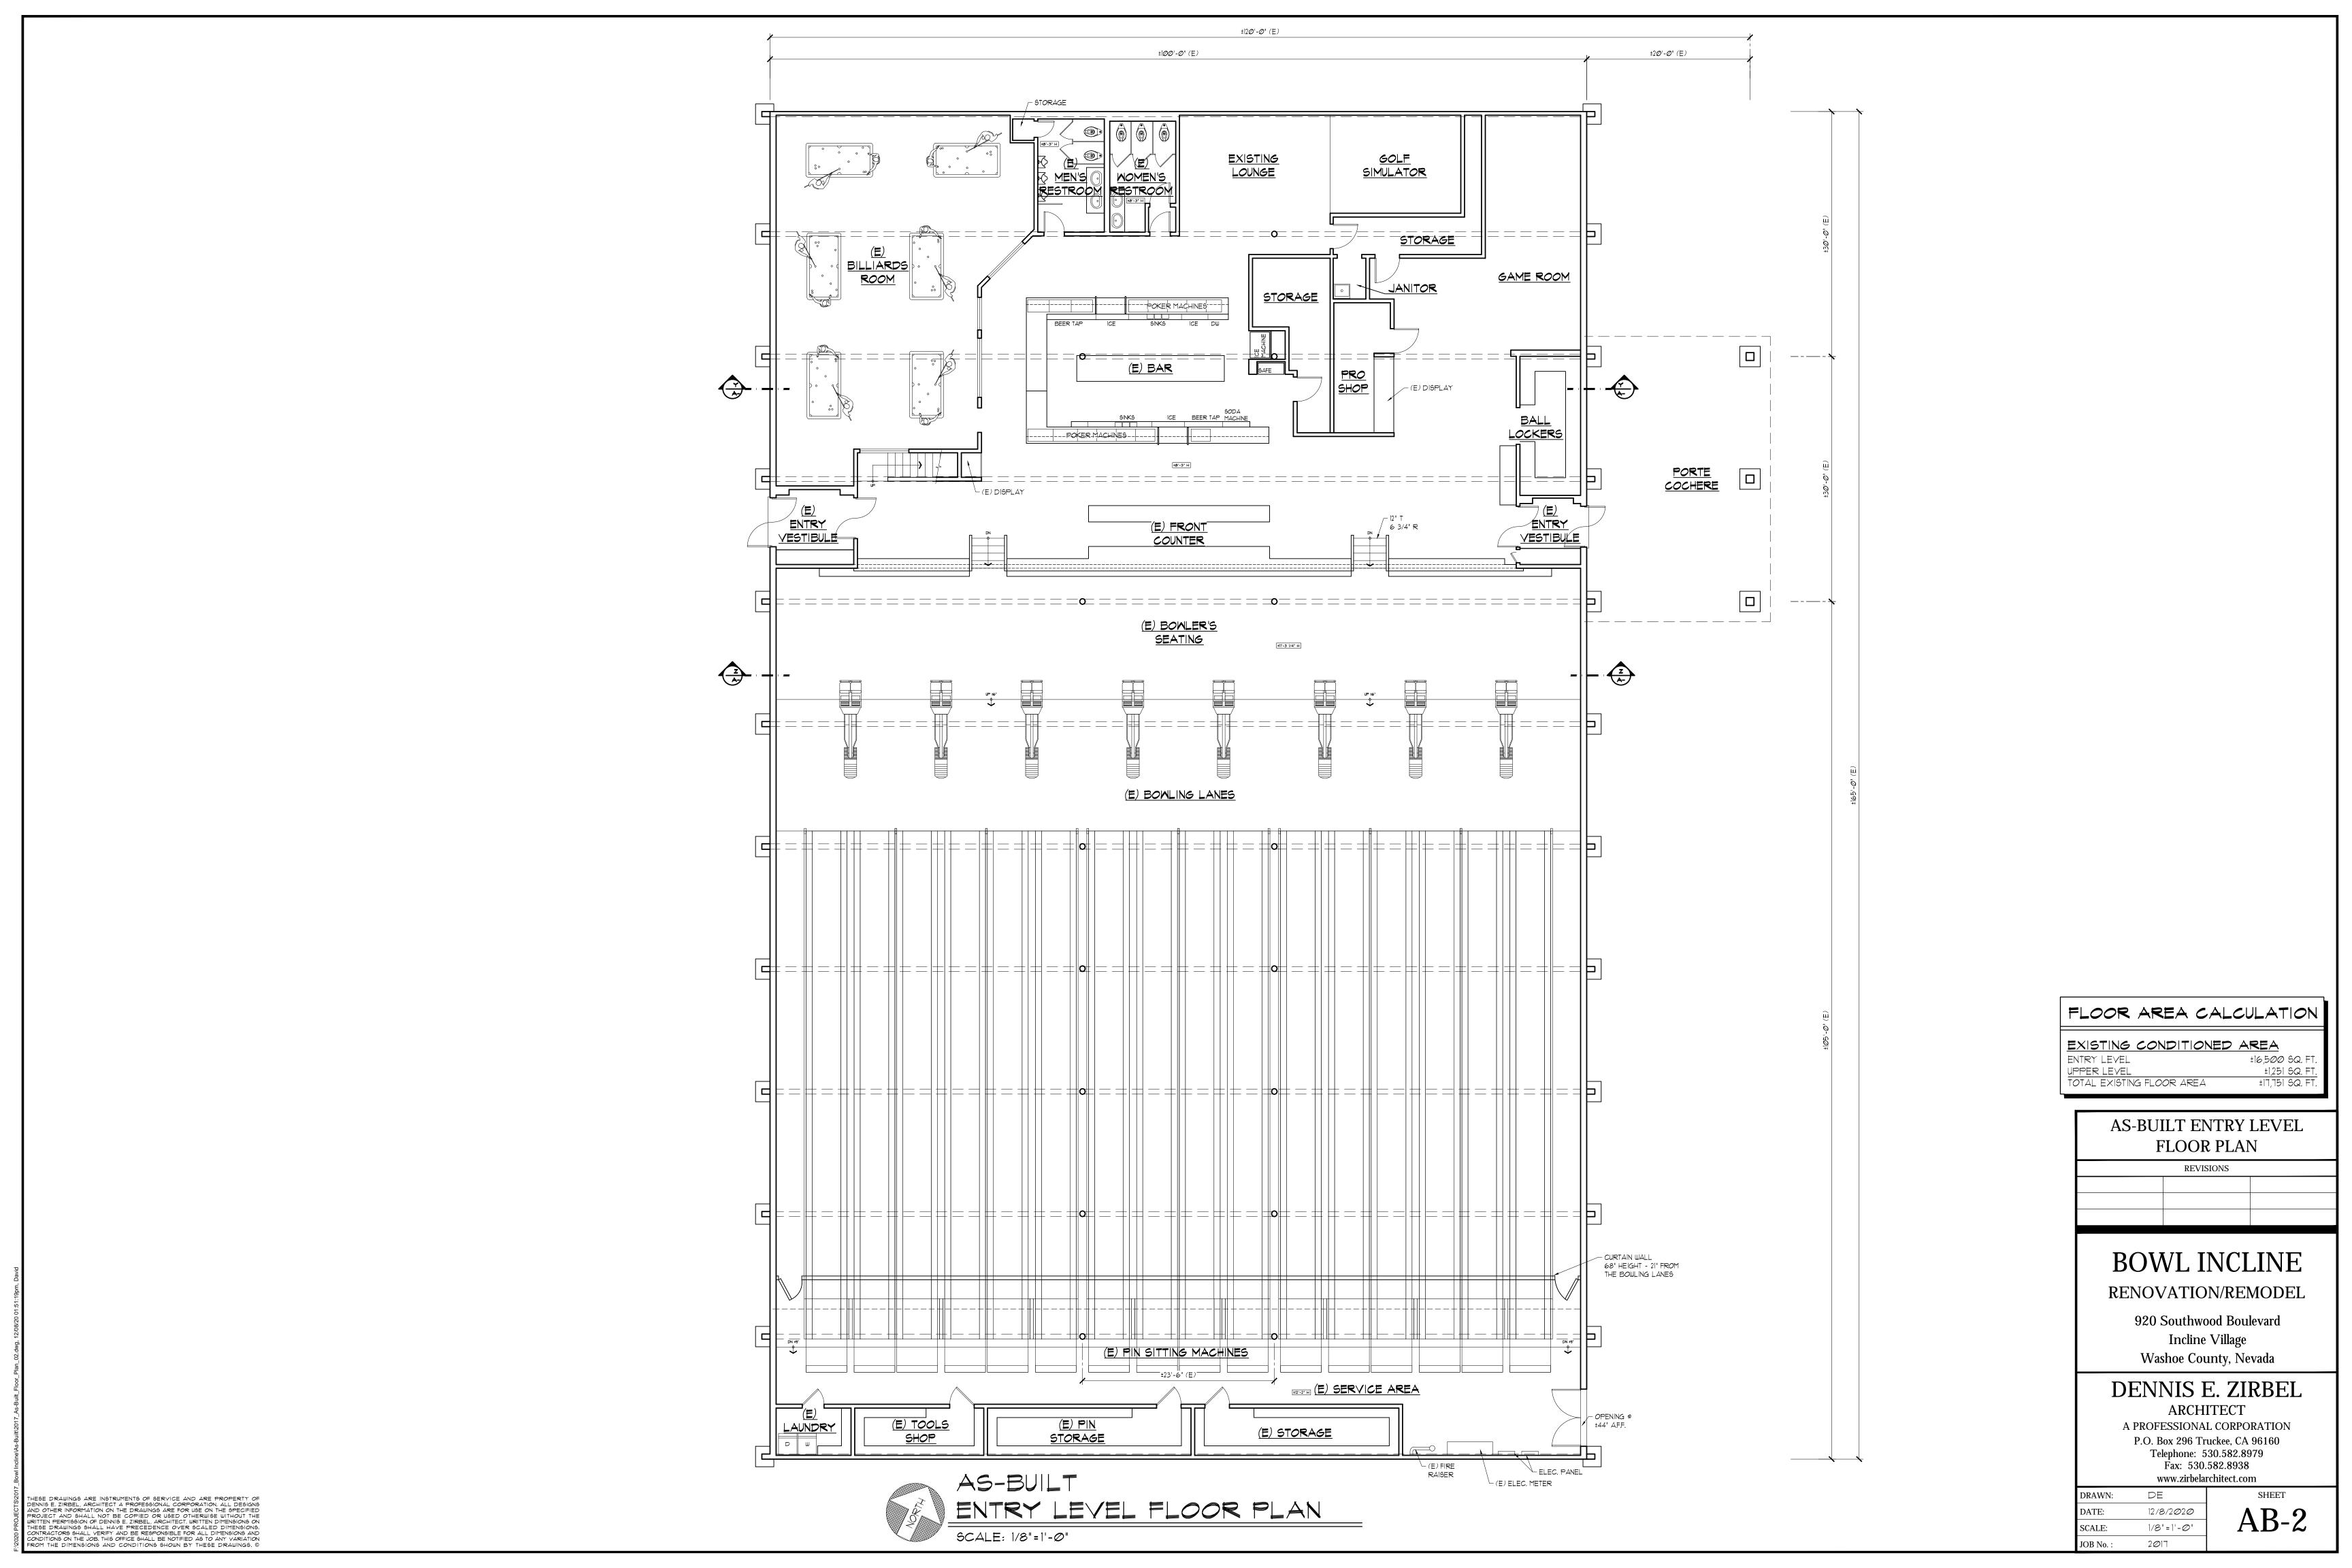

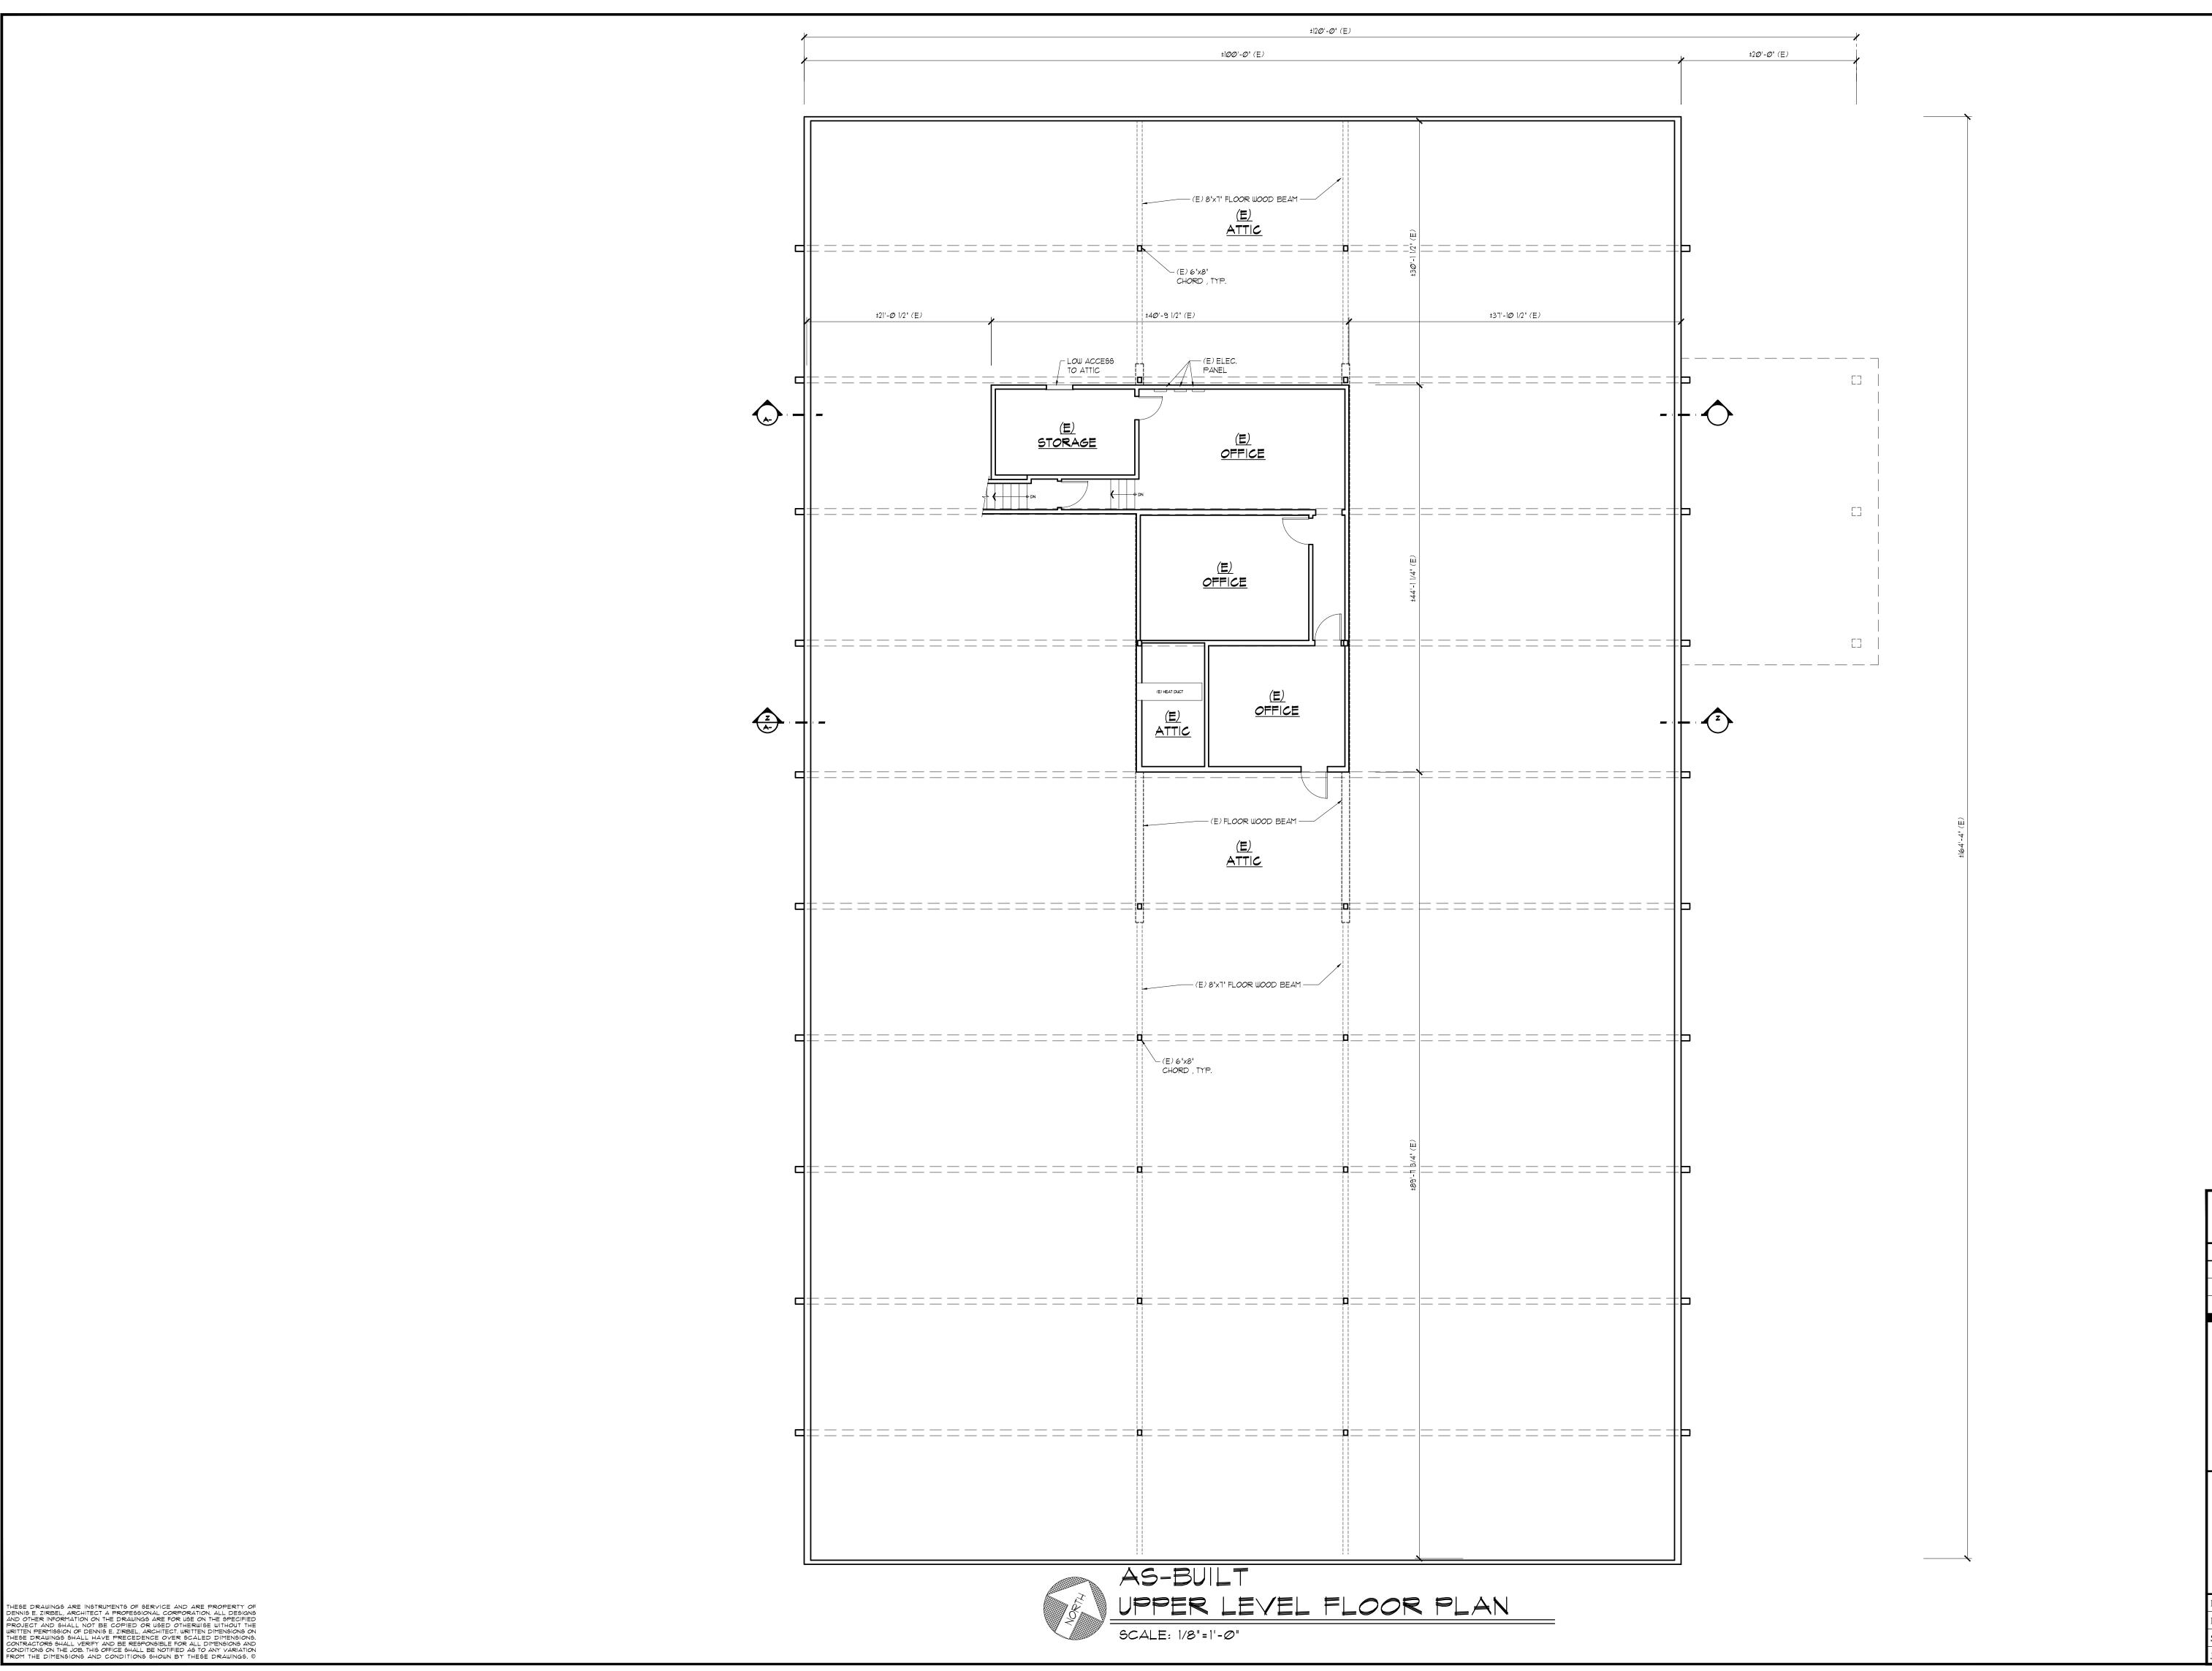

AS-BUILT UPPER LEVEL FLOOR PLAN

REVISIONS

BOWL INCLINE

RENOVATION/REMODEL

920 Southwood Boulevard Incline Village Washoe County, Nevada

DENNIS E. ZIRBEL

ARCHITECT
A PROFESSIONAL CORPORATION
P.O. Box 296 Truckee, CA 96160
Telephone: 530.582.8979
Fax: 530.582.8938
www.zirbelarchitect.com

 DRAWN:
 DE

 DATE:
 12/8/2∅2∅

 SCALE:
 1/8" = 1' - ∅"

AB-3

