Community Services Department Planning and Development

SPECIAL USE PERMIT (see page 5)

SPECIAL USE PERMIT FOR GRADING (see page 11)

SPECIAL USE PERMIT FOR STABLES (see page 16)

APPLICATION



Community Services Department Planning and Development 1001 E. Ninth St., Bldg. A Reno, NV 89520

Telephone: 775.328.3600

Washoe County Development Application

Your entire application is a public record. If you have a concern about releasing personal information, please contact Planning and Development staff at 775.328.3600.

Project Information	S	taff Assigned Case No.:	
Project Name: Verizon	Wireless "l	Rolling Thunder"	
I LIGECTINITION		l of grading work supportin ications facility at 5202 Wa	•
Project Address: 5205 Wayside	Road, Reno, NV 89510		
Project Area (acres or square fee	et): See site plans		
Project Location (with point of re	ference to major cross	streets AND area locator):	
Hillside above existing development on parcel, I	ocated at 5205 Wayside Road	Parcel located at east end of Wayside Road, pa	ast intersection with Stirrup Dr.
Assessor's Parcel No.(s):	Parcel Acreage:	Assessor's Parcel No.(s):	Parcel Acreage:
077-350-01	42.46		
Section(s)/Township/Range: 23	3-21-33		
Indicate any previous Washo Case No.(s). DCA16-007, \		s associated with this applica	tion:
Applicant Info	ormation (attach	additional sheets if necess	sary)
Property Owner:		Professional Consultant:	
Name: Brian Akre		Name: Complete Wireless Cons	ulting, Inc.
Address: PO Box 7710		Address: 2009 V Street	
Reno, NV	Zip: 89510-7710	Sacramento, CA	Zip: 95818
Phone: 775-475-1295	Fax:	Phone: 916-764-2454	Fax: 916-313-3730
Email: bakre@washoeschools.net		Email: MEllis@completewireless.net	
Cell: 775-475-1295	Other:	Cell: 916-764-2454	Other:
Contact Person: Brian Akre		Contact Person: Michelle Ellis, Planning Manager	
Applicant/Developer:		Other Persons to be Contacted:	
Name: Sacramento Valley LP d/b/a Verizon Wireless		Name:	
Address: Attn: CWC, 2009 V Stre	eet	Address:	
Sacramento, CA	Zip: 95818		Zip:
Phone: 916-764-2454	Fax: 916-313-3730	Phone:	Fax:
Email: MEllis@completewireless.	net	Email:	
Cell: 916-764-2454	Other:	Cell:	Other:
Contact Person: Michelle Ellis		Contact Person:	
For Office Use Only			
Date Received:	Initial:	Planning Area:	
County Commission District:		Master Plan Designation(s):	
CAB(s):		Regulatory Zoning(s):	

Property Owner Affidavit

Applicant Name:	Verizon Wireless
requirements of the Was	ion at the time of submittal does not guarantee the application complies with all hoe County Development Code, the Washoe County Master Plan or the pplicable regulatory zoning, or that the application is deemed complete and will
STATE OF NEVADA	
COUNTY OF WASHOE	
1, Brian	Akre
Books of Landau and the control	(please print name)
application as listed belov information herewith subm and belief. I understand th Development.	and say that I am the owner* of the property or properties involved in this v and that the foregoing statements and answers herein contained and the litted are in all respects complete, true and correct to the best of my knowledge hat no assurance or guarantee can be given by members of Planning and
(A separate Affidavit	must be provided by each property owner named in the title report.)
Assessor Parcel Number(s): <u>077-350-01</u>
	Printed Name Brian Akre
	Signed Brian ahre 5-11-16
	Address PO Box 7710
	Reno, NV 89510
Subscribed and sworn ll day of MM	to before me this
Red by	d county and state RICHARD SAHLBERG Notary Public - State of Nevada
Notary Public in and for sai	Appointment Recorded in Washoe County
My commission expires:	8/2/2018 No: 10-2643-2 - Expires August 20, 2018
 Owner Corporate Officer/F Power of Attorney Owner Agent (Prov Property Agent (Pro 	Partner (Provide copy of recorded document indicating authority to sign.) (Provide copy of Power of Attorney.) (ride notarized letter from property owner giving legal authority to agent.) (ovide copy of record document indicating authority to sign.) ment Agency with Stewardship

Special Use Permit Application Supplemental Information

(All required information may be separately attached)

Chapter 110 of the Washoe County Code is commonly known as the Development Code. Specific references to special use permits may be found in Article 810, Special Use Permits.

1.	What is the type of project being requested?
	Graded gravel access road supporting wireless facility on hillside.
2.	What currently developed portions of the property or existing structures are going to be used with this permit?
	None, access road proposed on raw land

	What improvements (e.g. new structures, roadway improvements, utilities, sanitation, water supply, drainage, parking, signs, etc.) will have to be constructed or installed and what is the projected time frame for the completion of each?
	Gravel access road, grading work.
4.	What is the intended phasing schedule for the construction and completion of the project?
	Construction will last approximately two months.
	What physical characteristics of your location and/or premises are especially suited to deal with the impacts and the intensity of your proposed use?
	Access route involved less invasive grading work than existing path on property.

Access route to proposed telecommunications site on hillside What will you do to minimize the anticipated negative impacts or effects your project will have dadjacent properties? No impacts on other properties anticipated.		What are the anticipated beneficial aspects or effects your project will have on adjacent propertie and the community?
adjacent properties?		Access route to proposed telecommunications site on hillside
adjacent properties?		
No impacts on other properties anticipated.	١	What will you do to minimize the anticipated negative impacts or effects your project will have o adjacent properties?
		No impacts on other properties anticipated.

	use permit to address			proval to be imposed on t
Facility will b	e unmanned, and	road lightly us	ed. Technician v	visit 1-2 times per mor
How many imp (Please indicate		es, both on-site a	nd off-site, are av	ailable or will be provide
No parking p	roposed. Facility	will be unmann	ed.	

 What types of landscaping (e.g. shrubs, trees, fencing, p indicate location on site plan.) 	eainting scheme, etc.) are proposed?((Please
6' chain link fence with barbed wire at lease are	a perimeter	
o onain inincrense with barbed wire at lease are	sa perimeter.	
 What type of signs and lighting will be provided? On width, construction materials, colors, illumination methor of each sign and the typical lighting standards. (Please plan.) 	ds, lighting intensity, base landscapin	g, etc.)
Down-tilted light at equipment cabinets, contact	et signage on fence. See site pla	ns.
Are there any restrictive covenants, recorded conditions the area subject to the special use permit request? (If so		apply to
☐ Yes	0	

13. Utilities:

a. Sewer Service	N/A
b. Electrical Service	Yes, see site plans
c. Telephone Service	Yes, see site plans
d. LPG or Natural Gas Service	N/A
e. Solid Waste Disposal Service	N/A
f. Cable Television Service	N/A
g. Water Service	N/A

For most uses, the Washoe County Code, Chapter 110, Article 422, Water and Sewer Resource Requirements, requires the dedication of water rights to Washoe County. Please indicate the type and quantity of water rights you have available should dedication be required:

h. Permit #	acre-feet per year
i. Certificate #	acre-feet per year
j. Surface Claim #	acre-feet per year
k. Other#	acre-feet per year

Department of Conservation and Natural Resources):
Not applicable.

14. Community Services (provided and nearest facility):

a. Fire Station	Scott Fire Protection
b. Health Care Facility	N/A
c. Elementary School	N/A
d. Middle School	N/A
e. High School	N/A
f. Parks	Palomino Valley Park Site
g. Library	N/A
h. Citifare Bus Stop	N/A

Special Use Permit Application for Grading Supplemental Information

(All required information may be separately attached)

Chapter 110 of the Washoe County Code is commonly known as the Development Code. Specific references to special use permits may be found in Article 810, Special Use Permits. Article 438, Grading, and Article 418, Significant Hydrologic Resources, are the ordinances specifically involved in this request.

1.	What is the purpose of the grading?
	Access road up hillside to reach telecommunications facility.
2.	How many cubic yards of material are you proposing to excavate on site?
	Approximately 3,615
3.	How many square feet of surface of the property are you disturbing?
	Approximately 3,615
4.	How many cubic yards of material are you exporting or importing? If none, how are you managing to balance the work on-site?
	Importing approximately 291 cubic yards

5. Is it possible to develop your property without surpassing the grading thresholds requiring Use Permit? (Explain fully your answer.)		
	No. Must develop access road capable of supporting hillside vehicular access.	
6.	Has any portion of the grading shown on the plan been done previously? (If yes, explain the	
	circumstances, the year the work was done, and who completed the work.)	
	No. Access route is raw land.	
	Have you shown all areas on your site plan that are proposed to be disturbed by grading? (If no, explain fully your answer.)	
	Yes. Site plans address all areas on property where grading is proposed.	

	Can the disti	urbed area b	e seen from off-site? If yes, from which directions, and which properties or
	Yes, will be	e slightly v	isible from Wayside Road, looking east.
			rties also be served by the proposed access/grading requested (i.e. if you would it be used for access to additional neighboring properties)?
	No, access	s road will	be fully contained within landlord's 42.46 acre parcel.
			ntal:Vertical) of the cut and fill areas proposed to be? What methods will be ntil the revegetation is established?
	Limits of d	isturbance	: Daylight Max 3:1 slope
11.	Are you plan	ning any ber	ms?
	☐ Yes	☑ No	If yes, how tall is the berm at its highest?

	required? If so, how high will the walls be and what is their construction (i.e. rockery, concrete timber, manufactured block)?
	Please see site plans.
12	What are you proposing for visual mitigation of the work?
13.	What are you proposing for visual mitigation of the work?
	Route will be graveled to blend in with hillside.
	Will the grading proposed require removal of any trees? If so, what species, how many and of wha size?
	No tree removal is proposed.

	What type of revegetation seed mix are you planning to use and how many pounds per acre do you ntend to broadcast? Will you use mulch and, if so, what type?			
S	eed mix to be determined, based on requirements of permit. No mulch proposed.			
16. H	ow are you providing temporary irrigation to the disturbed area?			
Т	o be determined during BP application process.			
	ave you reviewed the revegetation plan with the Washoe Storey Conservation District? If yes, have bu incorporated their suggestions?			
Υ	es. Yes.			
	re there any restrictive covenants, recorded conditions, or deed restrictions (CC&Rs) that may ohibit the requested grading?			
	☐ Yes ☐ No If yes, please attach a copy.			

PROJECT NOTES

PER C.O.A. #1j:

SHOULD ANY PREHISTORIC OR HISTORIC REMAINS/ARTIFACTS BE DISCOVERED DURING SITE DEVELOPMENT, WORK SHALL TEMPORARILY BE HALTED AT THE SPECIFIC SITE AND THE STATE HISTORIC PRESERVATION OFFICE OF THE DEPARTMENT OF MUSEUMS, LIBRARY AND ARTS SHALL BE NOTIFIED TO RECORD AND PHOTOGRAPH THE SITE. THE PERIOD OF TEMPORARY DELAY SHALL BE LIMITED TO A MAXIMUM OF TWO WORKING DAYS FROM THE DATE OF NOTIFICATION.

PER C.O.A. #1i:


ALL DISTURBED AREAS (EXCEPT FOR COMPACTED/ENGINEERED GRAVEL SURFACES) RESULTING FROM CONSTRUCTION OF THE PROJECT AND RELATED ACCESS ROADS AND UTILITIES SHALL BE RESTORED / RE-VEGETATED WITH SEED MIXES THAT ARE NATIVE AND/OR ADAPTED TO THE AREA.

Verlzon

295 Parkshore Drive, Folsom, CA 95630

ROLLING THUNDER

5205 WAYSIDE ROAD RENO, NV 89510 APN: 077-350-01 LOCATION #: 382432

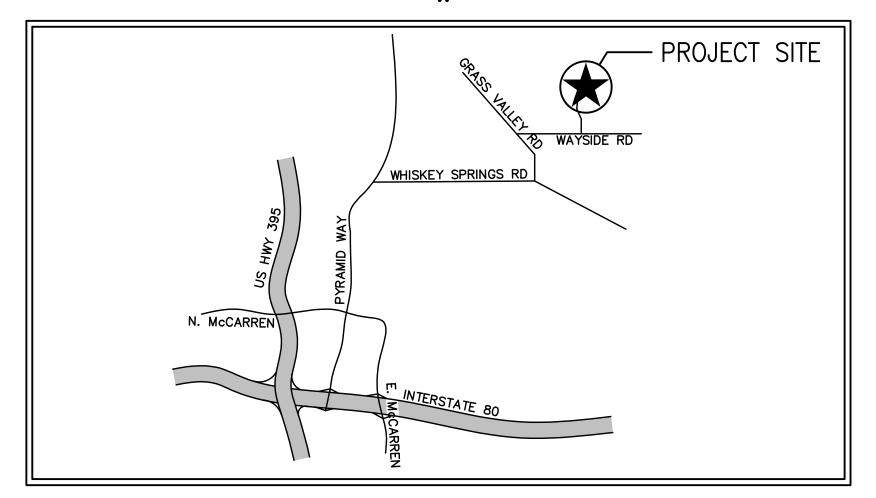

LOCATION PLAN

SPECIAL INSPECTIONS

SPECIAL INSPECTIONS PER 2012 IBC SECTION 1704 ARE REQUIRED FOR THE FOLLOWING:

- A.) ALL STRUCTURAL WELDING, INCLUDING WELDING OF REINFORCEMENT OF STRUCTURAL
- B.) INSTALLATION & TIGHTENING OPERATIONS FOR ALL HIGH-STRENGTH FRICTION BOLTING
- C.) INSTALLATION & TIGHTENING OPERATIONS FOR ALL ANCHOR BOLTS D.) DURING THE TAKING OF TEST SPECIMENS & PLACING OF ALL REINFORCED CONCRETE

SLABS: 1500 PSF

Fa = 1.0

Ss = 1.317q S1 = 0.464q

SDS = 0.878q SD1 = 0.475q

- WHERE THE SPECIFIED CONCRETE STRENGTH EXCEEDS 2500 PSI
- E.) DURING PLACEMENT OF REINFORCING STEEL
- F.) SOILS & FOUNDATION COMPLIANCE WITH PROJECT SOIL REPORT PRIOR TO
- FOUNDATION INSPECTION

STRUCTURAL DESIGN CRITERIA:

- 1) SOIL SITE CLASSIFICATION:
- 2) SOIL BEARING CAPACITY:
- 3) SEISMIC IMPORTANCE FACTOR:
- 4) SPECTRAL RESPONSE ACCELERATIONS:
- 5) SPECTRAL RESPONSE COEFFICIENTS:
- 6) SITE COEFFICIENTS:
- 7) SEISMIC DESIGN CATEGORY:

FROM VERIZON OFFICE @ 255 PARKSHORE DR., FOLSOM, CA 95630:

- HEAD NORTHEAST ON PARKSHORE DR.
- TURN LEFT ONTO GLENN DR.

- CONTINUE ONTO AUBURN FOLSOM RD. TURN LEFT ONTO CAVITT STALLMAN RD.
- TURN RIGHT ONTO HORSESHOE BAR RD.
- 10. TURN LEFT TO STAY ON HORSESHOE BAR RD.
- 14. USE THE RIGHT 2 LANES TO TAKE EXIT 18 TO MERGE ONTO NV-445 N/PYRAMID WAY.
- 15. MERGE ONTO NV-445 N/PYRAMID WAY.
- 16. TURN RIGHT ONTO WHISKEY SPRINGS RD.
- 18. TURN RIGHT ONTO WAYSIDE RD.

DIRECTIONS

- TURN LEFT ONTO COOLIDGE DR.
- USE THE RIGHT 2 LANES TO TURN RIGHT ONTO FOLSOM BLVD.
- CONTINUE ONTO FOLSOM-AUBURN RD.
- TURN RIGHT AT THE 1ST CROSS STREET ONTO LAIRD RD.
- | 11. TURN RIGHT TO MERGE ONTO I-80 E.
- 12. MERGE ONTO I-80 E.
- 13. ENTERING NEVADA.

- 17. TURN LEFT ONTO GRASS VALLEY RD.

INDEX OF DRAWINGS

TITLE SHEET, LOCATION PLAN, PROJECT DATA

- 1. T1.1 2. C1 CIVIL SURVEY SHEET
- 3. C-2 SITE TOPOGRAPHY
- 4. A1.1 OVERALL SITE PLAN, ENLARGED ACCESS ROAD PLAN
- 5. A2.1 EQUIPMENT LAYOUT PLAN
- 6. A2.2 ANTENNA LAYOUT PLAN
- PROJECT ELEVATIONS
- 8. A4.1 SITE CONSTRUCTION DETAILS
- 9. A4.2 SITE CONSTRUCTION DETAILS 10. A4.3 RRU/RAYCAP CONNECTION GUIDE
- OVERTURNING CALCULATIONS 11. S1.0
- 12. S1.1 STRUCTURAL DETAILS
- 13. E1.1 ELECTRICAL DETAILS
- 14. E2.1 GROUNDING PLAN
- 15. E2.2 GROUNDING DETAILS

CARTWRIGHT ENGINEERS GRADING & DRAINAGE PLANS:

- GENERAL NOTES & ACCESS ROAD TYPICAL SECTIONS 16. C1.0
- 17. C1.1 ACCESS ROAD PLAN & PROFILE 18. C1.2 ACCESS ROAD PLAN & PROFILE 19. C1.3 ACCESS ROAD SECTIONS
- 20. C2.0 **EROSION & SEDIMENT CONTROL**

PROJECT DIRECTORY

APPLICANT: VERIZON WIRELESS 295 PARKSHORE DRIVE FOLSOM, CA 95630

ARCHITECT: MANUEL S TSIHLAS 1520 RIVER PARK DRIVE

SACRAMENTO, CA 95815

916-505-3811 PH

PROPERTY OWNER:
BRIAN M. & MARIA M. AKRE P.O. BOX 7710 RENO. NV 89510

CONSTRUCTION MANAGER: BOB SCHROEDER COMPLETE WIRELESS CONSULTING, INC 2009 V STREET SACRAMENTO, CA 95818

916-217-7512 bschroeder@completewireless.net

PROJECT SUMMARY

ASSESSOR'S PARCEL NUMBER: 077-350-01

JURISDICTION: WASHOE COUNTY

OCCUPANCY: U (UNMANNED TELECOMMUNICATIONS FACILITY)

TYPE OF CONSTRUCTION:

GRA - GENERAL RURAL AGRICULTURE

C O D E C O M P L I A N C E

LOCAL GOVERNING AUTHORITIES. NOTHING IN THESE PLANS IS TO BE CONSTRUED TO PFRMIT WORK NOT CONFORMING TO THESE CODES

- 2012 INTERNATIONAL MECHANICAL CODE

- 2011 NATIONAL ELECTRIC CODE
- 2009 INTERNATIONAL ENERGY CONSERVATION CODE W/AMENDMENTS 2003 INTERNATIONAL FIRE CODE W/AMENDMENTS
- 10. 2012 NORTHERN NEVADA AMENDMENTS

ACCESSIBILITY REQUIREMENTS:

THIS FACILITY IS UNMANNED AND NOT FOR HUMAN HABITATION. HANDICAPPED ACCESS REQUIREMENTS ARE NOT REQUIRED IN ACCORDANCE WITH THE 2012 INTERNATIONAL BUILDING CODE.

PROJECT DESCRIPTION

PROPOSED VERIZON WIRELESS UNMANNED TELECOMMUNICATIONS FACILITY INCLUDING:

- A 50'-0"x50'-0" LEASE AREA.

- A CHAIN LINK FENCE @ LEASE AREA PERIMETER.

- OUTDOOR EQUIPMENT CABINETS.
- UNDERGROUND POWER & TELCO UTILITIES BROUGHT TO FACILITY.
- A COAXIAL CABLE ICE BRIDGE.
- ANTENNAS W/ASSOCIATED TOWER MOUNTED EQUIPMENT MOUNTED ON A PROPOSED

PROJECT MILESTONES

05/12/2016 06/20/2016 04/19/2017


90% ZONING DOCUMENTS 100% ZONING DOCUMENTS 100% ZONING DOCUMENTS REV1

05/31/2017 07/24/2017

90% CONSTRUCTION DOCUMENTS 100% CONSTRUCTION DOCUMENTS

INSTRUMENTS OF SERVICE, ARE AND SHALL REMAIN THE PROPERTY OF WANUEL S. THESE DRAMINGS AND SPECIFICATIONS SHALL NOT BE USED BY ANY PERSON OR WANUEL S. TSHLAS, ARCHITECT ALL RIGHTS RESERVED.

LOC

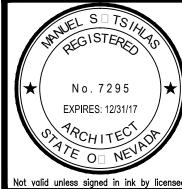

Revisions:

File:162.1800_T11.dwg Drawn By: wws Checked By: MST Scale: AS NOTED

Job No. 162.1800

Date: 07/24/17

DRAWINGS ARE NOT TO BE SCALED, WRITTEN DIMENSIONS TAKE

INSTRUMENTS OF SERVICE, ARE AND SHALL REMAIN THE PROPERTY OF WANUEL S. THESE DRAWINGS AND SPECIFICATIONS SHALL NOT BE USED BY ANY PERSON OR WANUEL S. TSHLAS, ARCHITECT ALL RIGHTS RESERVED.

APPROVAL CONDITIONS

No.7295

EXPIRES: 12/31/17

Not valid unless signed in ink by licensee

Revisions:

File:162.1800_T12.dwg Drawn By: JCE Checked By: TST Scale: AS NOTED Date: 07/24/17

Job No. 162.1800

- k. The following **Operational Conditions** shall be required for the life of the project:
- 1. This Special Use Permit shall expire and become null and void within 2 years from the final date of approval if final building permits have not been issued by said date.
- 2. The applicant and any successors shall be responsible for maintenance and repairs of everything within the 50 x 50 foot wireless communications compound and shall be responsible for all maintenance and repairs of the entire wireless communications facility, including required maintenance of the fence and replacement of any part of the slim line pole should it deteriorate or become damaged. The applicant shall take action not more than 30 days after receiving notification from Washoe County of any damage to the wireless communications facility or the fence.
- 3. If the facility ceases operations, or if abandonment is contemplated, then the operator/owner of record shall notify Washoe County of its intent at least 2 months in advance and shall submit demolition plans to the Washoe County Building and Safety division. The abandoned site shall be restored to its predevelopment condition. The owner shall be responsible for all costs associated with demolition and restoration of the site.
- 4. Failure to comply with the Conditions of Approval shall render this approval null and void. Compliance with this condition shall be determined by Washoe County Planning and Development.
- 5. The applicant and any successors shall direct any potential purchaser/operator of the site and/or the special use permit to meet with Washoe County Planning and Development to review conditions of approval prior to the final sale of the site and/or the special use permit. Any subsequent purchaser/operator of the site and/or the special use permit shall notify the Washoe County Planning and Development of the name, address, telephone number, and contact person of the new purchaser/operator within 30 days of the final sale.
- 6. This special use permit shall remain in effect as long as the subject wireless communications facility is in operation and remains in compliance with the conditions of approval.

Washoe County Engineering and Capital Projects Division

- 2. The following conditions are requirements of the Engineering and Capital Projects Division, which shall be responsible for determining compliance with these conditions. Contact: Leo Vesely, P.E., 775.328.2313, Ivesely@washoecounty.us
- a. A complete set of construction improvement drawings, including an on-site grading plan (to include the access road), shall be submitted when applying for a building/grading permit. Grading shall comply with best management practices (BMP's) and shall include detailed plans for grading, site drainage, erosion control (including BMP locations and installation details), slope stabilization, and mosquito abatement. Placement or removal of any excavated materials shall be indicated on the grading plan. All grading shall comply with Washoe County Code Chapter 110, Article 438, Grading Standards. Silts shall be controlled on-site.
- b. The applicant shall provide **proof of easements** for the lease area, access and utilities. A copy of the documented easements shall be submitted to the Engineering Division prior to issuance of a building permit.

- Washoe County Conditions of Approval for WSUP17-0006
- District (PVGID), which shall be responsible for determining compliance with these
- a. Any damage to PVGID roadways from construction traffic shall be repaired by regrading

Washoe County Conditions of Approval for WSUP17-0006

Washoe County Conditions of Approval for WSUP17-0006

cgiesinger@washoecounty.us

Development Division.

of this special use permit.

notification.

Washoe County Planning and Development Division

determine compliance with this condition.

not exceed 150 feet from finished grade.

1. The following conditions are requirements of the Planning and Development Division, which

a. The applicant shall demonstrate substantial conformance to the plans approved as

b. All related utilities, including telephone and electrical lines connected with the

c. The total height of the cell tower, including all antennas or any other apparatus, shall

d. The applicant shall submit complete construction plans and building permits shall be

issued within two years from the date of approval by Washoe County. The applicant

shall complete construction within the time specified by the building permits.

Compliance with this condition shall be determined by the Planning and

communications facility compound (lease area). The installation of security fencing

shall assure the facility is protected from climbing by unauthorized persons. Said

security fencing shall NOT be screened by the use of colored slats. The chain link

painted a neutral color (e.g. tan or light brown) that will blend with the character of

the area. In no instance shall reflective metal materials be utilized that could result in

e. Security fencing shall be erected around the entire 50 x 50 foot wireless

f. All equipment, fencing, ground cabinet, tower, and tower components shall be

g. The applicant shall attach a copy of the action order granting approval of this project

h. At the time of building permit application, the applicant shall submit a survey (or other

i. All disturbed areas (except for compacted/engineered gravel surfaces) resulting from

2,000 feet from the parcel boundary of Assessors Parcel Number 077-340-14.

re-vegetated with seed mixes that are native and/or adapted to the area.

j. A note shall be placed on all construction drawings and grading plans stating:

to all administrative permit applications (including building permits) applied for as part

acceptable certification) demonstrating that the monopole is located a minimum of

construction of the project and related access roads and utilities shall be restored /

Should any prehistoric or historic remains/artifacts be discovered

during site development, work shall temporarily be halted at the

specific site and the State Historic Preservation Office of the

Department of Museums, Library and Arts shall be notified to record

and photograph the site. The period of temporary delay shall be

limited to a maximum of two working days from the date of

Special Use Permit Case Number WSUP17-0006

part of this special use permit. The Planning and Development Division shall

proposed wireless communications facility and within any and all Verizon utility

shall be responsible for determining compliance with these conditions.

easements on the subject site shall be placed underground.

fence shall remain unscreened and open (i.e. see through).

Contact: Chad Giesinger, Senior Planner, 775.328.3626,

Special Use Permit Case Number WSUP17-0006 Page 3 of 4

- c. All existing and proposed easements shall be shown on the site and/or grading plan.
- Contact: Larry Johnson, President of PVGID, 775.848.6788, palvalgid@gmail.com

- The County Engineer shall determine compliance with this condition.
- 3. The following conditions are requirements of the Palomino Valley General Improvement


 - after completion of the project.


*** End of Conditions ***

Special Use Permit Case Number WSUP17-0006

PRECEDENCE, AND THIS SET OF PLANS IS INTENDED TO BE USED FOR DIAGRAMMATIC PURPOSES ONLY, UNLESS NOTED OTHERWISE. THE GENERAL CONTRACTOR'S SCOPE OF WORK SHALL INCLUDE FURNISHING ALL MATERIALS, EQUIPMENT, LABOR AND ANYTHING ELSE DEEMED NECESSARY TO COMPLETE INSTALLATIONS AS DESCRIBED HEREIN.

- 2. PRIOR TO THE SUBMISSION OF BIDS, THE CONTRACTORS INVOLVED SHALL VISIT THE JOB SITE AND FAMILIARIZE THEMSELVES WITH ALL CONDITIONS AFFECTING THE PROPOSED PROJECT, WITH THE CONSTRUCTION AND CONTRACT DOCUMENTS, FIELD CONDITIONS AND CONFIRM THAT THE PROJECT MAY BE ACCOMPLISHED AS SHOWN PRIOR TO PROCEEDING WITH CONSTRUCTION, ANY ERRORS, OMISSIONS, OR DISCREPANCIES ARE TO BE BROUGHT TO THE ATTENTION OF THE ARCHITECT/ ENGINEER.
- 3. THE GENERAL CONTRACTOR SHALL RECEIVE WRITTEN AUTHORIZATION TO PROCEED WITH CONSTRUCTION PRIOR TO STARTING WORK ON ANY ITEM NOT CLEARLY DEFINED BY THE CONSTRUCTION DRAWINGS/CONTRACT DOCUMENTS.
- 4. THE CONTRACTOR SHALL SUPERVISE AND DIRECT THE PROJECT DESCRIBED HEREIN. THE CONTRACTOR SHALL BE SOLELY RESPONSIBLE FOR ALL CONSTRUCTION MEANS, METHODS, TECHNIQUES, SEQUENCES. AND PROCEDURES AND FOR COORDINATING ALL PORTIONS OF THE WORK UNDER THE CONTRACT.
- 5. THE CONTRACTOR SHALL INSTALL ALL EQUIPMENT AND MATERIALS ACCORDING TO MANUFACTURER'S/VENDOR'S SPECIFICATIONS UNLESS NOTED OTHERWISE OR WHERE LOCAL CODES OR ORDINANCES TAKE PRECEDENCE.
- 6. ALL WORK PERFORMED ON PROJECT AND MATERIALS INSTALLED SHALL BE IN STRICT ACCORDANCE WITH ALL APPLICABLE CODES, REGULATIONS. AND ORDINANCES. CONTRACTOR SHALL GIVE ALL NOTICES AND COMPLY WITH ALL LAWS, ORDINANCES, RULES, REGULATIONS, AND LAWFUL ORDERS OF ANY PUBLIC AUTHORITY. MUNICIPAL AND UTILITY COMPANY SPECIFICATIONS. AND LOCAL AND STATE JURISDICTIONAL CODES BEARING ON THE PERFORMANCE OF THE WORK.
- GENERAL CONTRACTOR SHALL PROVIDE AT THE PROJECT SITE A FULL SET OF CONSTRUCTION DOCUMENTS UPDATED WITH THE LATEST REVISIONS AND ADDENDUMS OR CLARIFICATIONS FOR THE USE BY ALL PERSONNEL INVOLVED WITH THE PROJECT.
- 8. THE STRUCTURAL COMPONENTS OF THIS PROJECT SITE/FACILITY ARE NOT TO BE ALTERED BY THIS CONSTRUCTION PROJECT UNLESS NOTED OTHERWISE.
- DETAILS HEREIN ARE INTENDED TO SHOW END RESULT OF DESIGN. MINOR MODIFICATIONS MAY BE REQUIRED TO SUIT JOB CONDITIONS OR SITUATIONS, AND SUCH MODIFICATIONS SHALL BE INCLUDED AS PART I OF THE SCOPE OF WORK.
- 10. SEAL PENETRATIONS THROUGH FIRE-RATED AREAS WITH U.L. LISTED OR FIRE MARSHALL APPROVED MATERIALS IF APPLICABLE TO THIS FACILITY AND OR PROJECT SITE.
- 11. THE CONTRACTOR SHALL MAKE NECESSARY PROVISIONS TO PROTECT EXISTING IMPROVEMENTS, EASEMENTS, PAVING, CURBING, ETC. DURING CONSTRUCTION. UPON COMPLETION OF WORK, CONTRACTOR SHALL REPAIR ANY DAMAGE THAT MAY HAVE OCCURRED DUE TO THE CONSTRUCTION ON OR ABOUT THE PROPERTY.
- 12. CONTRACTOR SHALL SEE TO IT THAT GENERAL WORK AREA IS KEPT CLEAN AND HAZARD FREE DURING CONSTRUCTION AND DISPOSE OF ALL DIRT, DEBRIS, RUBBISH AND REMOVE EQUIPMENT NOT SPECIFIED AS REMAINING ON THE PROPERTY. PREMISES SHALL BE LEFT IN CLEAN CONDITION AND FREE FROM PAINT SPOTS, DUST, OR SMUDGES OF ANY NATURE.
- 13. THE ARCHITECTS/ENGINEERS HAVE MADE EVERY EFFORT TO SET FORTH IN THE CONSTRUCTION AND CONTRACT DOCUMENTS THE COMPLETE SCOPE OF WORK. CONTRACTORS BIDDING THE JOB ARE NEVERTHELESS CAUTIONED THAT MINOR OMISSIONS OR ERRORS IN THE DRAWINGS AND OR SPECIFICATIONS SHALL NOT EXCUSE SAID CONTRACTOR FROM COMPLETING THE PROJECT AND IMPROVEMENTS IN ACCORDANCE WITH THE INTENT OF THESE DOCUMENTS. THE BIDDER SHALL BEAR THE RESPONSIBILITY OF NOTIFYING (IN WRITING) THE ARCHITECT/ENGINEER OF ANY CONFLICTS, ERRORS, OR OMISSIONS PRIOR TO THE SUBMISSION OF CONTRACTOR'S PROPOSAL. IN THE EVENT OF DISCREPANCIES THE CONTRACTOR SHALL PRICE THE MORE COSTLY OR EXTENSIVE WORK, UNLESS DIRECTED OTHERWISE.

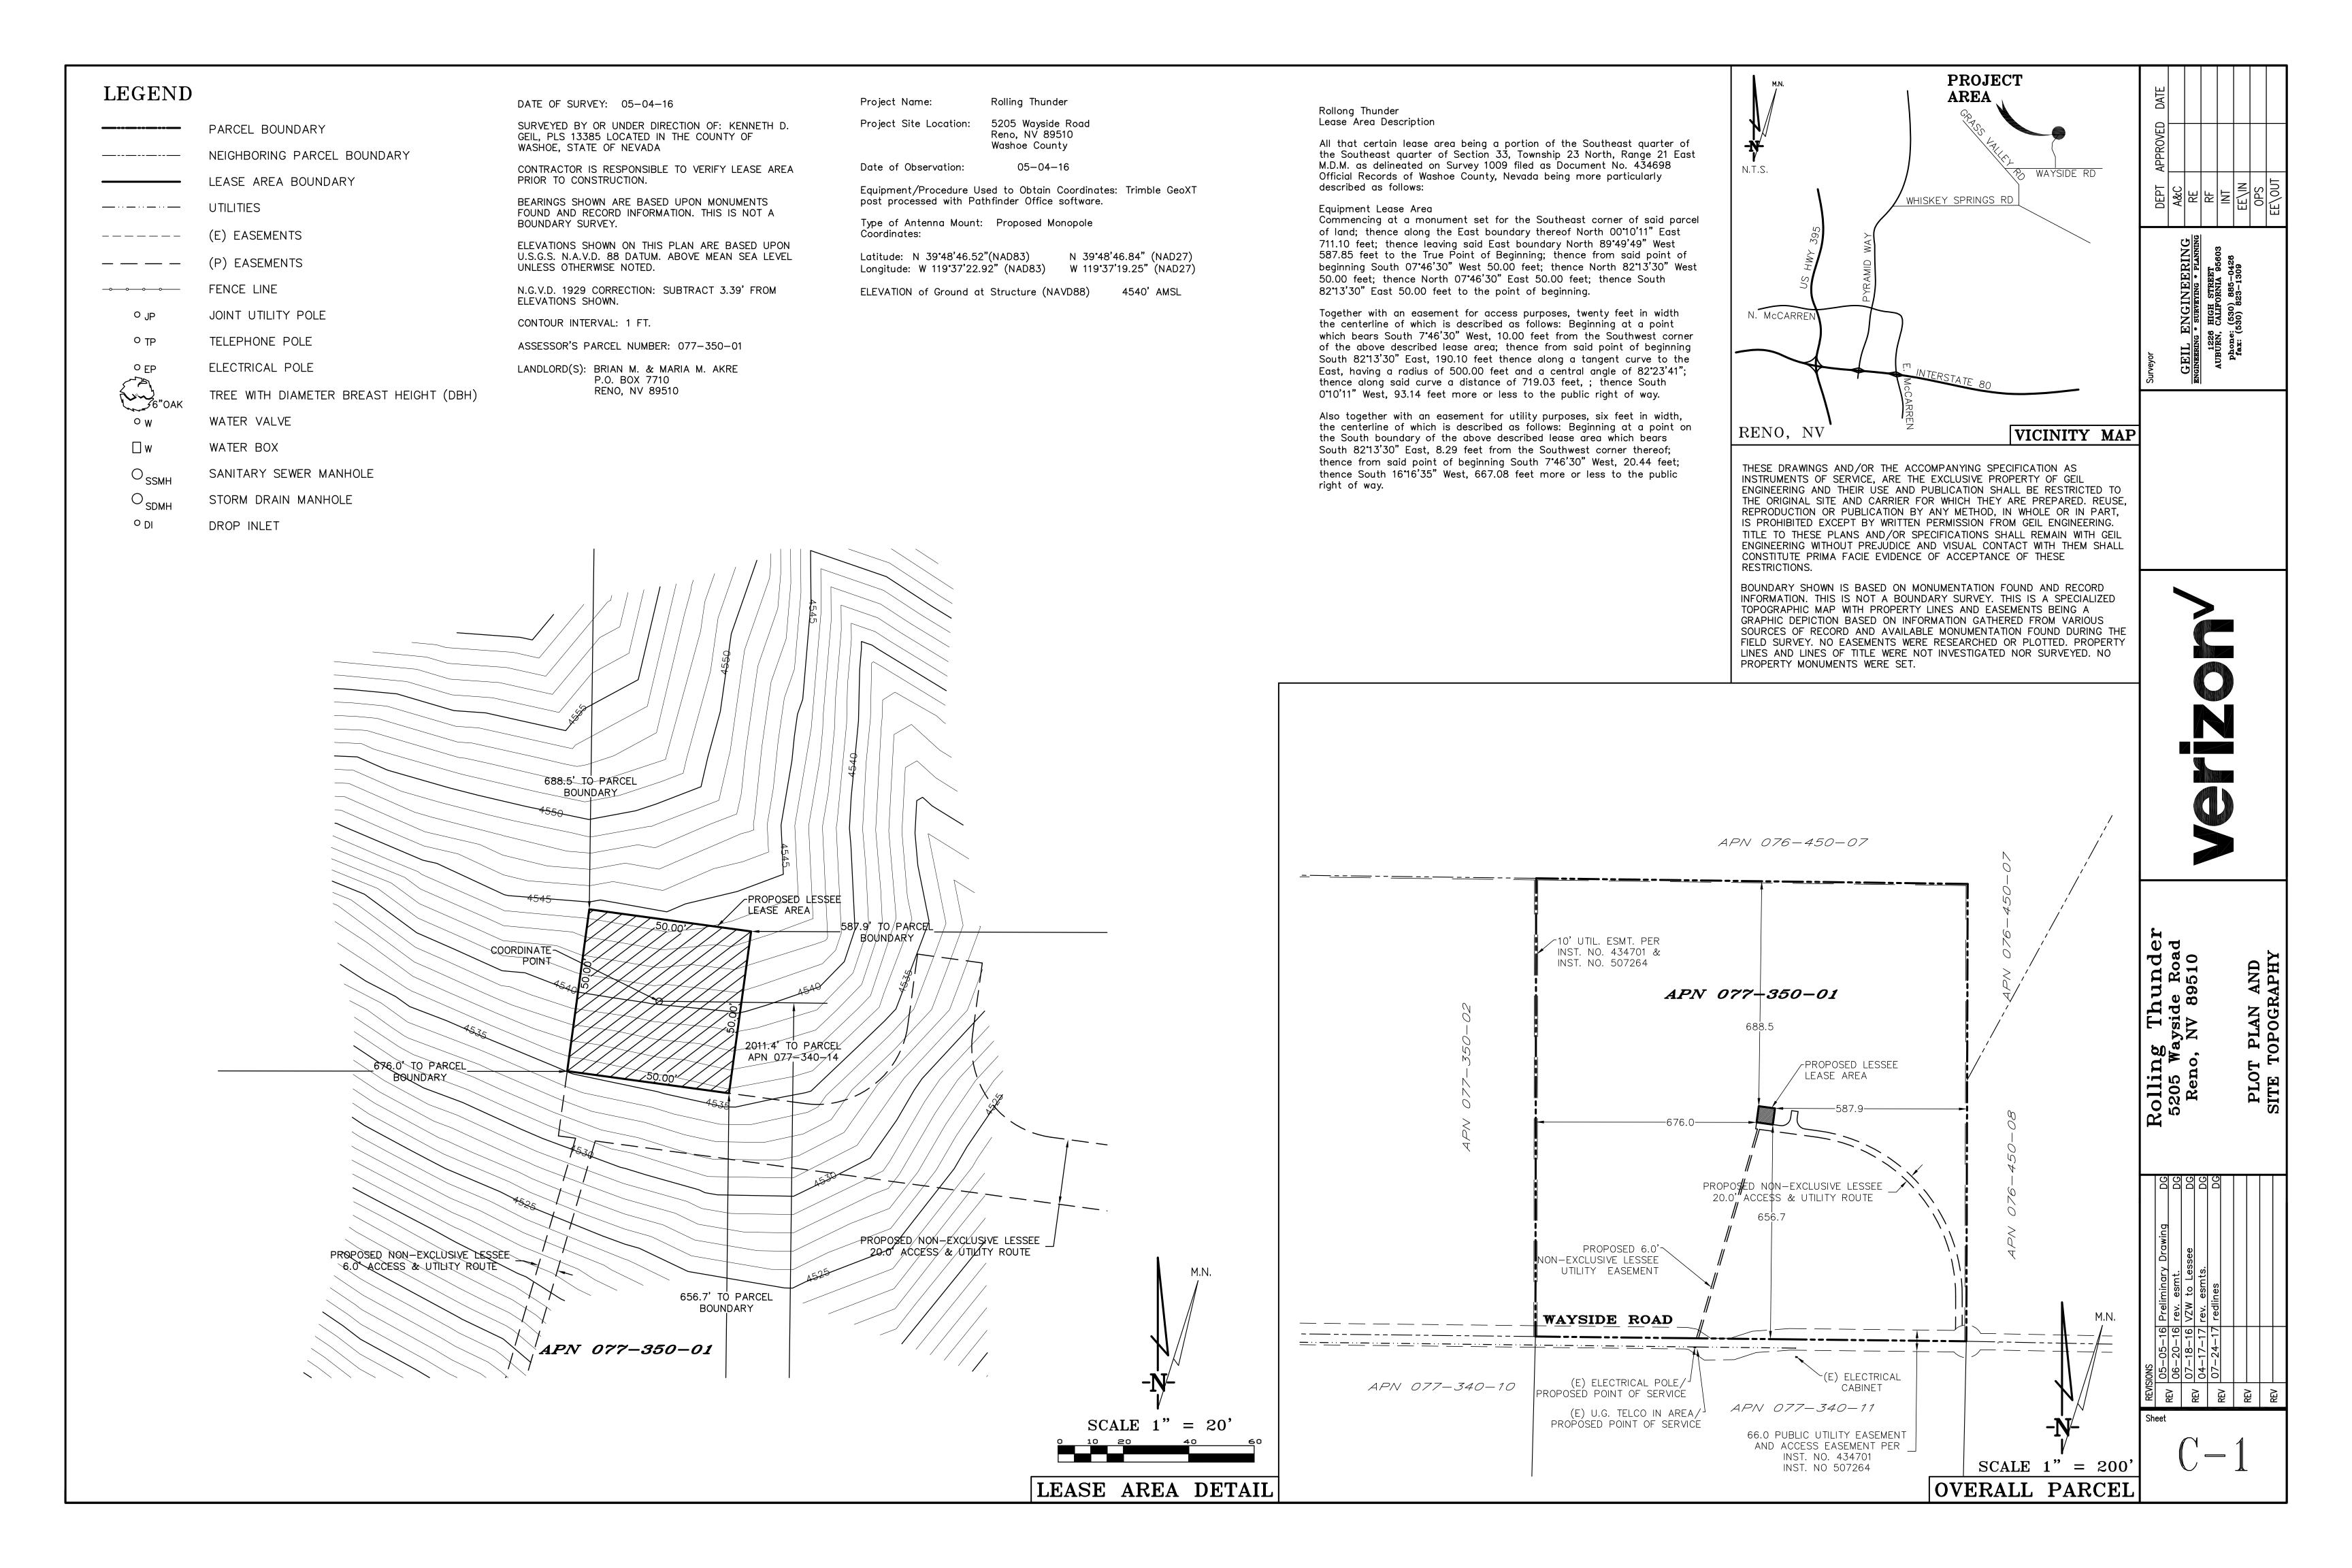

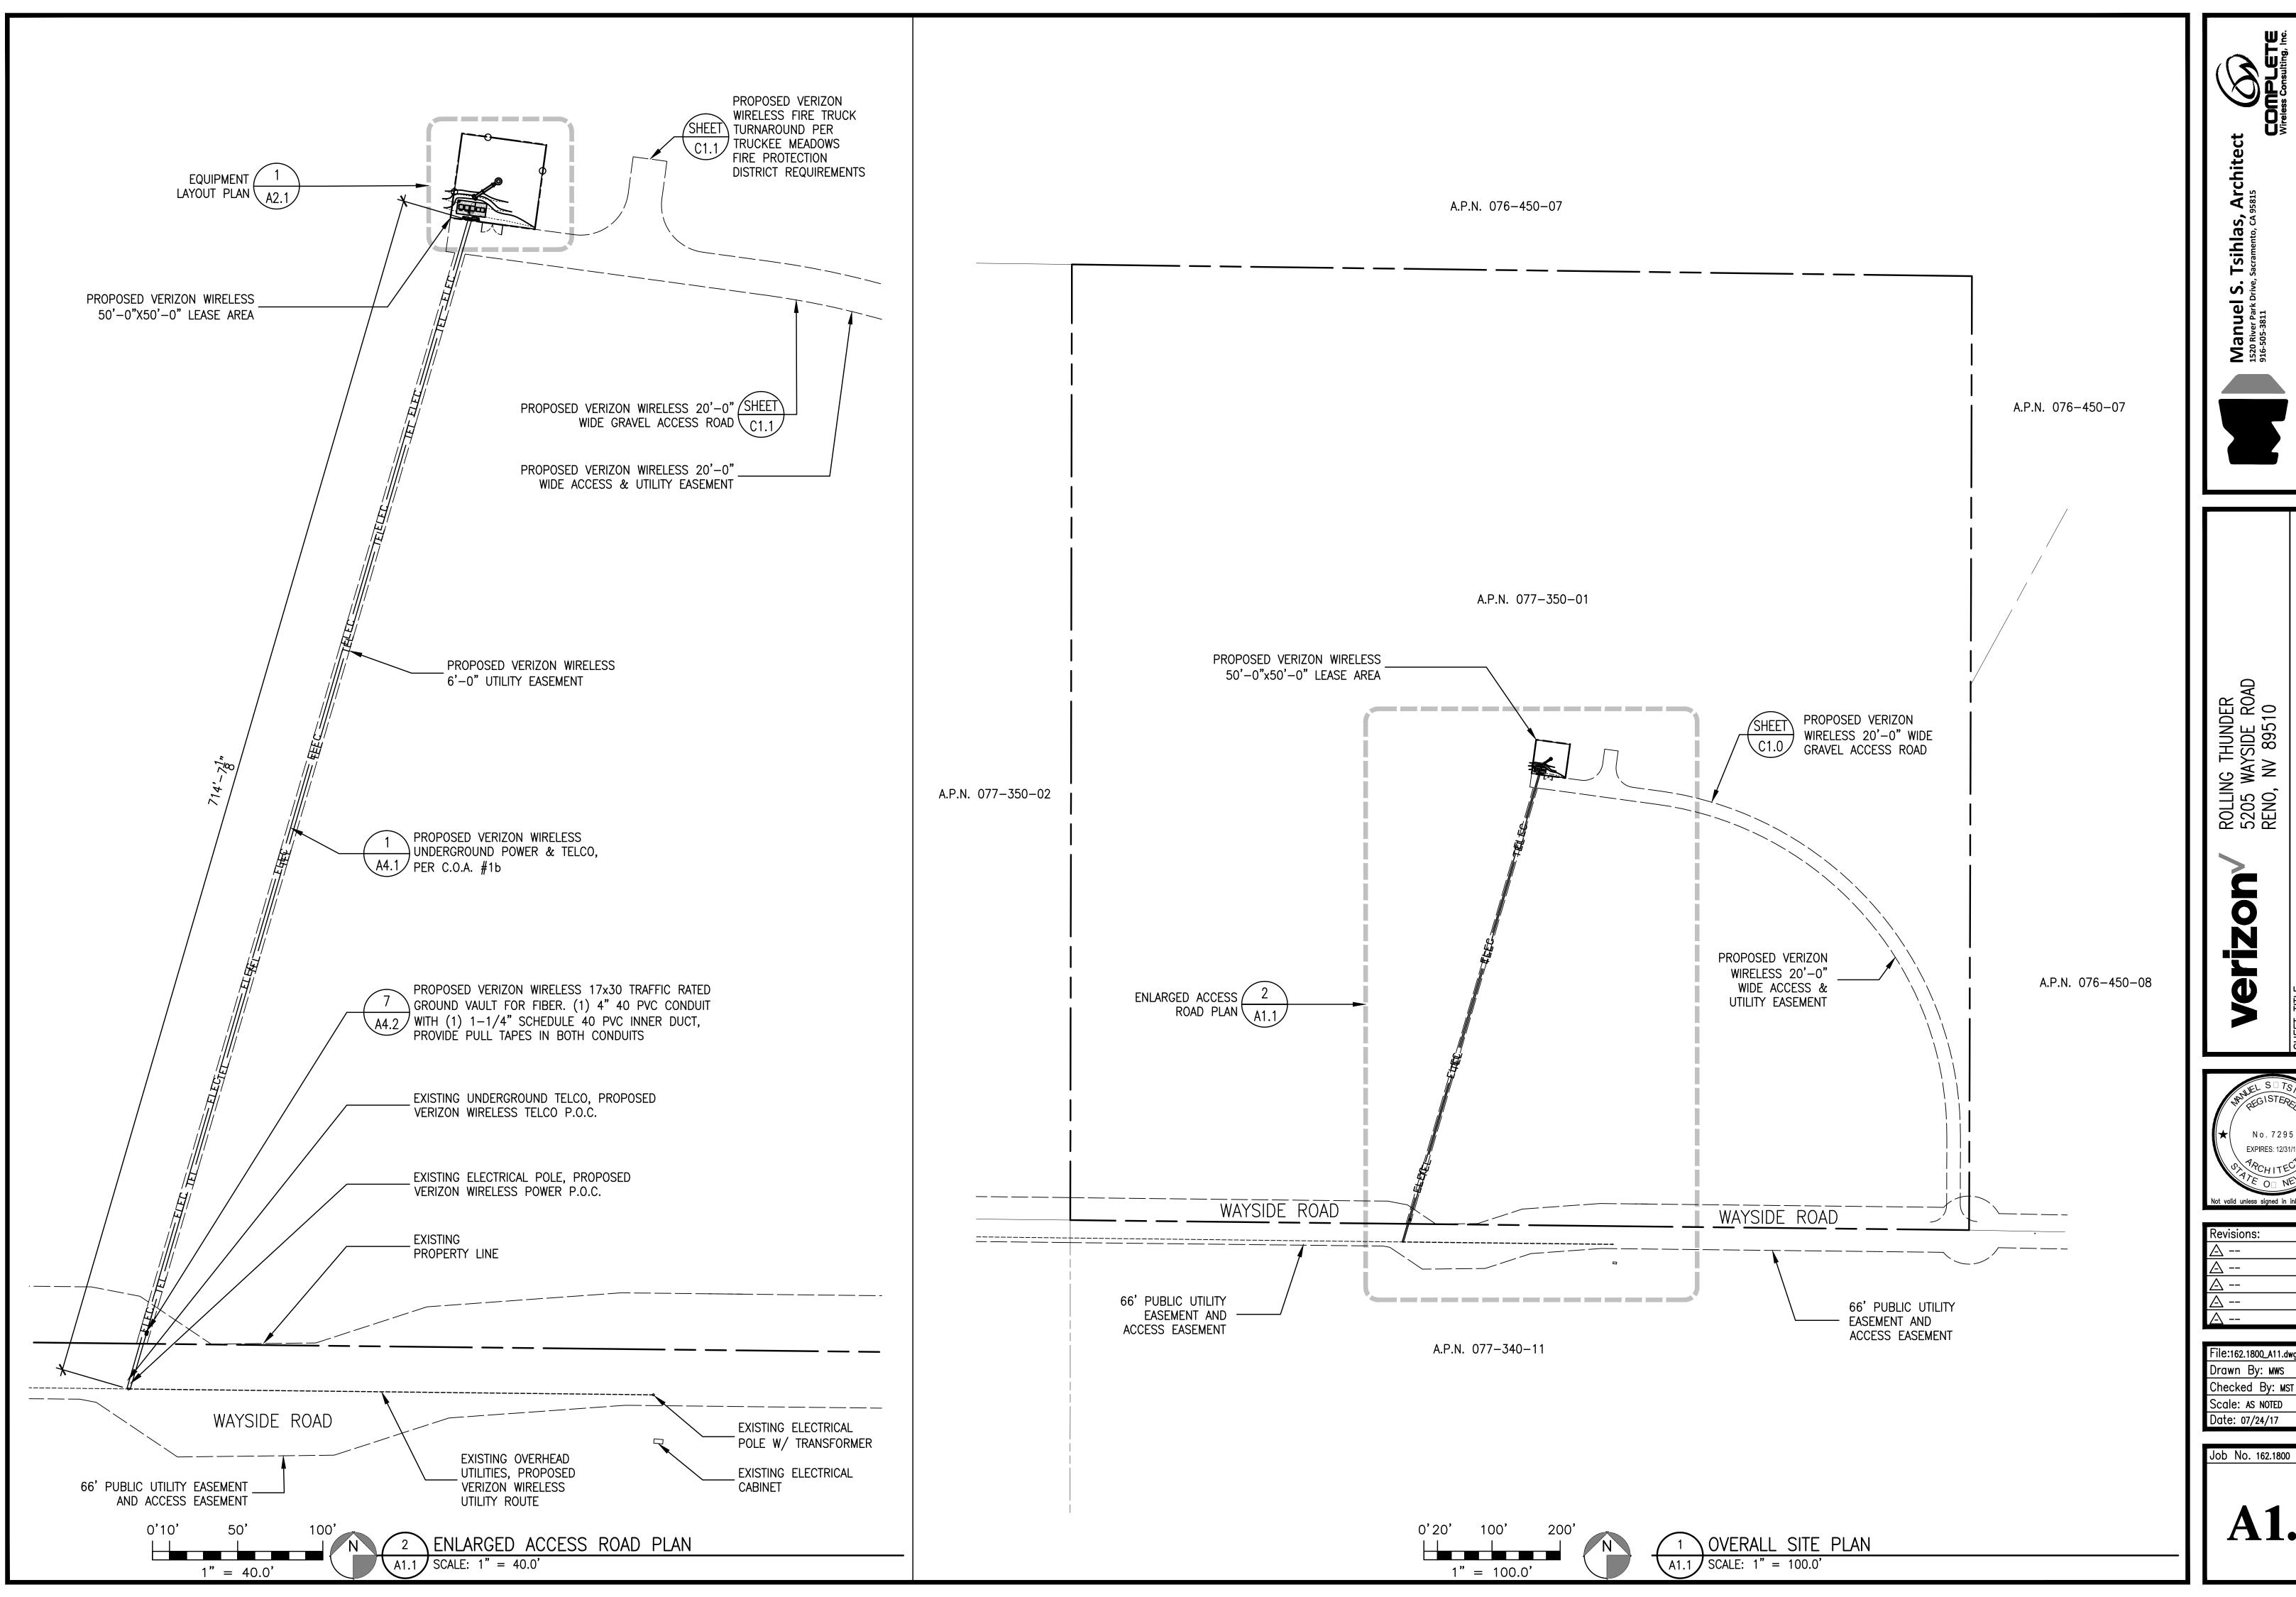

INSTRUMENTS OF SERVICE, ARE AND SHALL REMAIN THE PROPERTY OF MANUEL S. THESE DRAWINGS AND SPECIFICATIONS SHALL NOT BE USED BY ANY PERSON OR I MANUEL S. TSHLAS, ARCHITECT ALL RIGHTS RESERVED.

PLAN ROAD

ACCESS

ENLARGED

SITE


HEET TITLE: OVERALL

verizon

No.7295 EXPIRES: 12/31/17 Not valid unless signed in ink by licensee.

Revisions:

File:162.1800_A11.dwg Drawn By: wws Checked By: MST Scale: AS NOTED Date: 07/24/17

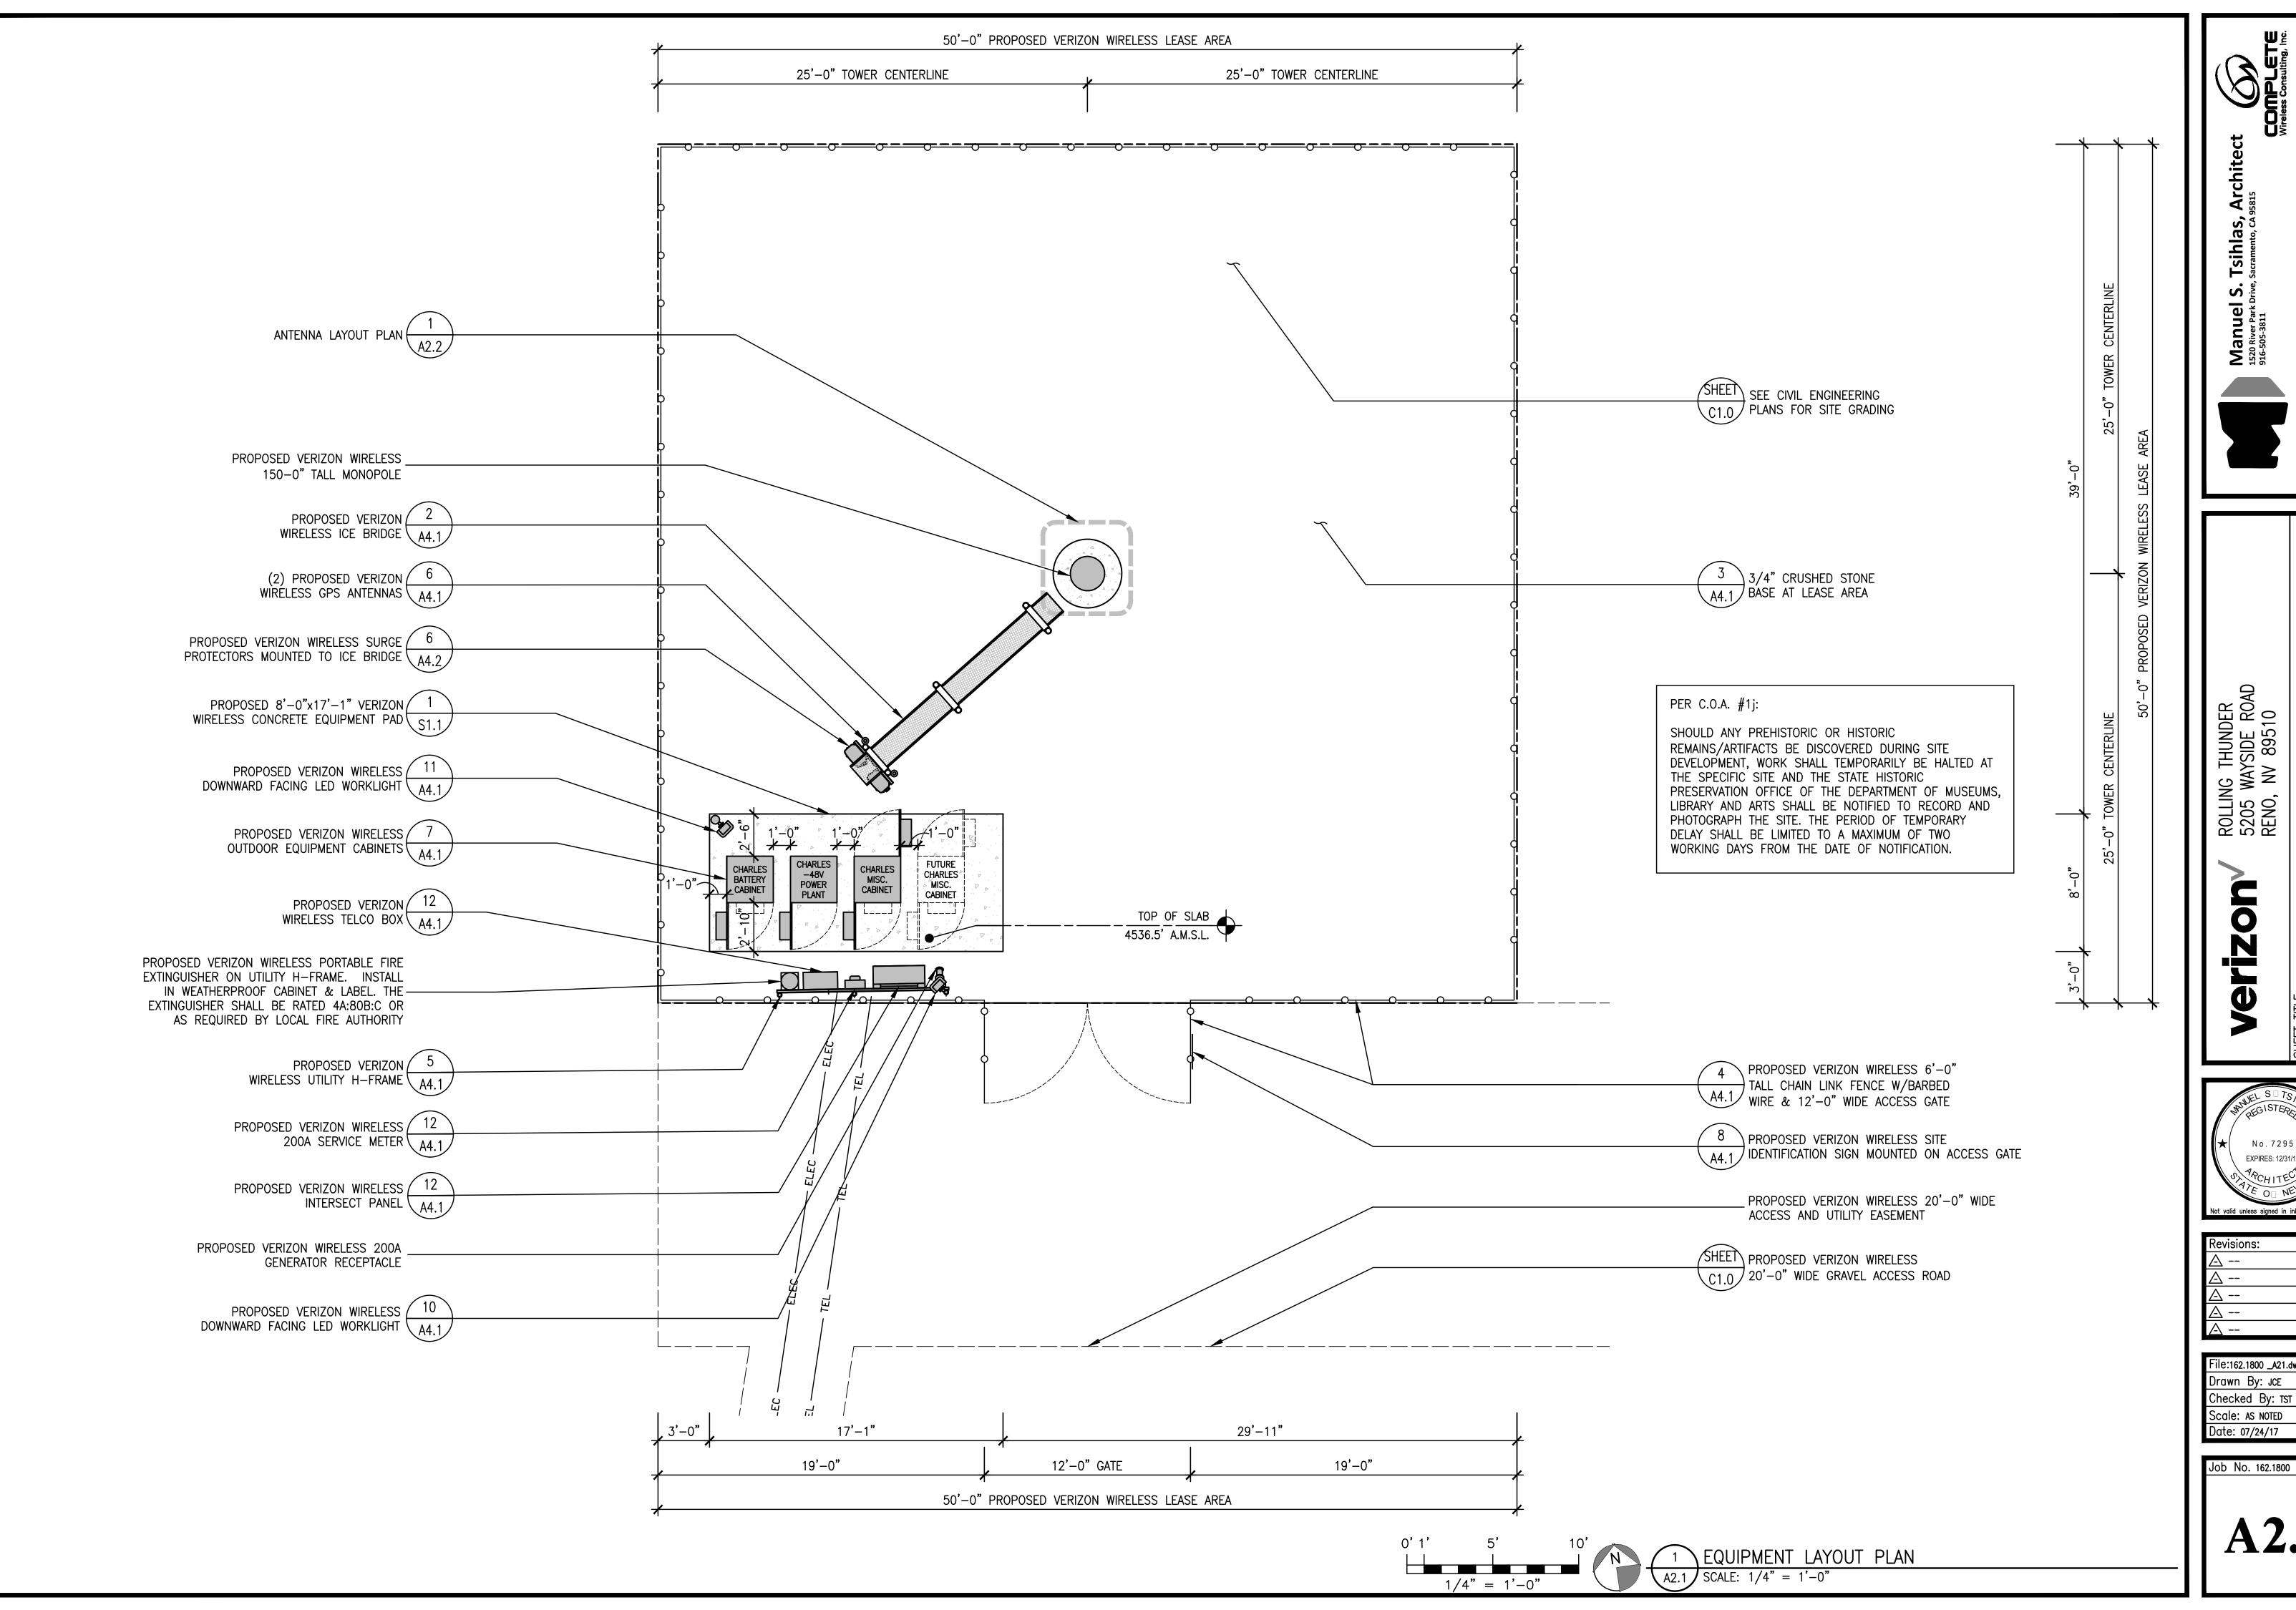



INSTRUMENTS OF SERVICE, ARE AND SHALL REWAIN THE PROPERTY OF MANUEL S. TSHLAS, THESE DRAWINGS AND SPECIFICATIONS SHALL NOT BE USED BY ANY PERSON OR ENTITY ON MANUEL S. TSHLAS, ARCHITECT ALL RIGHTS RESERVED.

LAYOUT


EQUIPME

rerizon


No.7295 EXPIRES: 12/31/17 Not valid unless signed in ink by licensee.

Revisions:

File:162.1800 _A21.dwg Drawn By: JCE Checked By: TST Scale: AS NOTED Date: 07/24/17

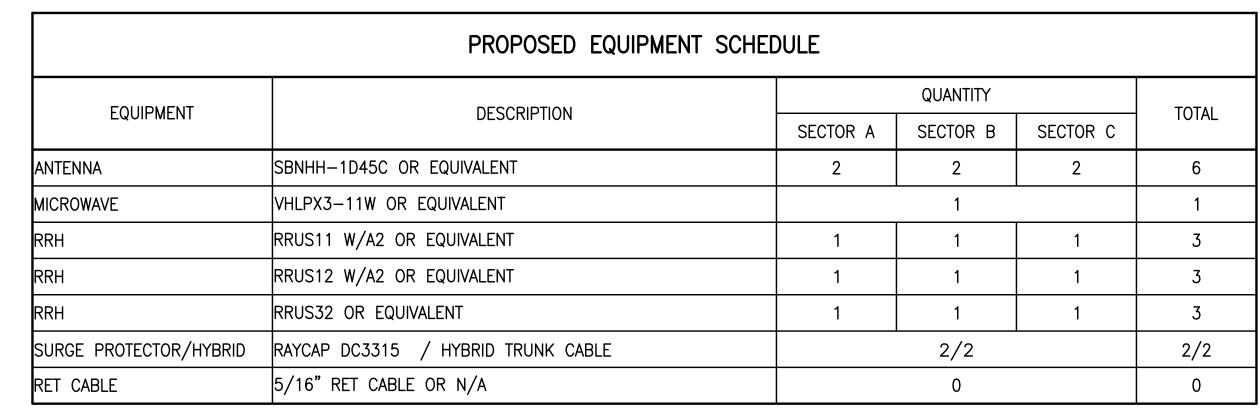

	FUTURE EQUIPMENT SCHEDU	JLE			
EQUIPMENT	DESCRIPTION	QUANTITY			TOTAL
EQUIFMENT	DESCRIPTION	SECTOR A	SECTOR B	SECTOR C	IOIAL
ANTENNA	TO BE DETERMINED	1	1	1	3

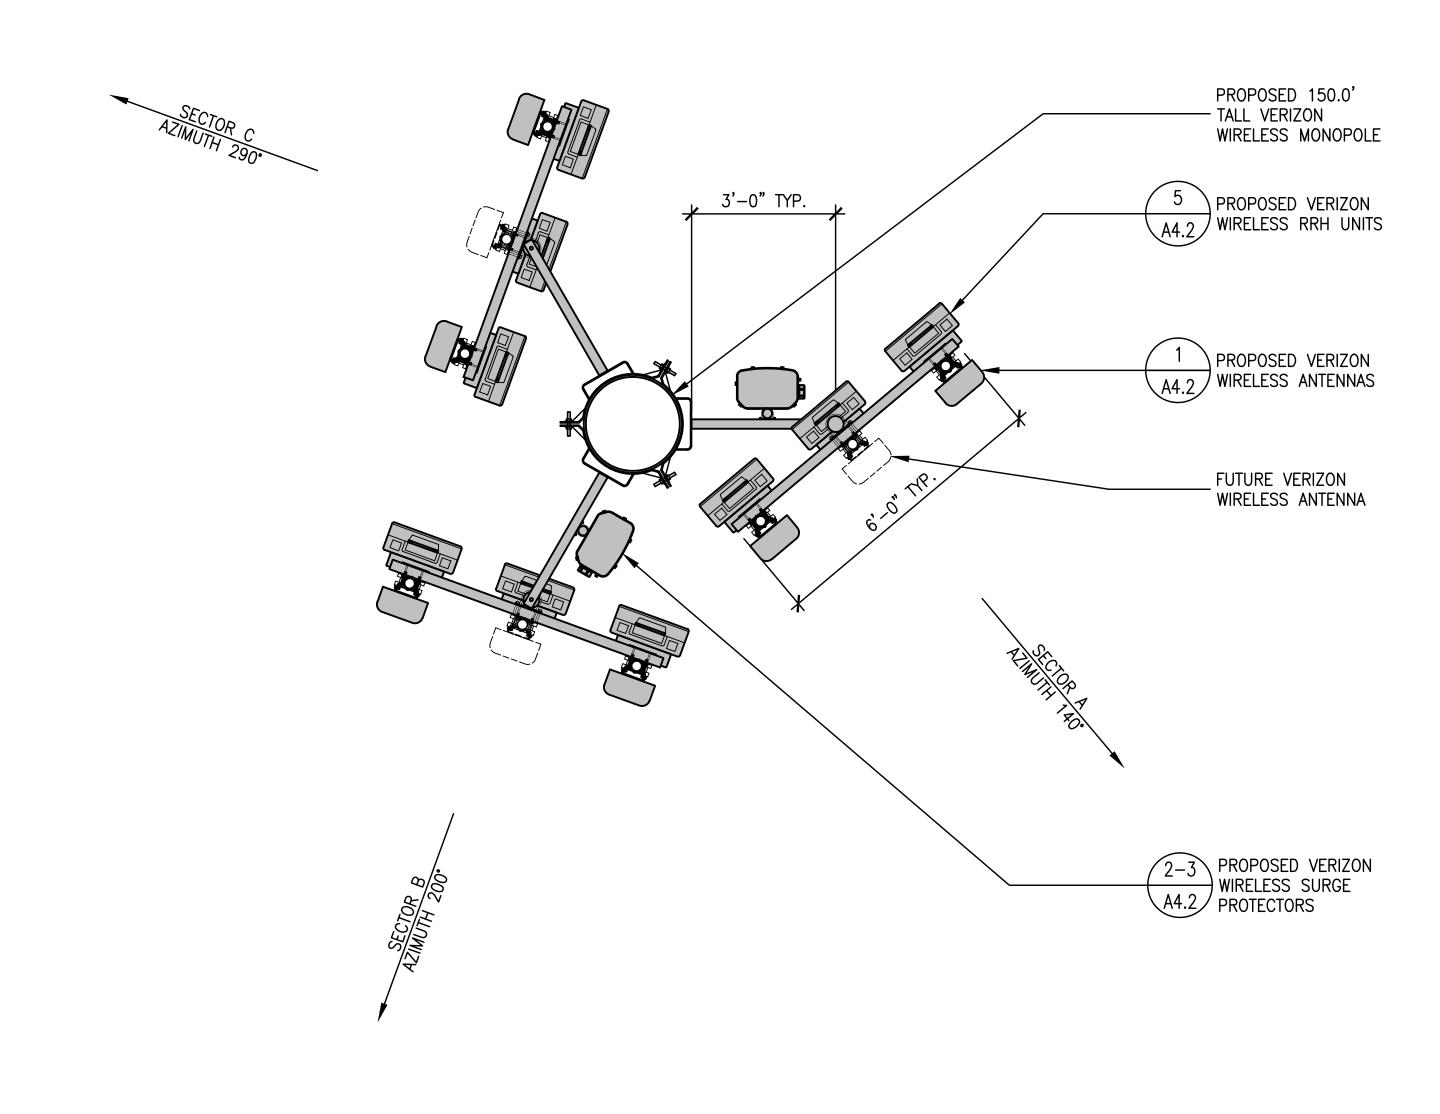





ROLLING THUNDER 5205 WAYSIDE ROAD RENO, NV 89510

LAYOUT

ANTENI


verizon

Not valid unless signed in ink by licensee.

Revisions:
△
△
△
△
<u> </u>

File:162.1800_A22.dwg Drawn By: wws Checked By: TST Scale: AS NOTED Date: 07/24/17

Job No. 162.1800

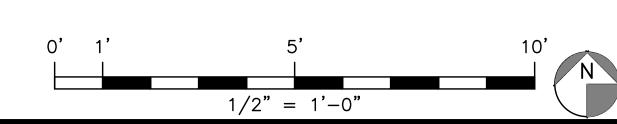

PROPOSED VERIZON WIRELESS 48"x62" ICE 4

SHIELD ABOVE (SHOWN DASHED) A4.2

MICROWAVE

AZIMUTH 261.01° TN

(SHOOTING TO WARM SPRINGS)

PROPOSED VERIZON WIRELESS _ VHLPX3-11W MICROWAVE DISH


MICROWAVE LAYOUT PLAN AT 50.0' A.G.L.


SCALE: 1/2" = 1'-0"

PROPOSED 150.0'


— TALL VERIZON

WIRELESS MONOPOLE

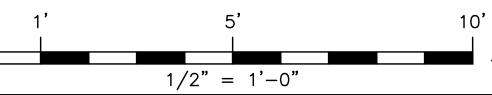

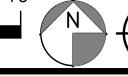



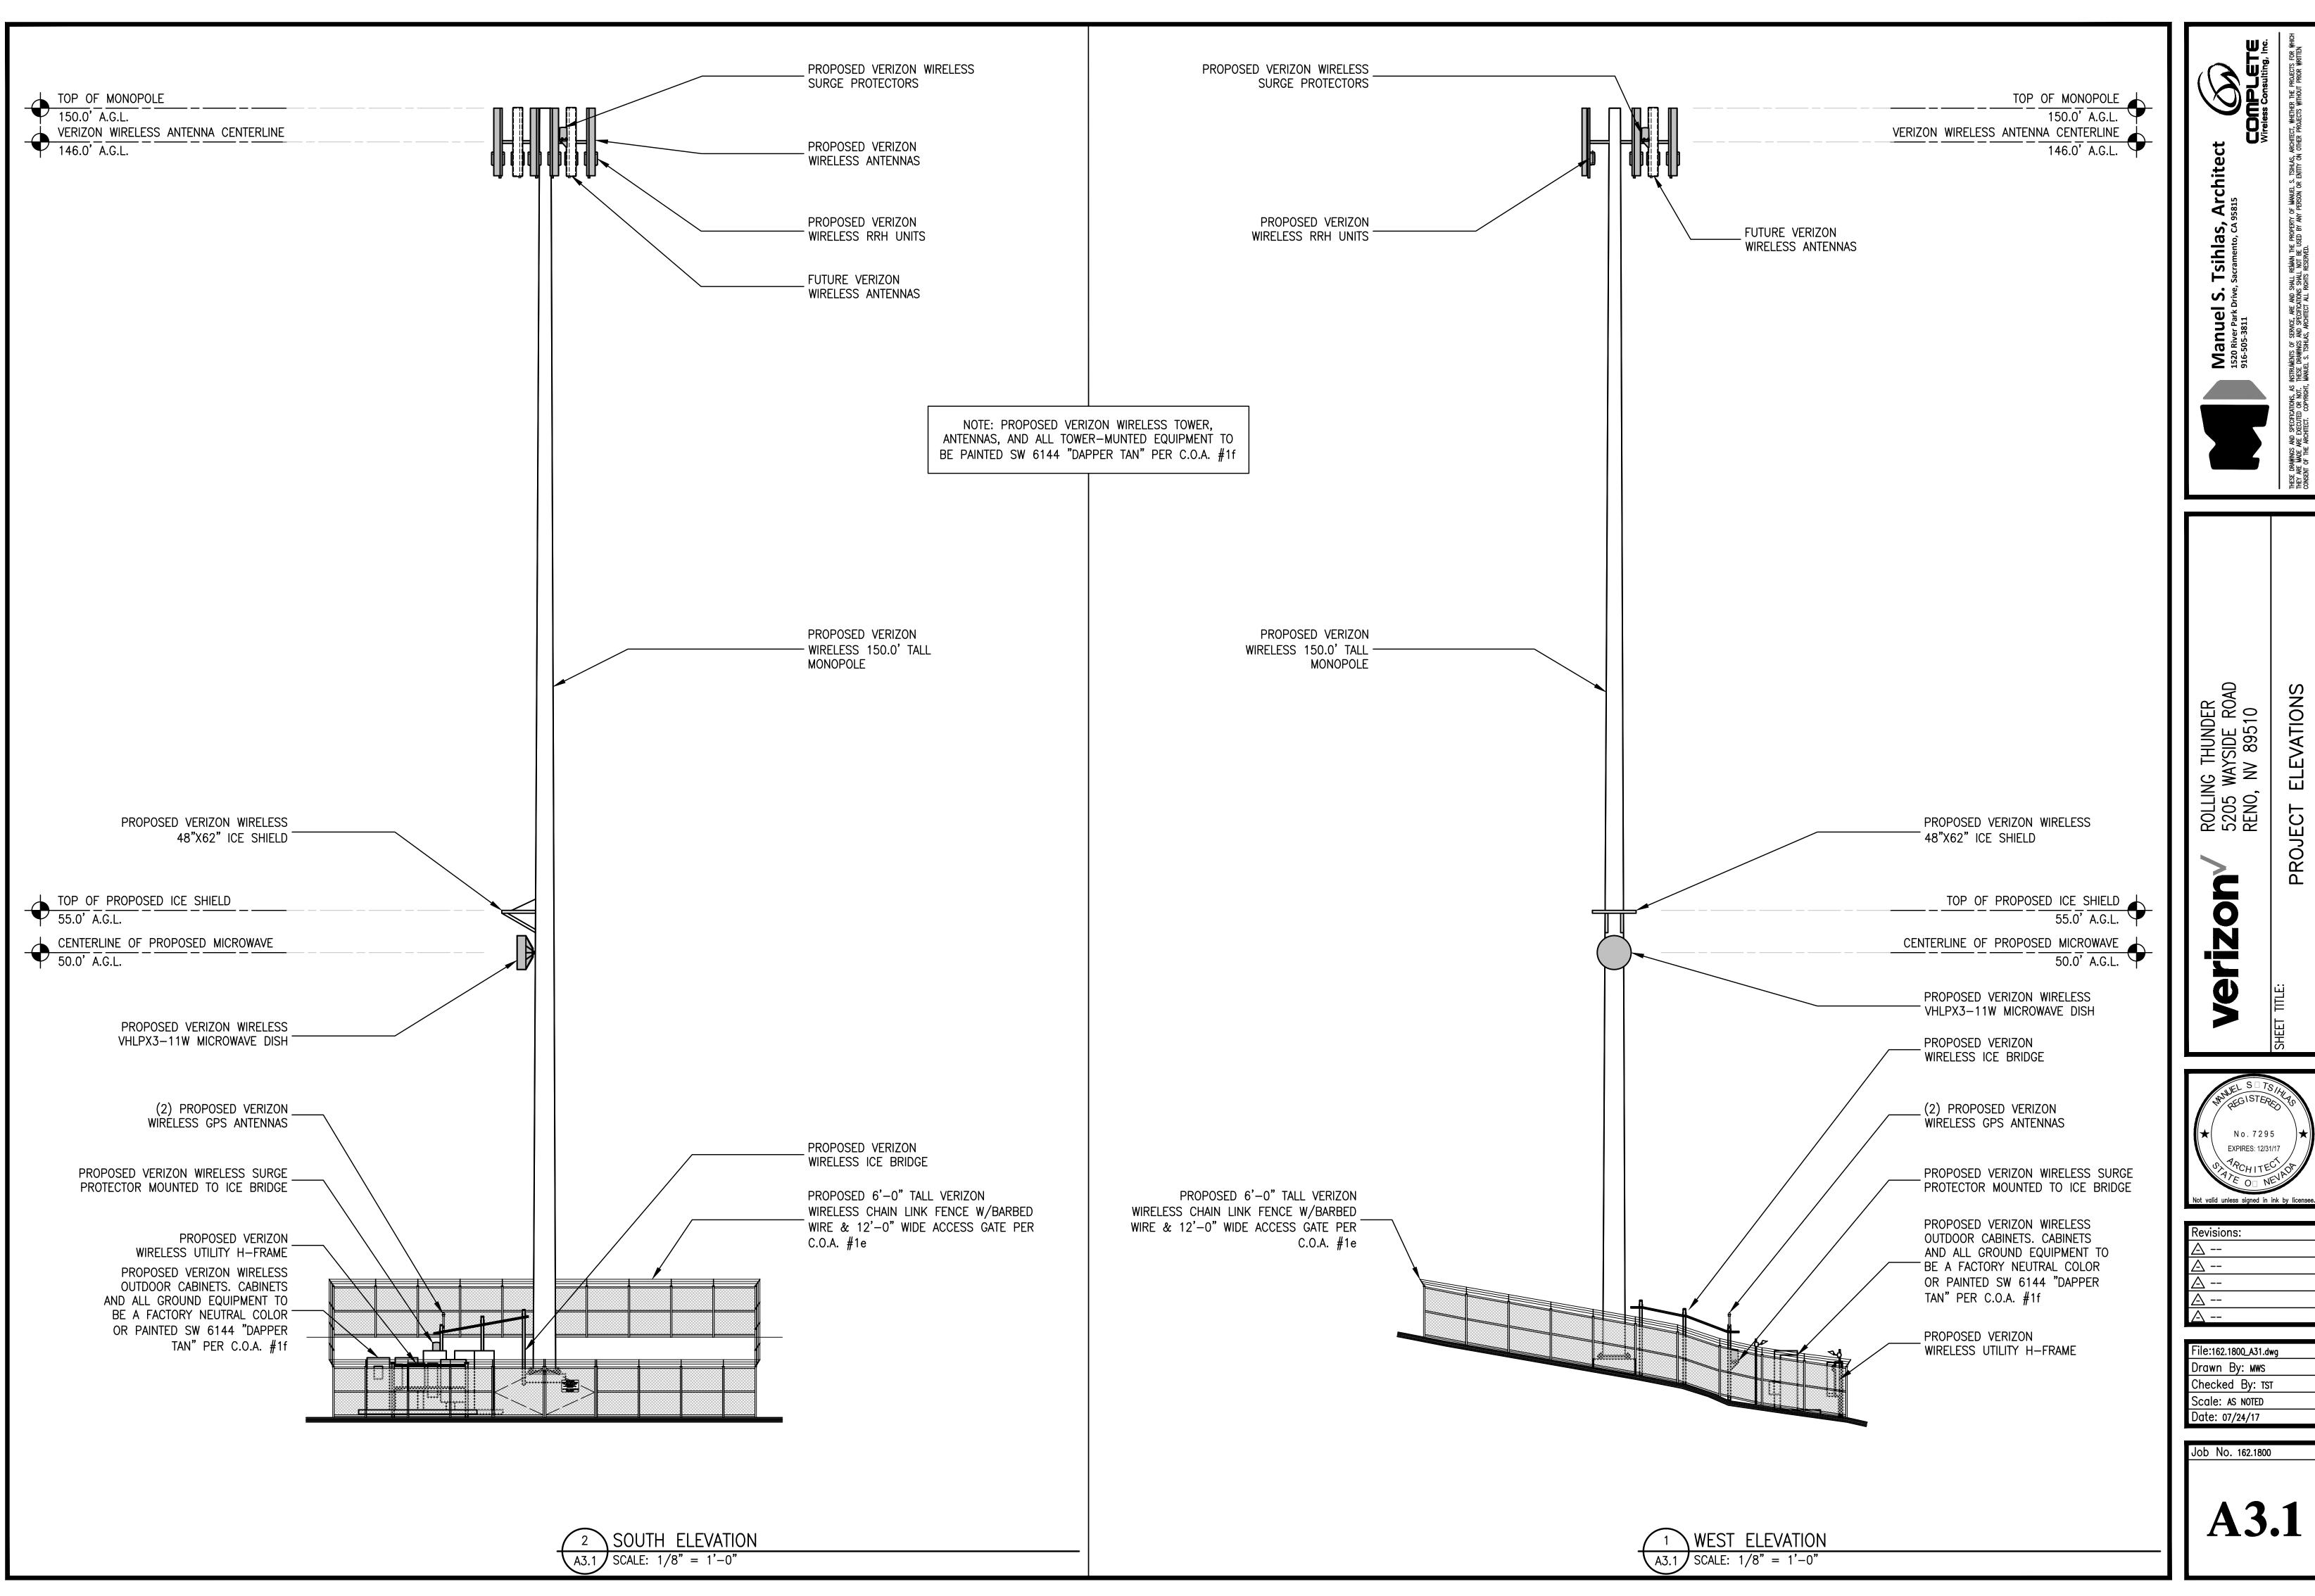


ELEVATIONS


PROJECT

No.7295 EXPIRES: 12/31/17

Revisions:

File:162.1800_A31.dwg Drawn By: wws Checked By: TST Scale: AS NOTED Date: 07/24/17

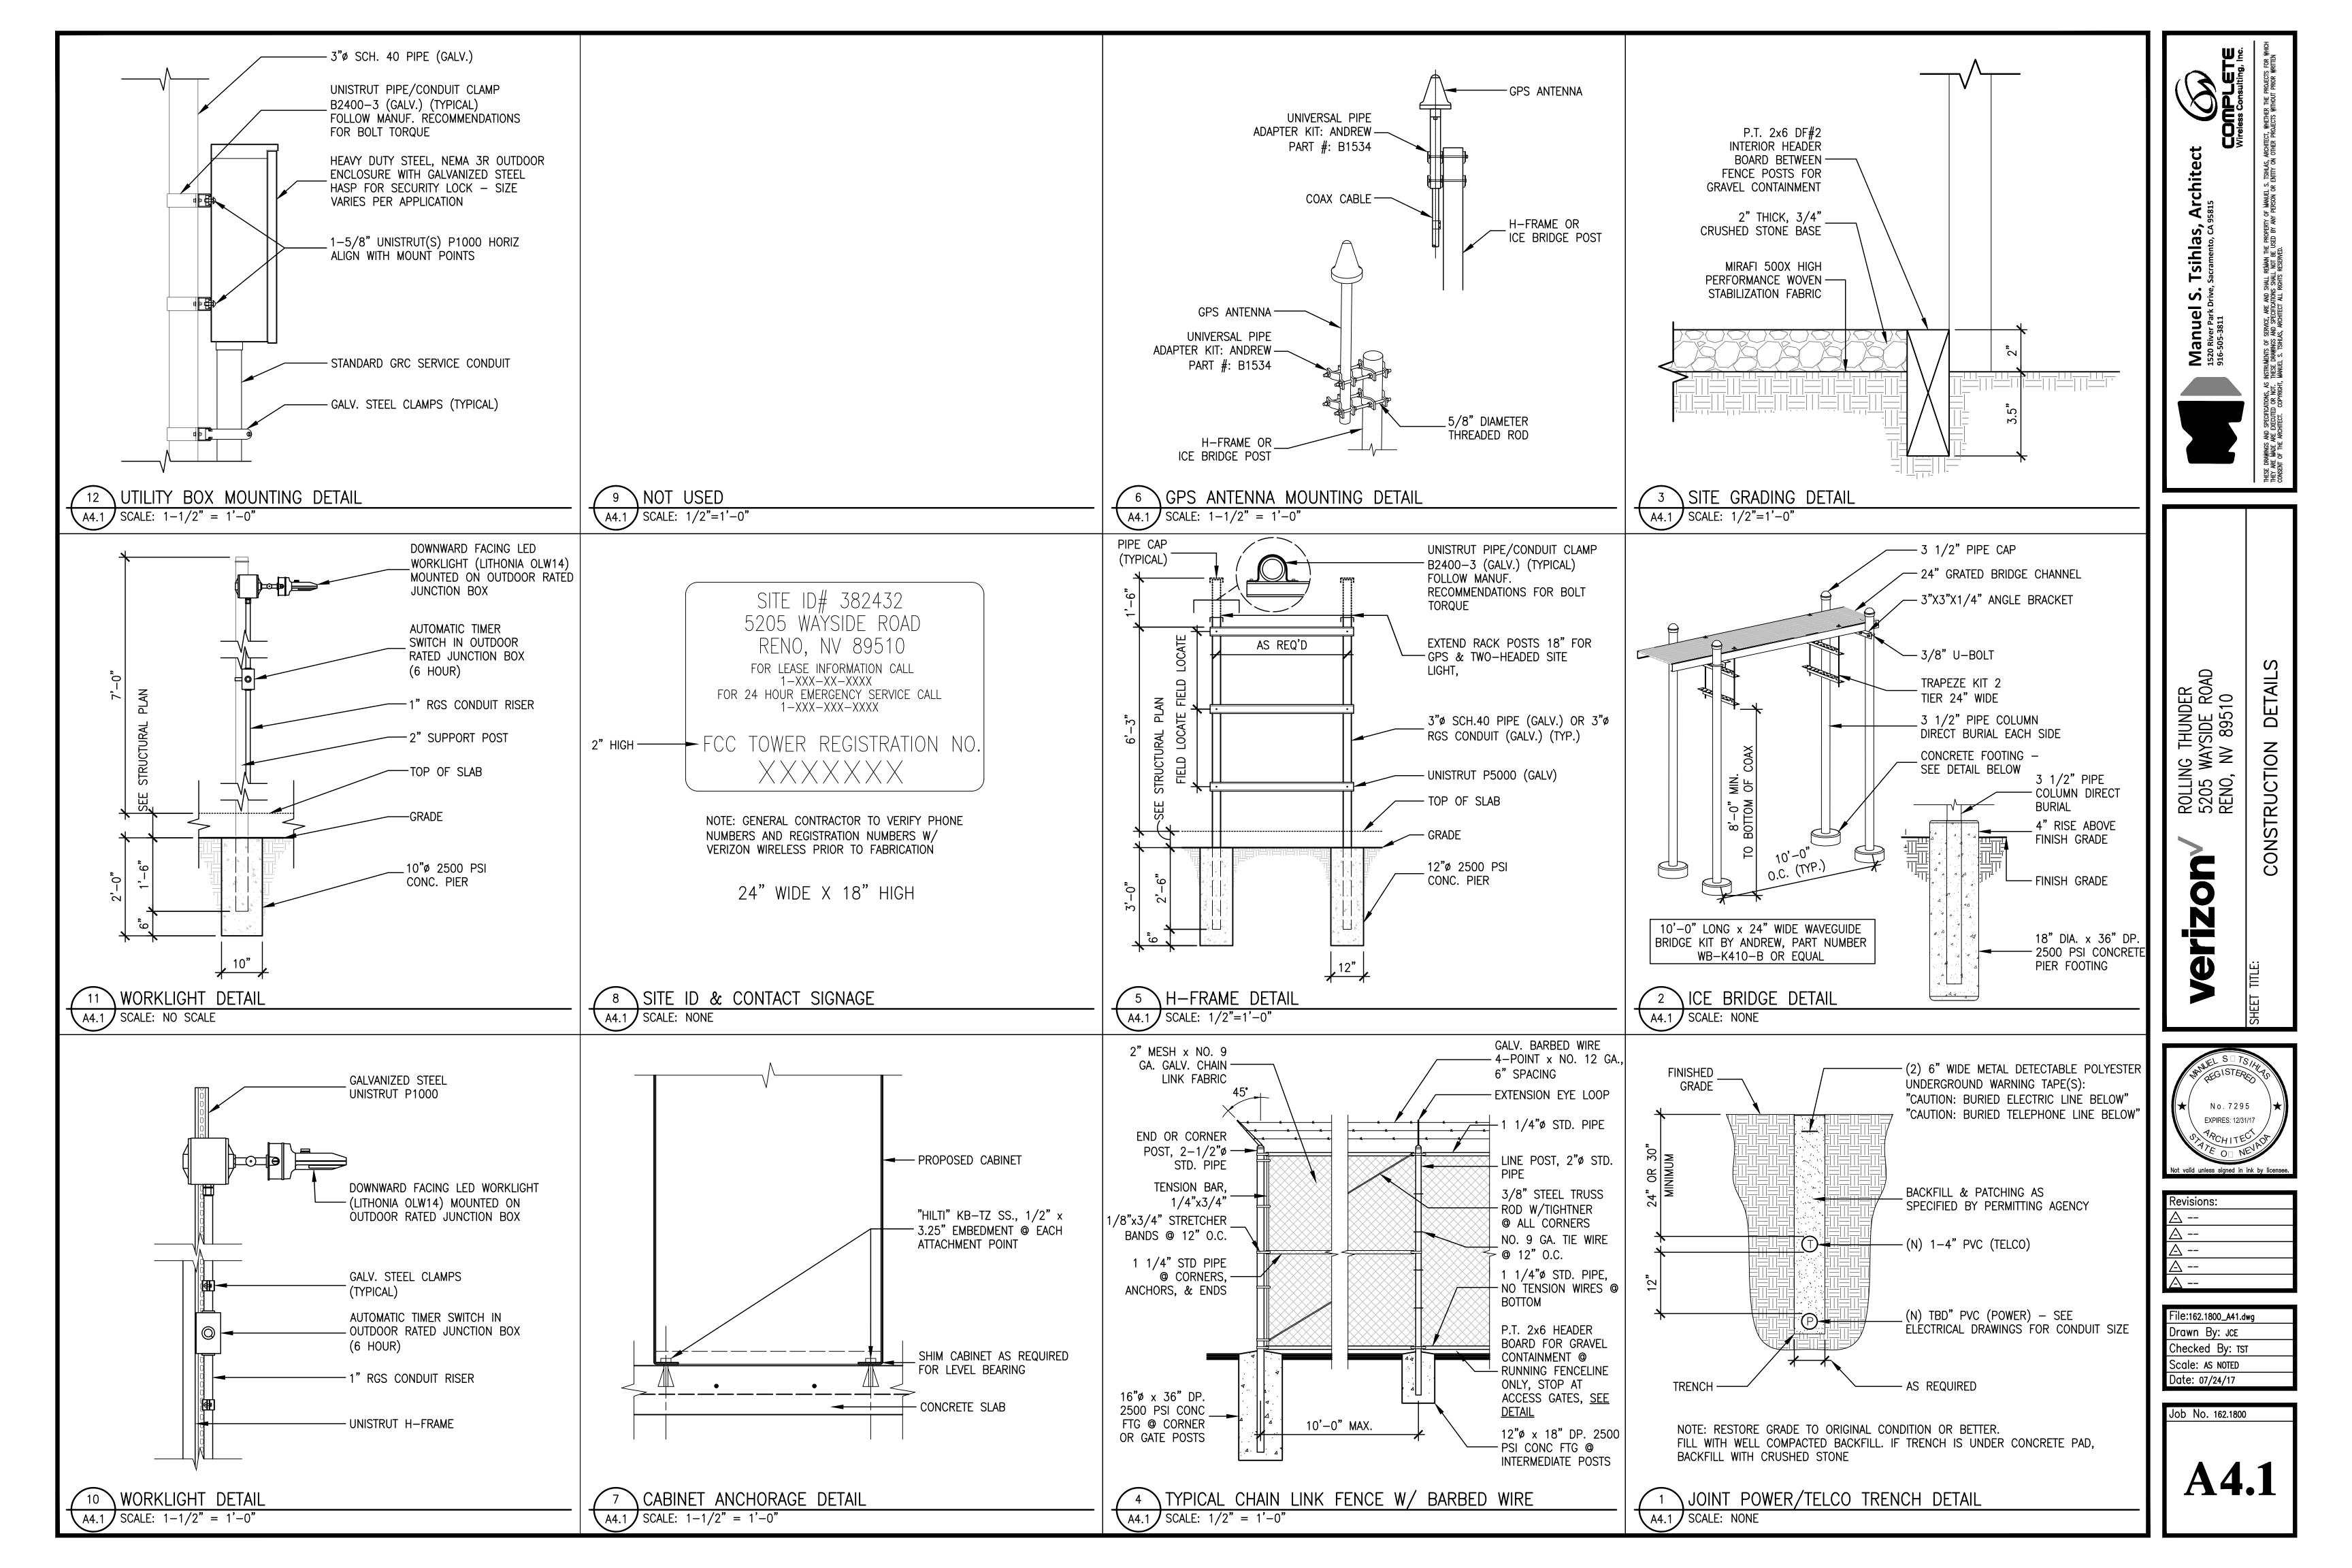

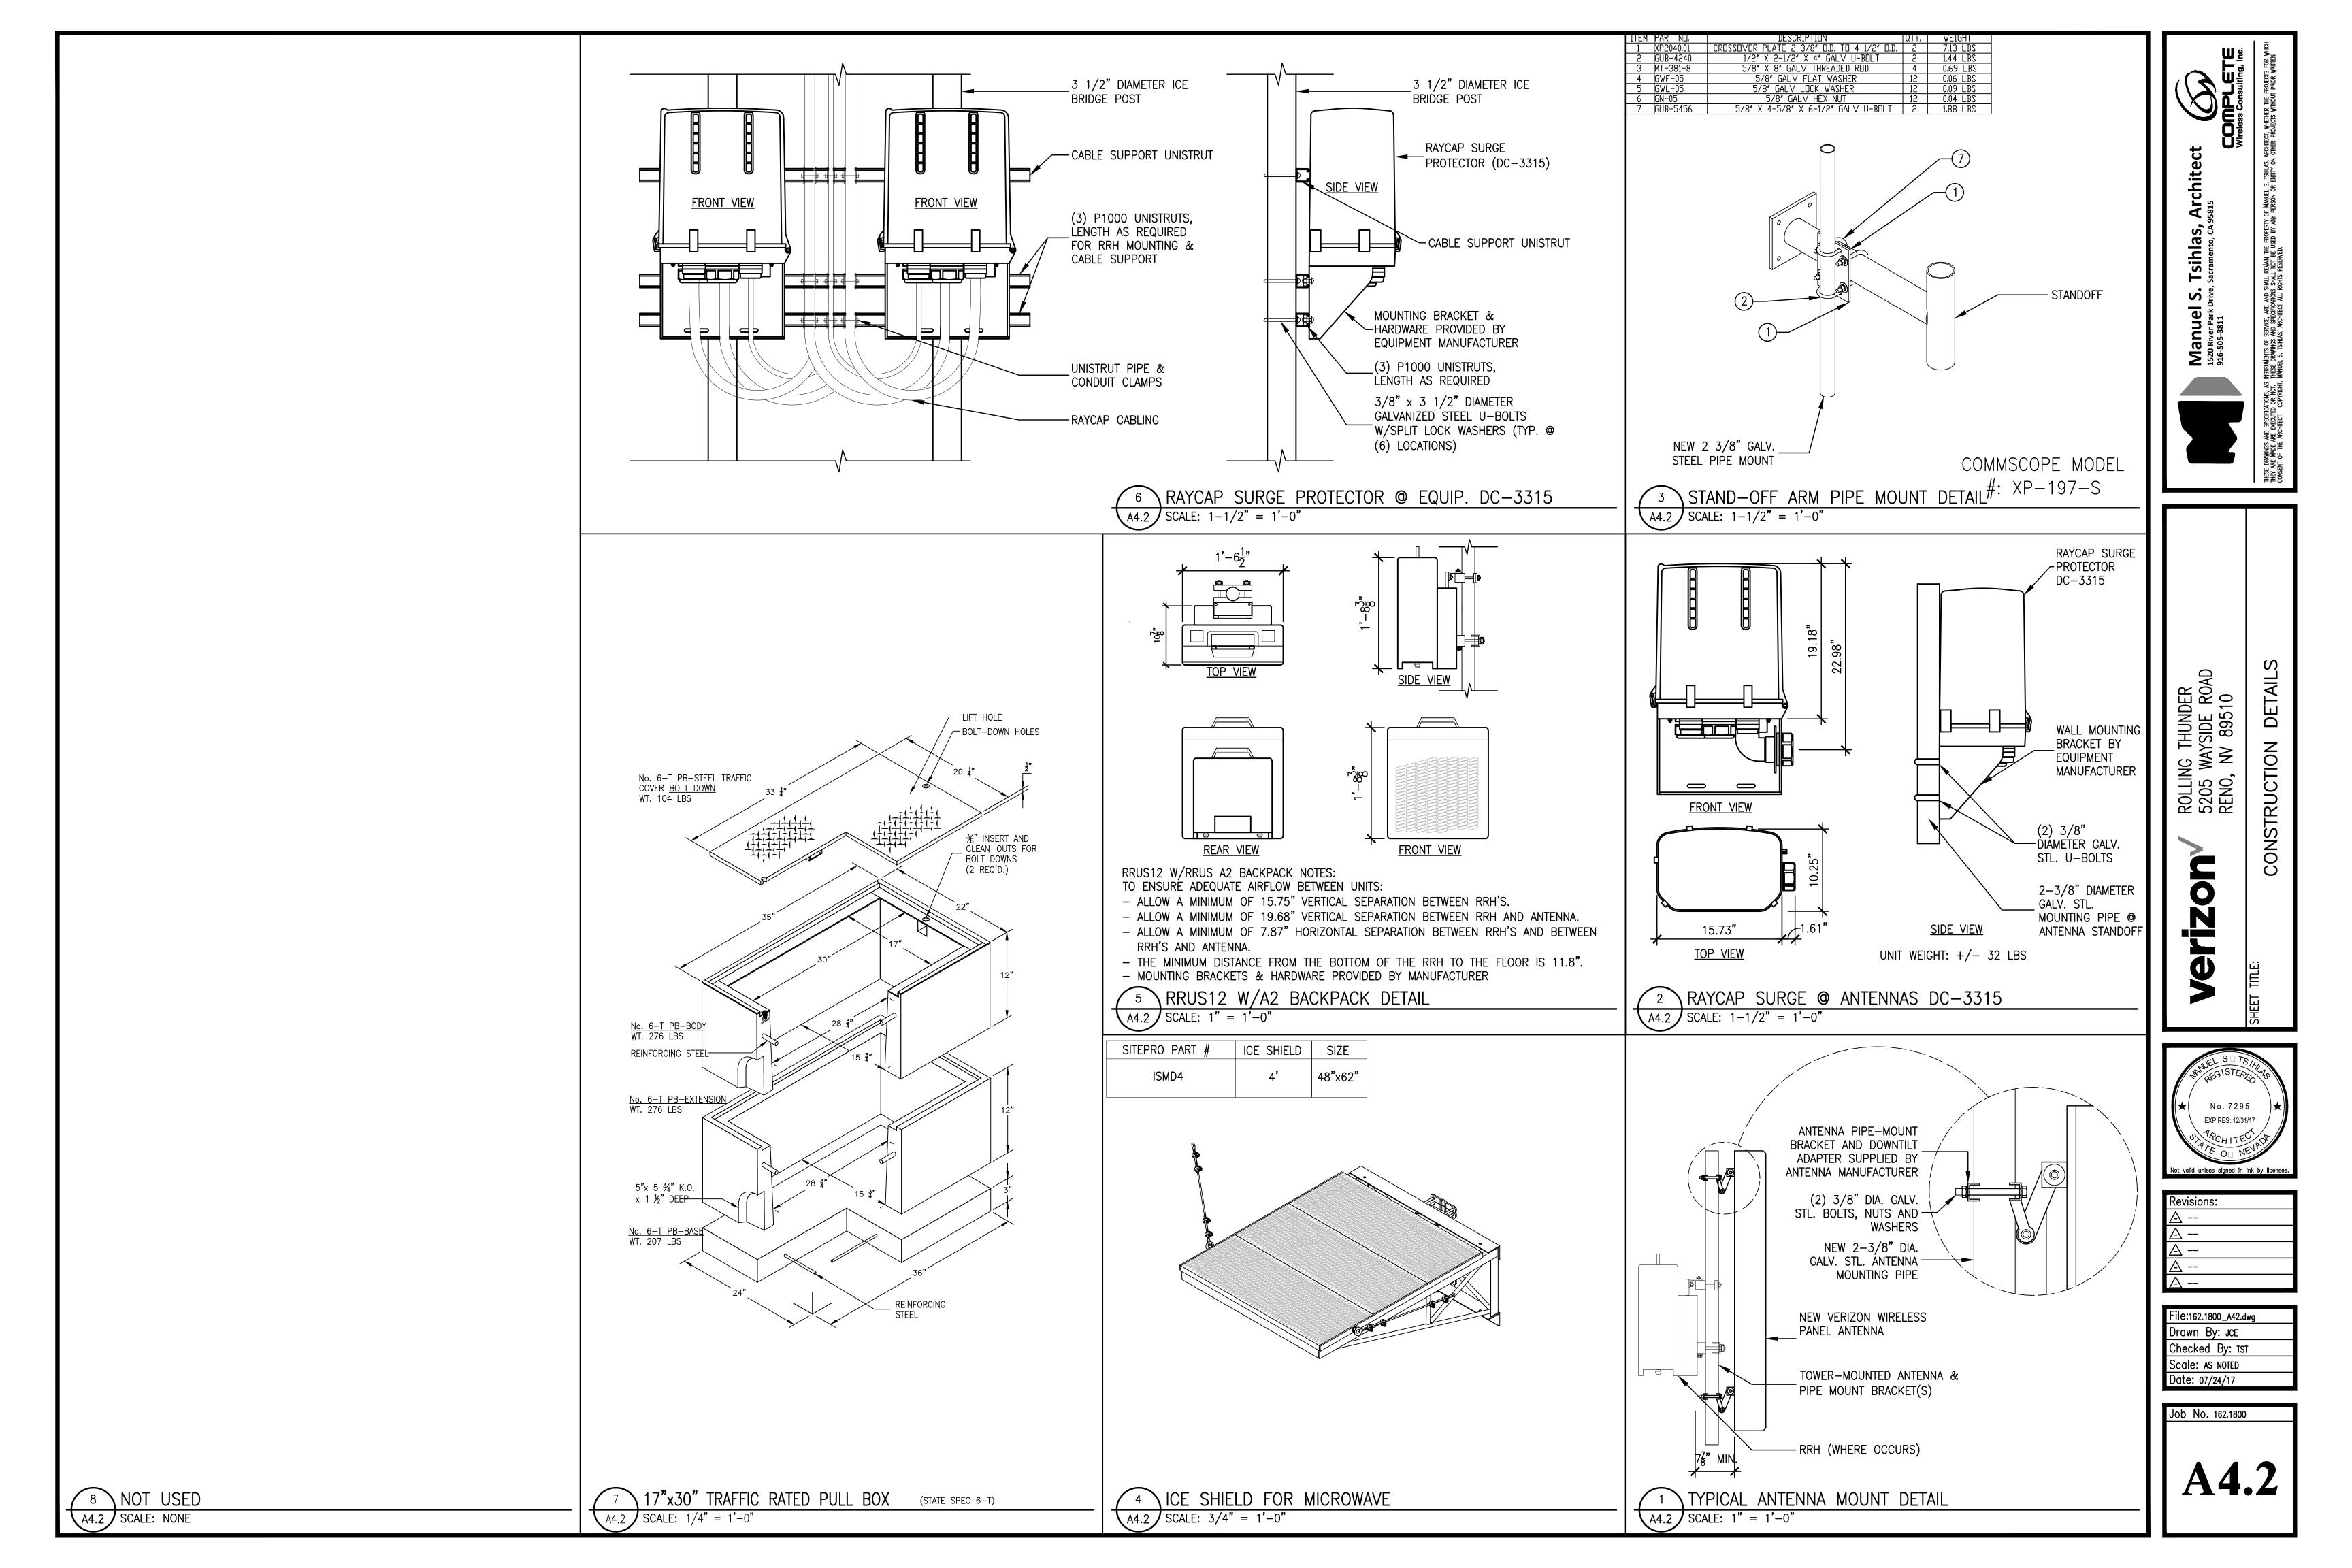

Revisions:
△
△
△
△
△


File:162.1800_A43.dwg Drawn By: JCE
Checked By: TST Scale: AS NOTED
Date: 07/24/17

Job No. 162.1800

	VEINZON	MIRELESS COAX MINE LINE & JUMPERS		(REV 5)
ALPHA	MAIN/JUMPER ALPHA 850	MAIN/JUMPER ALPHA LTE	MAIN/JUMPER ALPHA PCS	MAIN/JUMPER ALPHA AW
LINE 1	YR	PPYR	PYR	PYRP
LINE 2	YG	PPYG	PYG	PYGP
<u>BETA</u>	MAIN/JUMPER BETA 850	MAIN/JUMPER BETA LTE	MAIN/JUMPER BETA PCS	MAIN/JUMPER BETA AWS
LINE 1	BR	PPBR	PBR	PBRP
LINE 2	BG	PPBG	PBG	PBGP
<u>GAMMA</u>	MAIN/JUMPER GAMMA 850	MAIN/JUMPER GAMMA LTE	MAIN/JUMPER GAMMA PCS	MAIN/JUMPER GAMMA AW
LINE 1	OR	PPOR	POR	PORP
LINE 2	OG	PPOG	POG	POGP
•		RRU/A2/TRIPLEXER/DIPEXE	R BELOW:	
	PCS A-2/LTE _4 WAY/RX	LTE A-2/LTE _4 WAY/RX	AWS A-2/LTE _4 WAY/RX	850 LTE _(FUTURE)
LINE 1	ALPHA 1PYRW	ALPHA 1PPYRW	ALPHA 1PYRPW	ALPHA 1PPPYG
LINE 2	ALPHA 2PYGW	ALPHA 2PPYGW	ALPHA 2PYGPW	ALPHA 2PPPYG
LINE 1	BETA 1PBRW	BETA 1PPBRW	BETA 1PBRPW	BETA 1PPPBR
LINE 2	BETA 2PBGW	BETA 2PPBGW	BETA 2PBGPW	BETA 2PPPBG
LINE 1	GAMMA 1PORW	GAMMA 1PPORW	GAMMA 1PORPW	GAMMA 1PPPOR
LINE 2	GAMMA 2POGW	GAMMA 2PPOGW	GAMMA 2POGPW	GAMMA 2PPPOG
	DIPLEXERS/TRIPLEXERS #1 SET (ANY FREQ)	DIPLEXERS/TRIPLEXERS #2 SET (ANY FREQ)	DIPLEXERS/TRIPLEXERS #3 SET (ANY FREQ)	TBD
LINE 1	ALPHA 1YY	ALPHA 1YYR	ALPHA 1YYG	
LINE 2	ALPHA 2YYY	ALPHA 2YYYR	ALPHA 2YYYG	
LINE 1	BETA 1BB	BETA 1BBR	BETA 1BBG	
LINE 2	BETA 2BBB	BETA 2BBBR	BETA 2BBBG	
LINE 1	GAMMA 100	GAMMA 1OOR	GAMMA 1OOG	
LINE 2	GAMMA 2000	GAMMA 2OOOR	GAMMA 2000G	
	COMBINERS PCS/AWS (HIGH BAND)	COMBINERS LTE(LOW BAND)	TBD	TBD
LINE 1	ALPHA 1PYY	ALPHA 1PPYY		
LINE 2	ALPHA 2PYYY	ALPHA 2PPYYY		
LINE 1	BETA 1PBB	BETA 1PPBB		
LINE 2	BETA 2PBBB	BETA 2PPBBB		
LINE 1	GAMMA 1POO	GAMMA 1PPOO		
LINE 2	GAMMA 2POOO	GAMMA 2PPOOO		


RAYCAP INSTALL GUIDE FOR 1-3 SECTOR SITES (REV 6)						
		RAYCAP #	1 FIBER CONNECTION	IS (1 – 3 SECTOR S	SITE)	
UPPER POSITION	7	8	9	10	11	12
FIBER CONNECTION	OPEN	OPEN	OPEN	AWS — A2 ALPHA 2	AWS — A2 BETA 2	AWS GAMMA 1
VZW COLOR CODE	OPEN	OPEN	OPEN	BR/P/Y/P/W	BR/P/B/P/W	BR/P/O/P/W
LOWER POSITION	1	2	3	4	5	6
FIBER CONNECTION	700 ALPHA 1	700 BETA 1	700 GAMMA 1	AWS ALPHA 1	AWS BETA 1	AWS GAMMA 1
FIBER COLOR CODE	BR/P/P/Y	BR/P/P/B	BR/P/P/O	BR/P/Y/P	BR/P/B/P	BR/P/O/P
POWER COLOR CODE	R/P/P/Y	R/P/P/B	R/P/P/0	R/P/Y/P	R/P/B/P	R/P/0/P
		RAYCAP #	2 FIBER CONNECTION	NS (1- 3 SECTOR SI	TE)	
UPPER POSITION	7	8	9	10	11	12
FIBER CONNECTION	OPEN	OPEN	OPEN	OPEN	OPEN	OPEN
VZW COLOR CODE	OPEN	OPEN	OPEN	OPEN	OPEN	OPEN
LOWER POSITION	1	2	3	4	5	6
FIBER CONNECTION	PCS ALPHA 1	PCS BETA 1	PCS GAMMA 1	850 ALPHA 1	850 BETA 1	850 GAMMA 1
FIBER COLOR CODE	BR/P/Y	BR/P/B	BR/P/O	BR/P/P/P/Y	BR/P/P/P/B	BR/P/P/P/O
POWER COLOR CODE	R/P/Y	R/P/B	R/P/O	R/P/P/P/Y	R/P/P/P/B	R/P/P/P/0

1 RRU/RAYCAP CONNECTION GUIDE
A4.3 SCALE: NONE

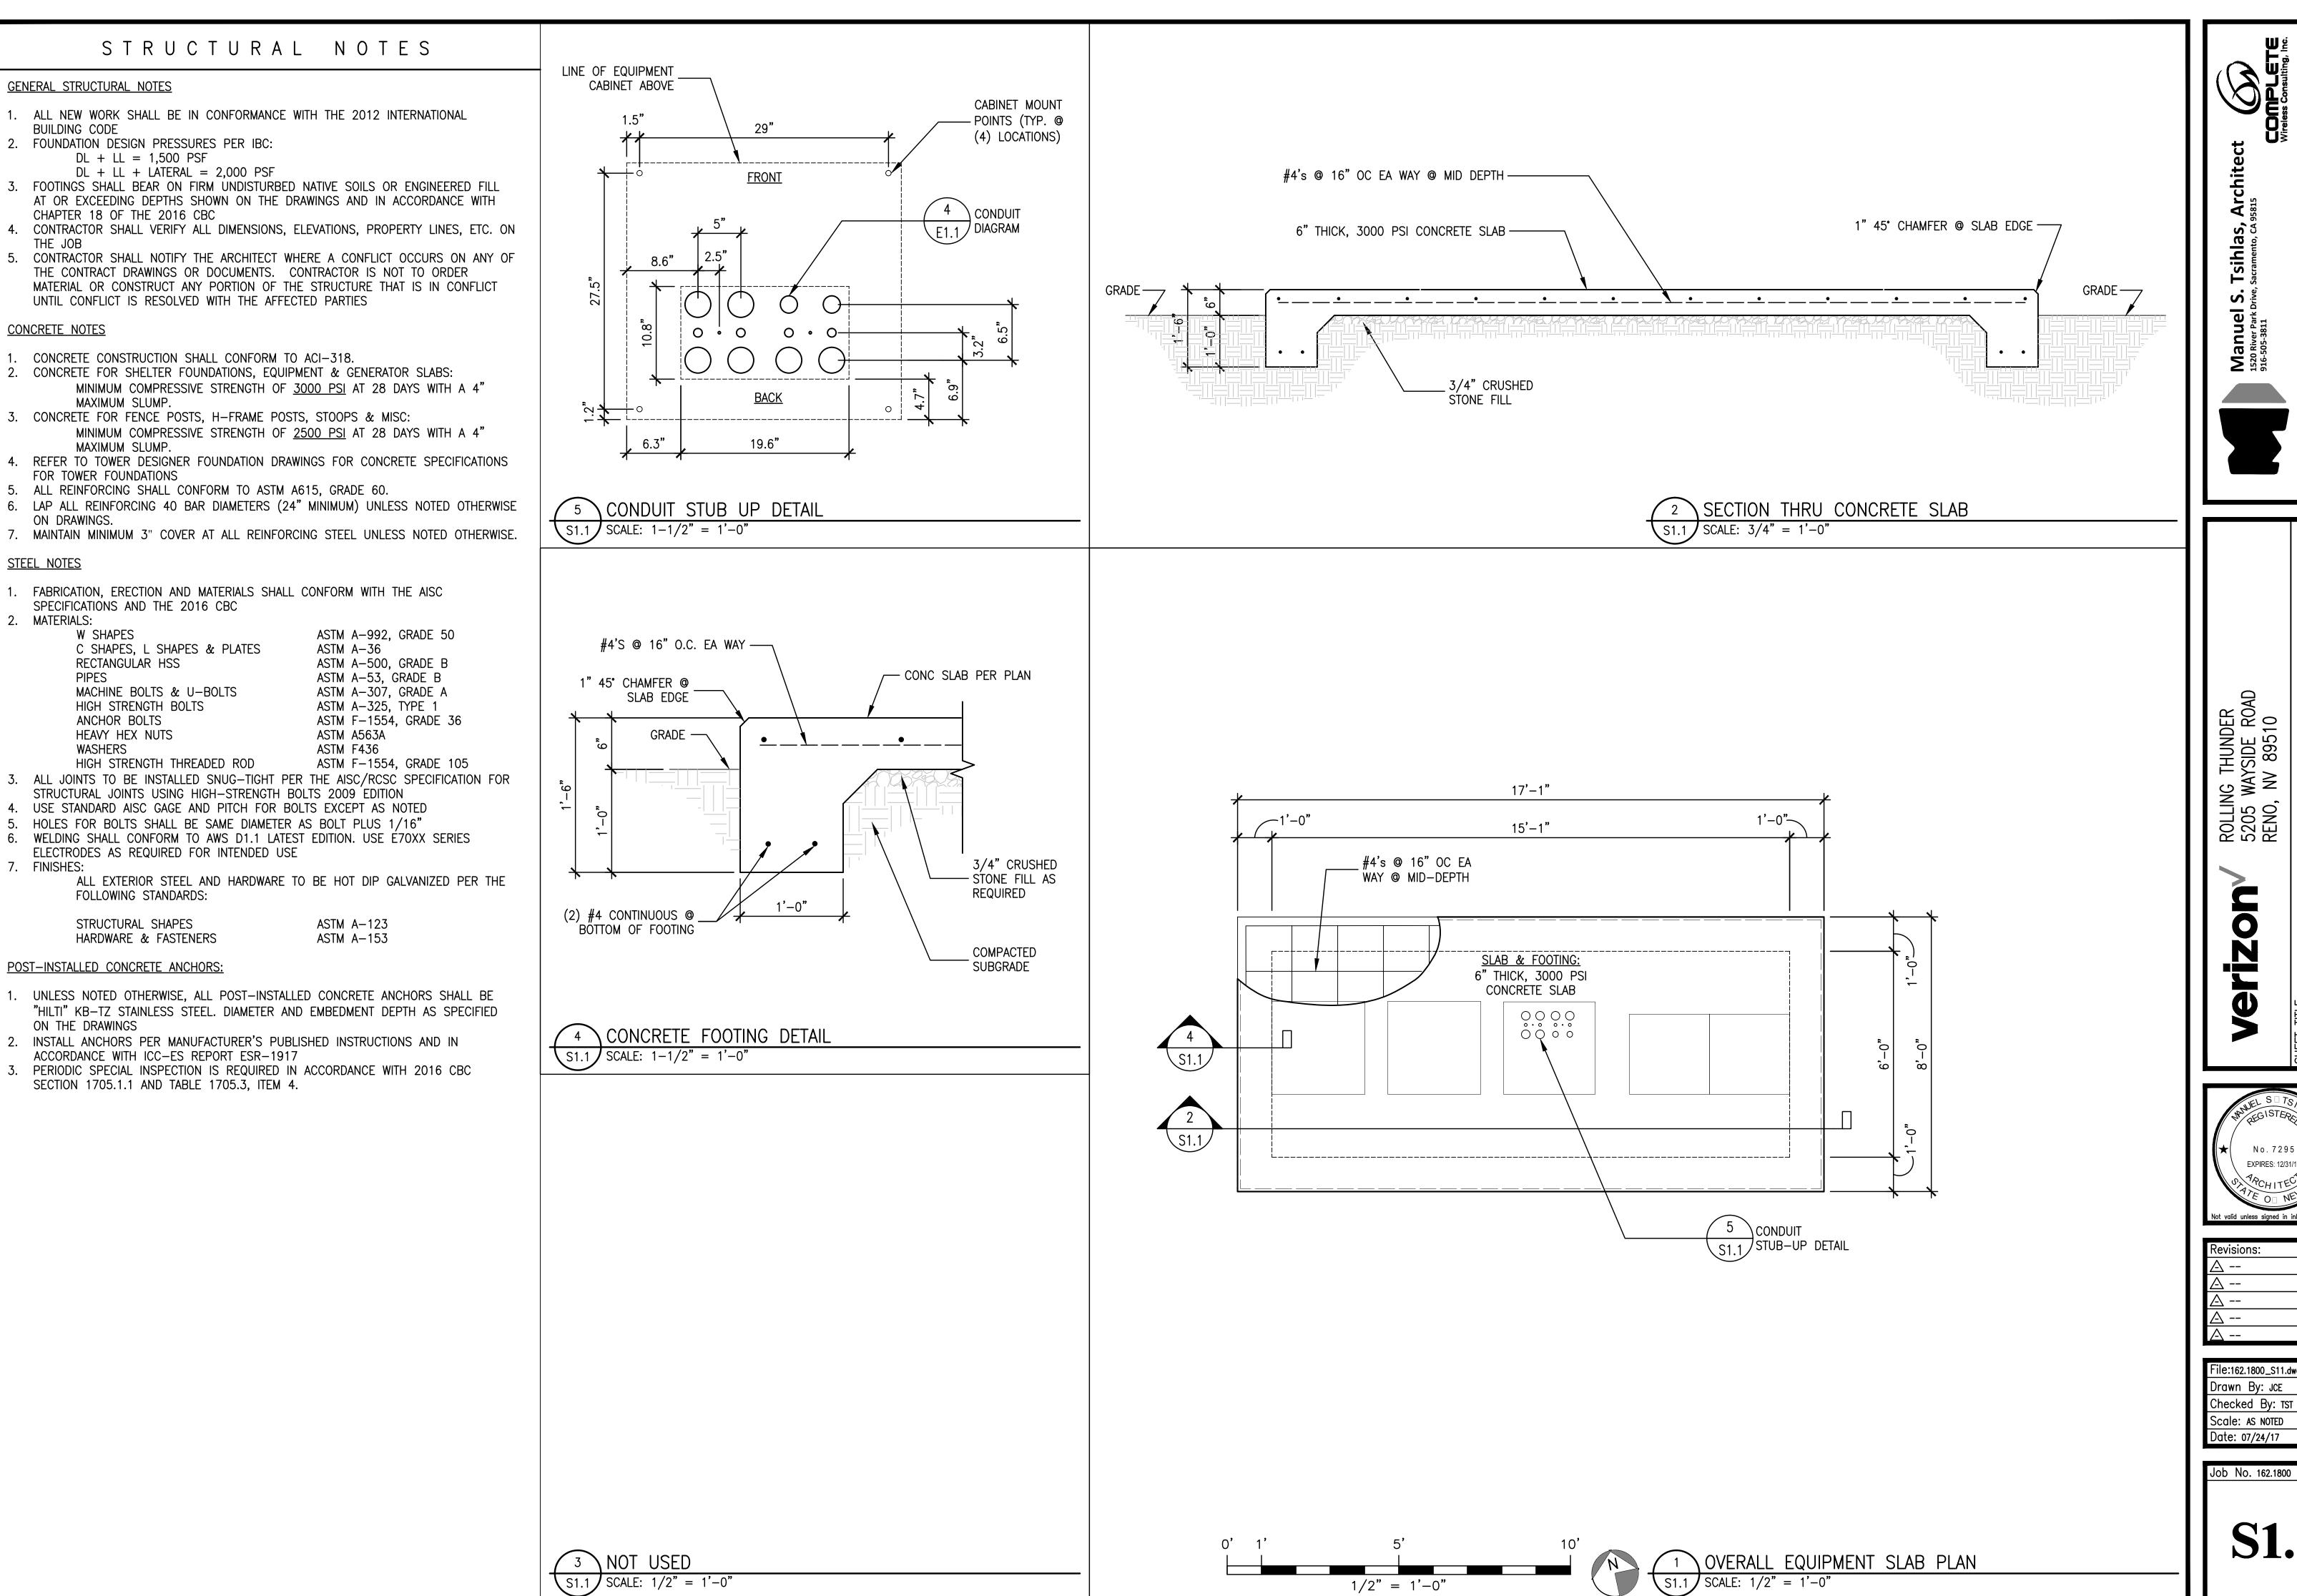

ROLLING THUNDER 5205 WAYSIDE ROAD RENO, NV 89510 **DETAILS**


STRU(verizon

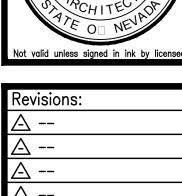

No.7295 EXPIRES: 12/31/17

File:162.1800_S11.dwg Drawn By: JCE Checked By: TST Scale: AS NOTED Date: 07/24/17

S1.1

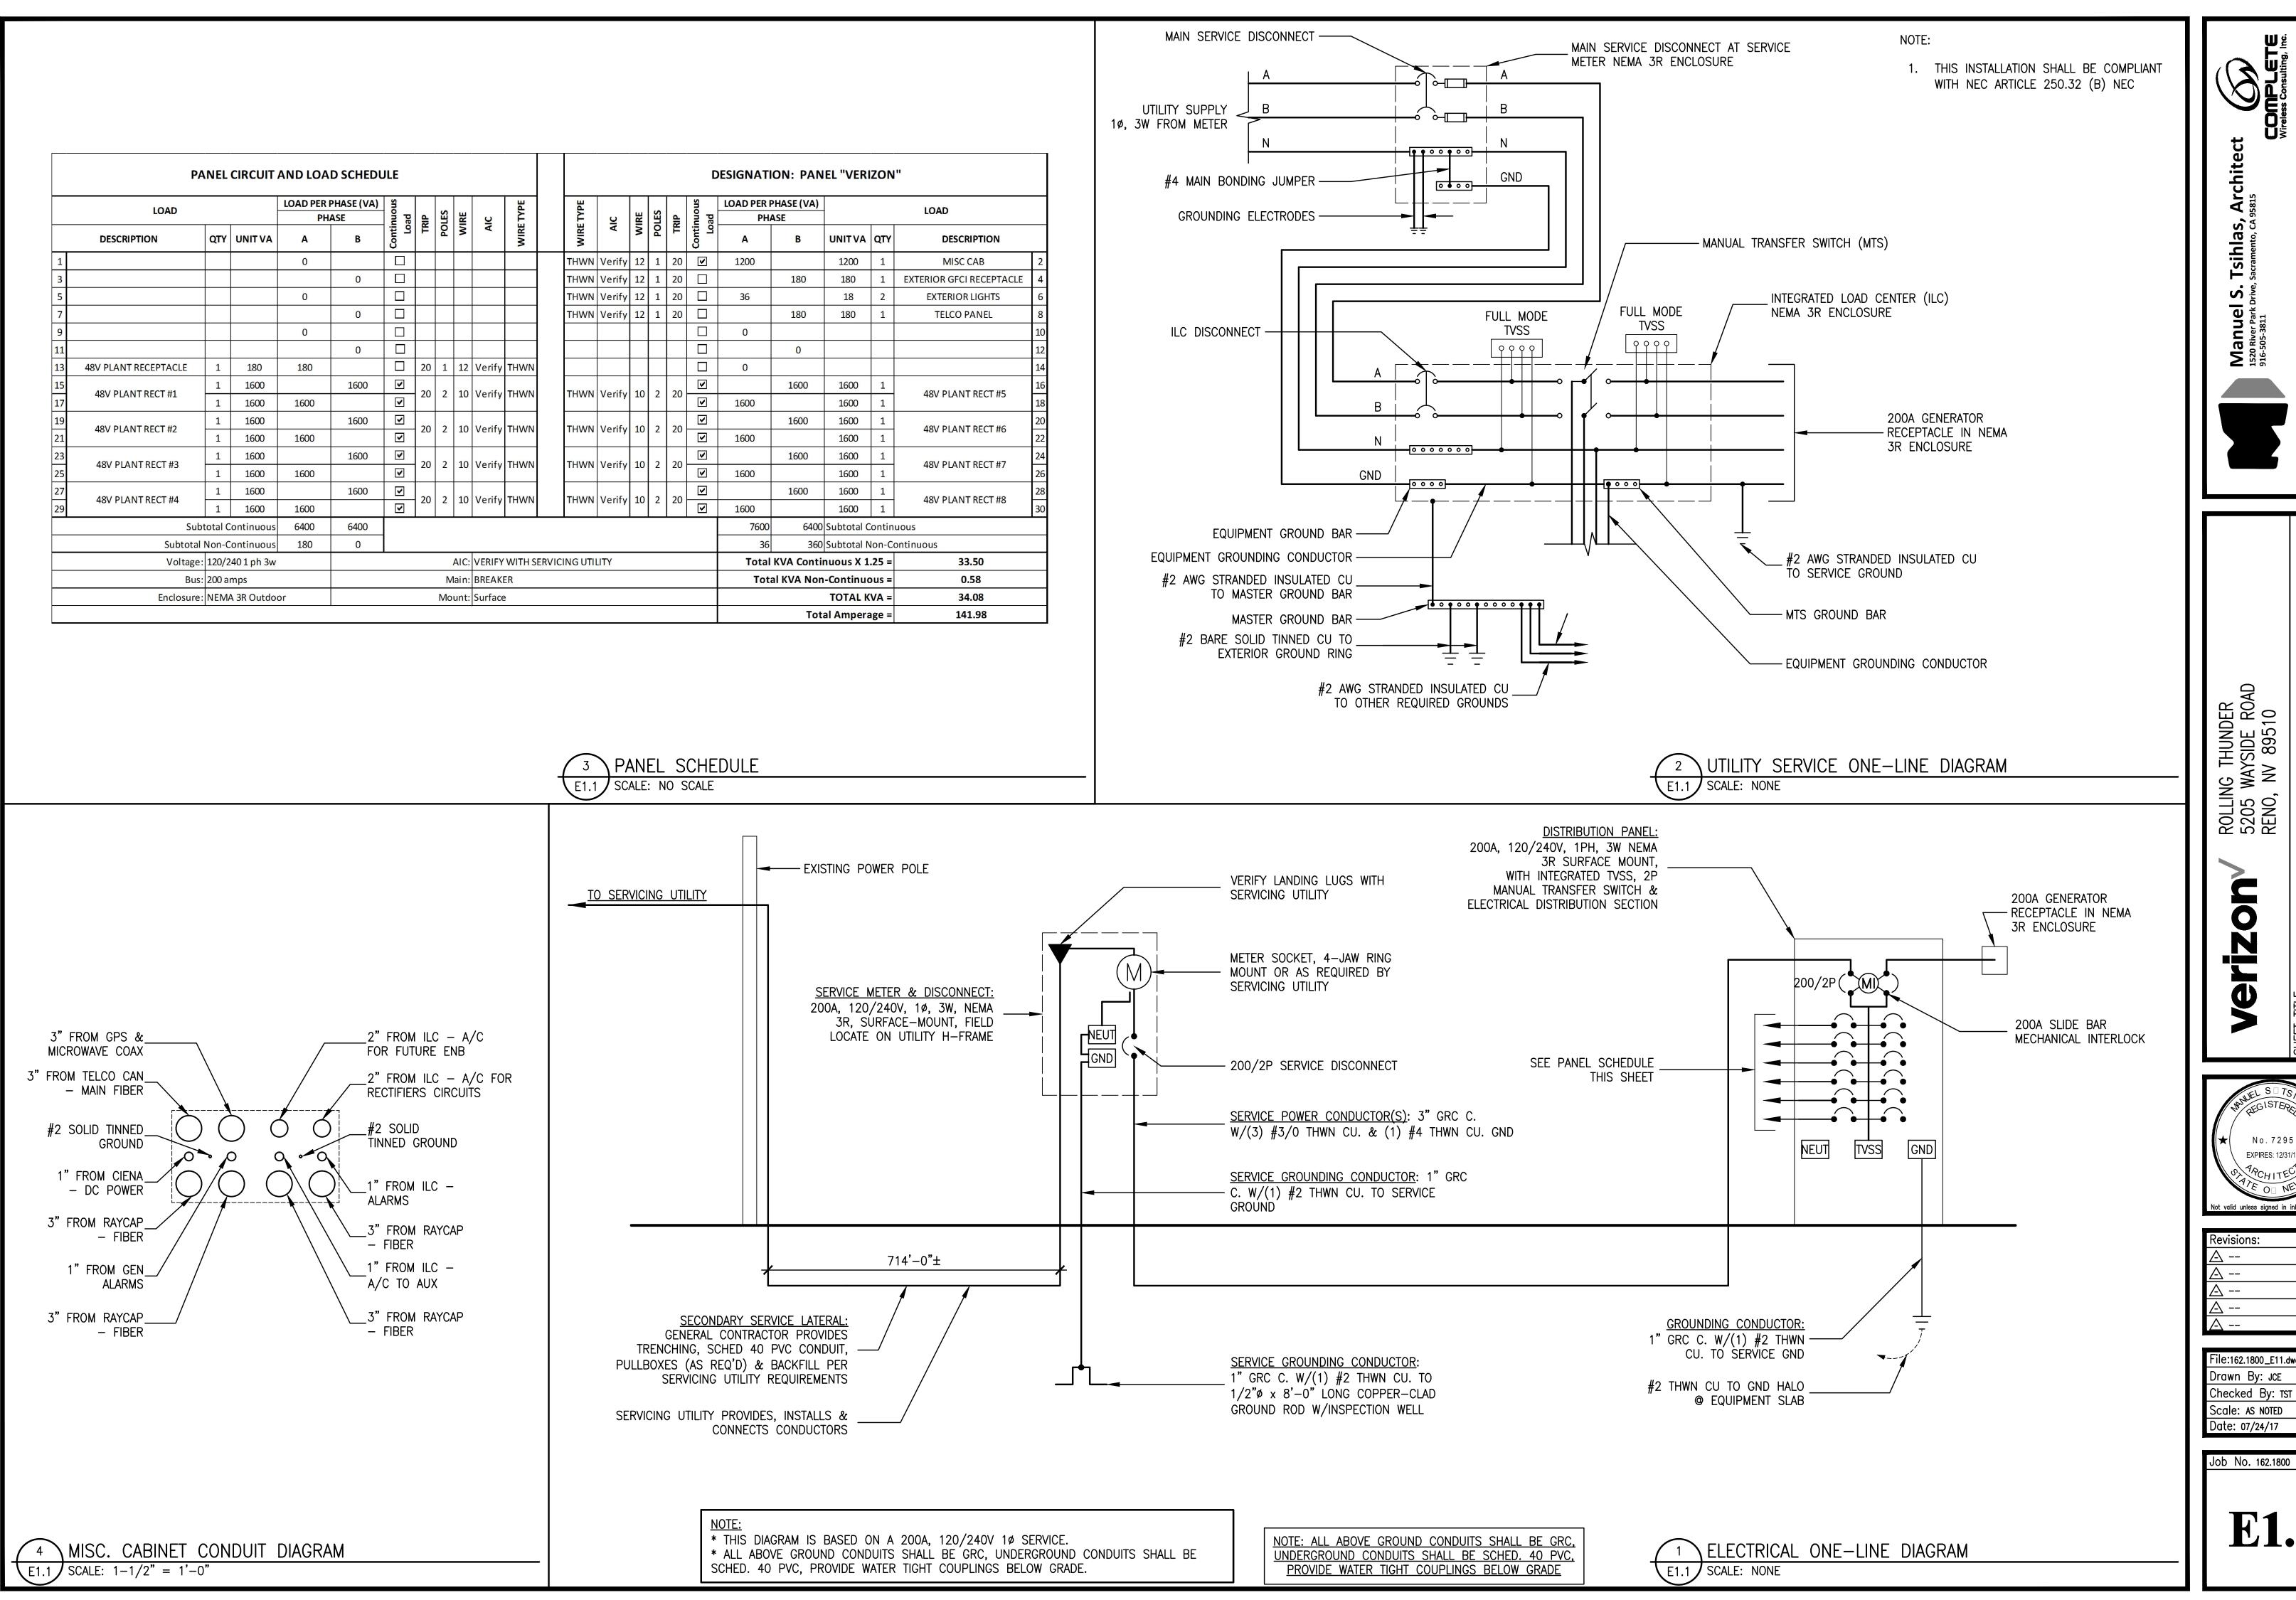

instruments of Sernoe, are and Shall Remain the property of Wanuel S. These Dramings and Specifications Shall not be used by any person or Manuel S. Tsihlas, architect all Rights reserved.

DETAILS


TRICAL

ELEC⁻



File:162.1800_E11.dwg Drawn By: JCE Checked By: TST Scale: AS NOTED

E1.1

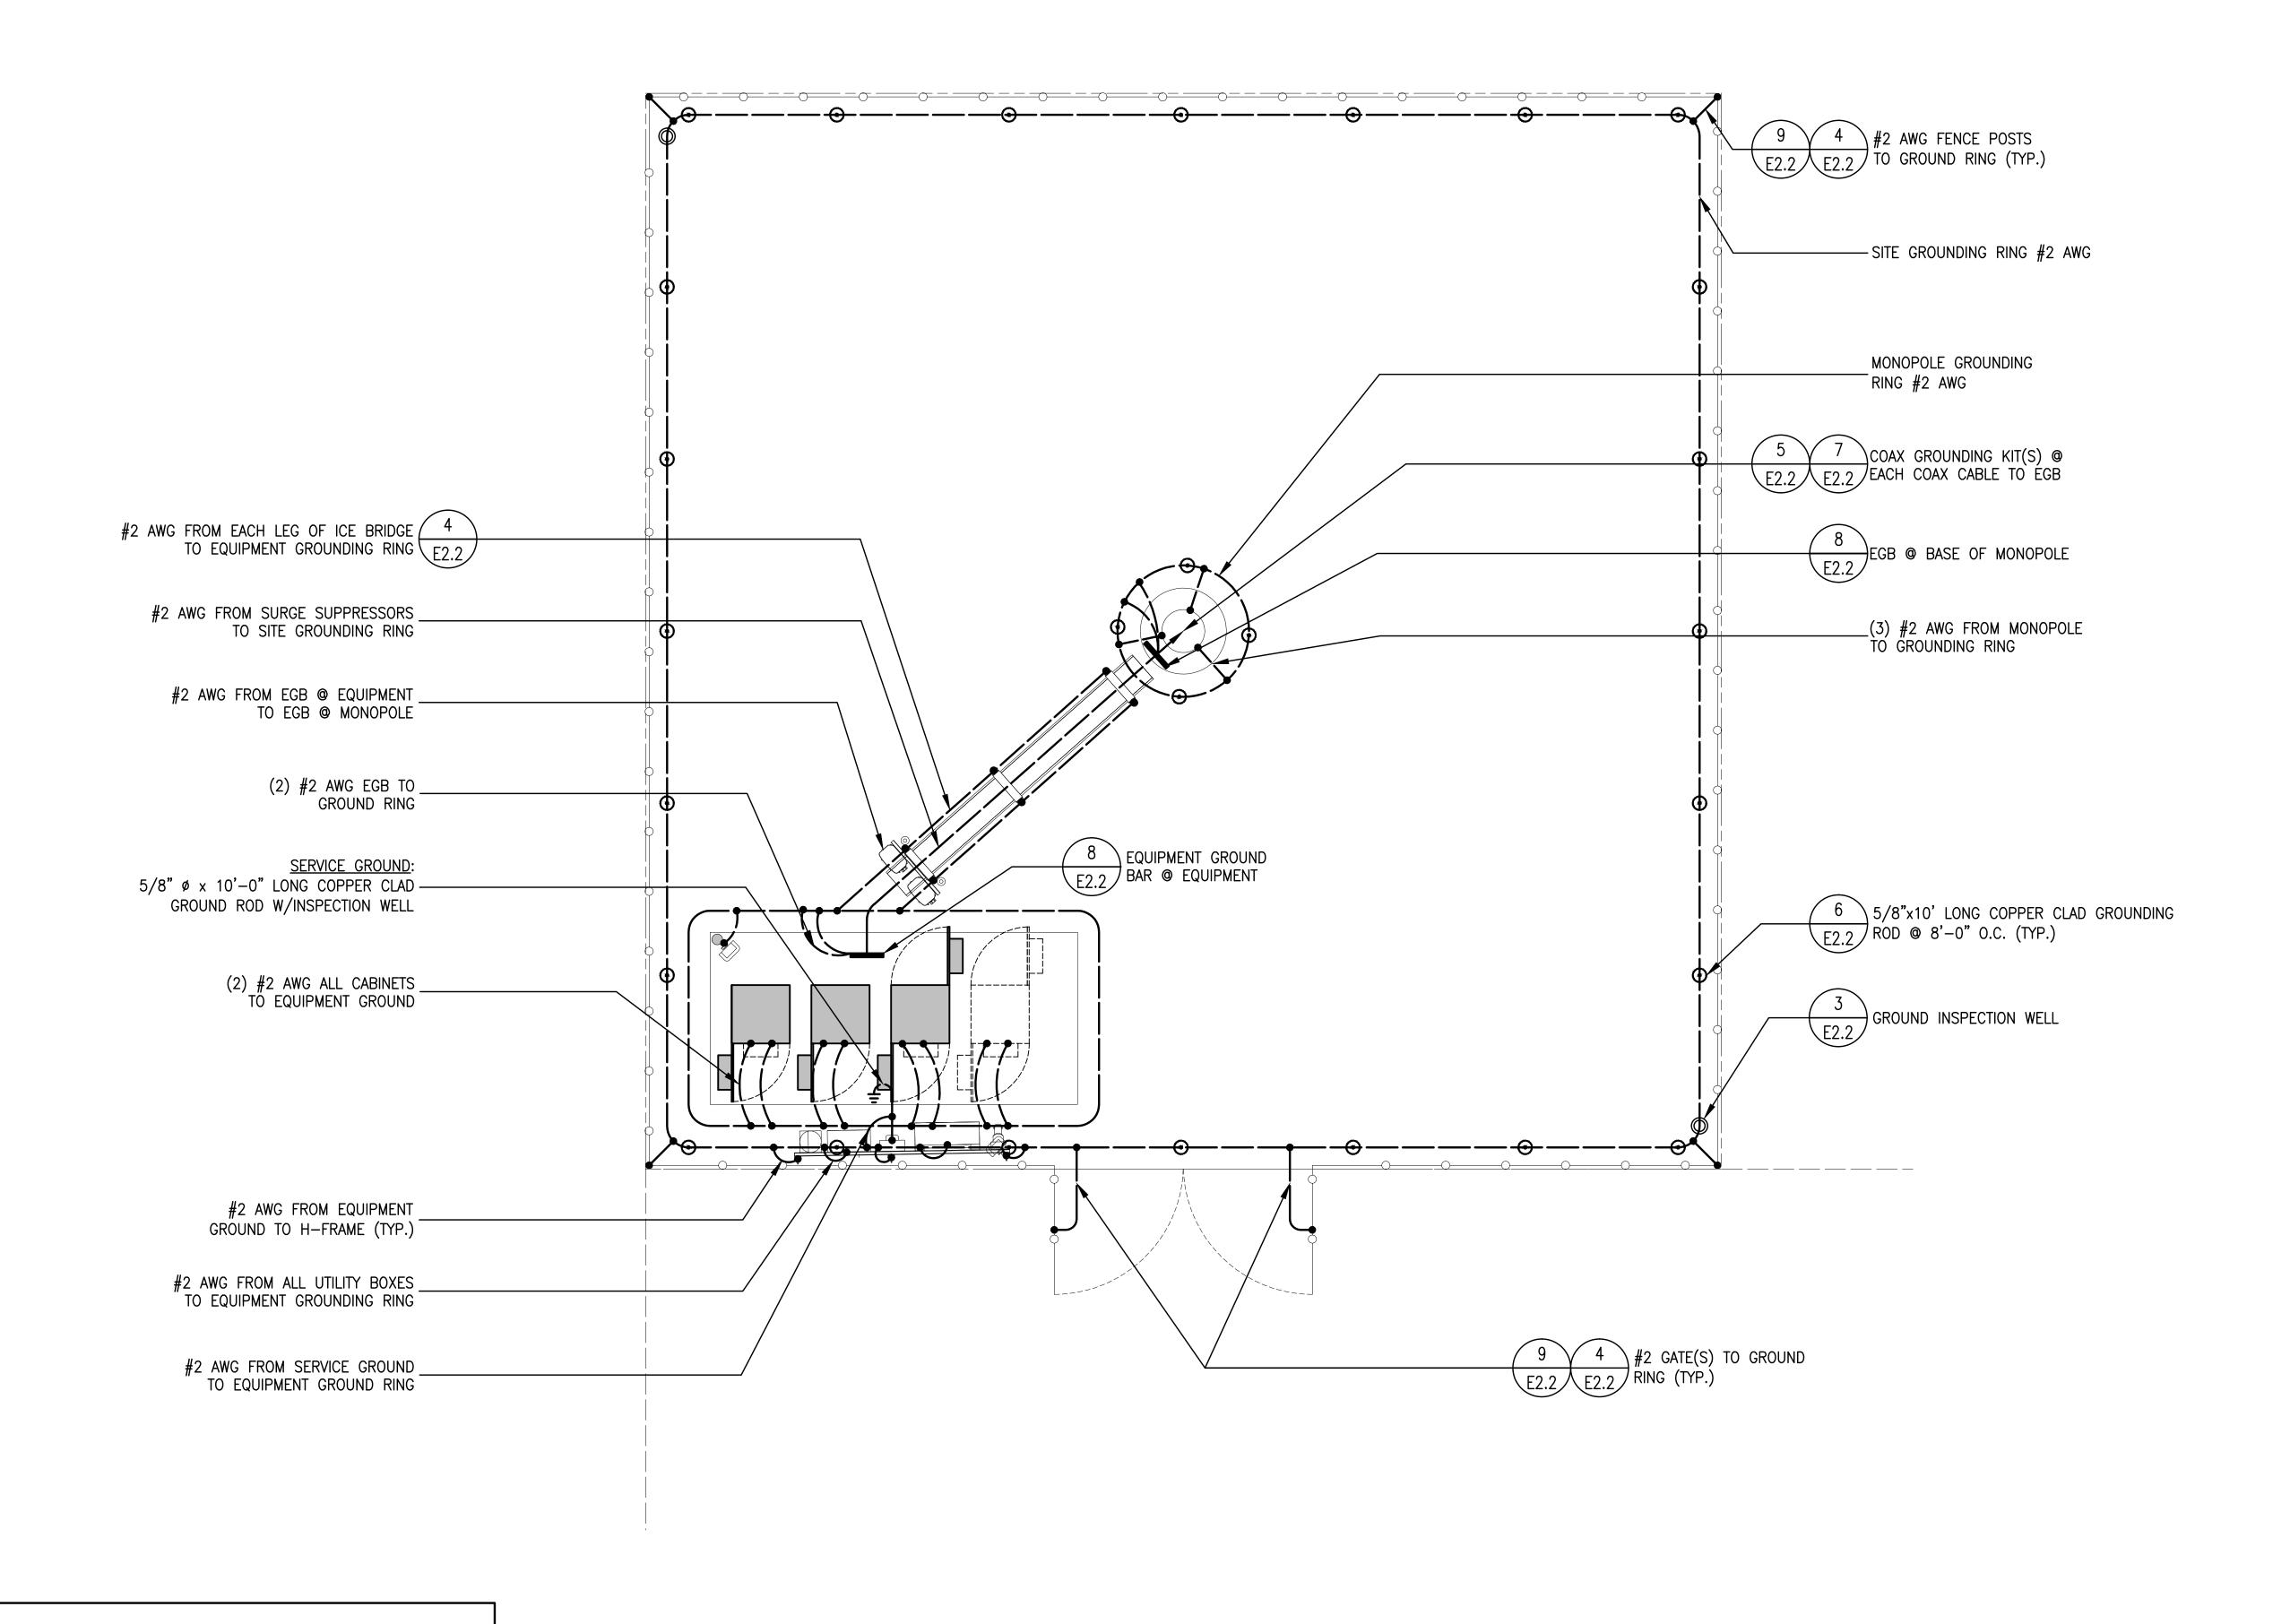

#1 NO CADWELDS TO ANY GROUND BARS

#2 RUN 2/0 GREEN INSULATED GROUND FROM THE COAX GROUND BAR TO THE MASTER GROUND BAR #3 CONNECT LEAD 20 FROM THE GROUND BAR INSIDE THE ILC PANEL TO THE MASTER GROUND BAR

#6 PLASTIC TY-RAPS ARE NOT TO BE USED ON ANY GROUND ATTACHMENTS BUT ONLY WAX STRING

#5 GROUND ALL METAL ENCLOSURES TO THE HALO, INCLUDING LOUVERS, ALARM BLOCK, ETC.

#4 BE SURE NEUTRAL & GROUND ARE NOT BONDED IN THE GENERATOR

Manuel S. Tsihlas, Architect
1520 River Park Drive, Sacramento, CA 95815
916-505-3811
CO
Wirele

5205 WAYSIDE ROAL RENO, NV 89510

GROUNDING

verizon

No. 7295
EXPIRES: 12/31/17

APCHITECTOR


Not valid unless signed in ink by licensee.

File:162.1800_E21.dwg
Drawn By: JCE
Checked By: TST
Scale: AS NOTED
Date: 07/24/17

Job No. 162.1800

GROUNDING PLAN
E2.1 SCALE: 1/4" = 1'-0"

E2.1

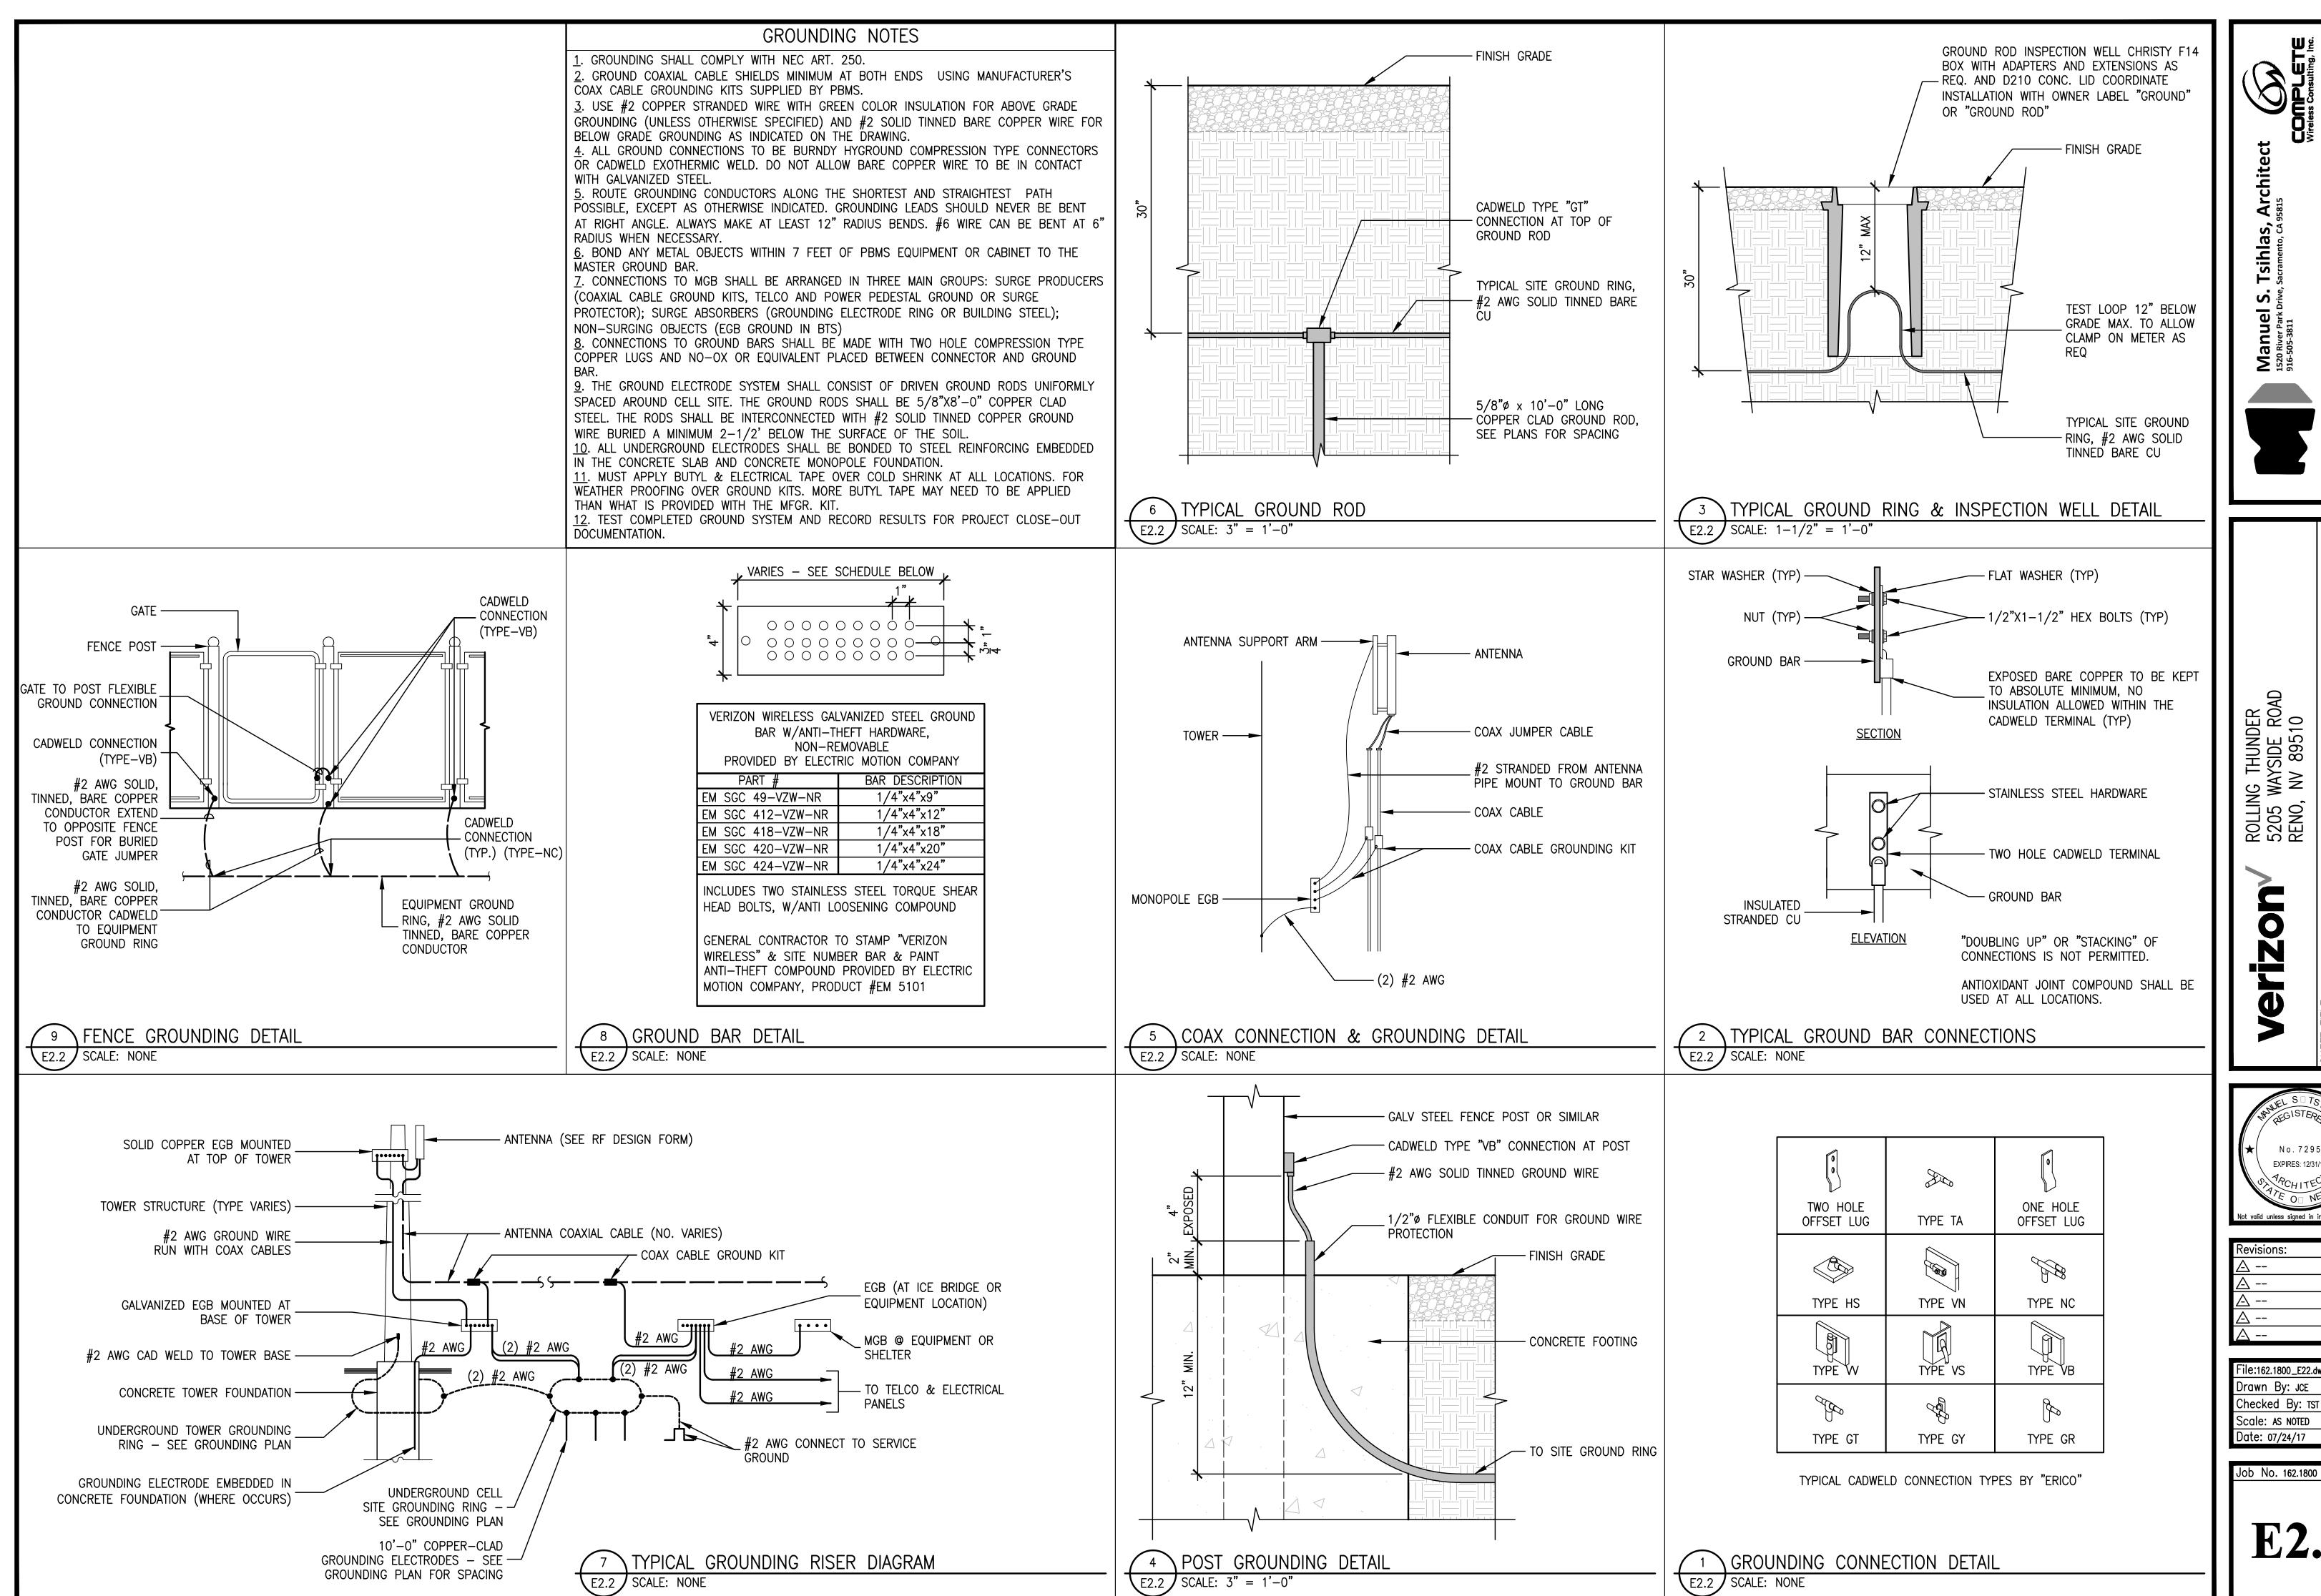

INSTRUMENTS OF SERVICE, ARE AND SHALL REMAIN THE PROPERTY OF MANUE. THESE DRAWINGS AND SPECIFICATIONS SHALL NOT BE USED BY ANY PERSON MANUEL S. TSHLAS, ARCHITECT ALL RIGHTS RESERVED.

ROLLII 5205 RENO,

DETAIL!

INDING

GROU

No.7295 EXPIRES: 12/31/17

Not valid unless signed in ink by licensed

File:162.1800_E22.dwg Drawn By: JCE Checked By: TST Scale: AS NOTED Date: 07/24/17

E2.2

GENERAL CONSTRUCTION NOTES:

- 1. ALL GRADING SHALL CONFORM TO WASHOE COUNTY GRADING STANDARDS CODE SECTION
- 2. FOR SITE PREPARATION, SUITABLE FILL MATERIAL, GRADING AND EARTHWORK ACTIVITIES, FOUNDATION SETBACKS AND OTHER GEOTECHNICAL RECOMMENDATIONS, REFER TO GEOTECHNICAL INVESTIGATION REPORT PREPARED BY MID PACIFIC ENGINEERING, INC., TITLED ROLLING THUNDER, LOCATION 382432 DATED MAY 12, 2017. CONTACT TODD KAMISKY, PE AT 916-927-7000.
- 3. SURFACES RECEIVING FILL TO BE SCARIFIED TO A DEPTH OF EIGHT INCHES, UNIFORMLY MOISTURE CONDITIONED TO BETWEEN O AND 5 PERCENT ABOVE OPTIMUM MOISTURE CONTENT, AND COMPACTED TO AT LEAST 90 PERCENT RELATIVE COMPACTION PER ASTM D1557. SUBGRADE AREAS TO BE SURFACED WITH GRAVEL TO BE UNIFORMLY MOISTURE CONDITIONED BETWEEN 1 AND 3 PERCENT ABOVE OPTIMUM MOISTURE CONTENT, AND COMPACTED TO AT LEAST 95 PERCENT RELATIVE COMPACTION. IN THE EVENT THE EXPOSED SUBGRADE CONSISTS OF UNDISTURBED ON-SITE ROCK, SCARIFICATION AND COMPACTION MAY BE OMITTED IF APPROVED BY THE PROJECT GEOTECHNICAL ENGINEER.
- 4. WITHIN AREAS GRUBBED OR OTHERWISE DISTURBED BELOW AN APPROXIMATE DEPTH OF 12 INCHES, IN-PLACE SCARIFICATION AND COMPACTION MAY NOT BE ADEQUATE TO DENSIFY ALL DISTURBED SOIL. THEREFORE, OVER-EXCATION OF THE DISTURBED SOIL, SCARIFICATION AND COMPACTION OF THE EXPOSED SUBGRADE, AND REPLACEMENT WITH ENGINEERED FILL MAY BE REQUIRED IN THESE AREAS.
- 5. IF GRADING IS PERFORMED DURING RAINY SEASON (WINTER OR SPRING MONTHS) OR AFTER SIGNIFICANT PRECIPITATION OR IRRIGATION, AND OVER-OPTIMUM SOIL CONDITIONS ARE ENCOUNTERED, THE PROJECT GEOTECHNICAL ENGINEER IS TO BE CONSULTED TO REVIEW CONDITIONS AND PROVIDE TREATMENT RECOMMENDATIONS.


EARTHWORK SUMMARY (CY)				
	CUT	FILL	NET (CUT-FILL)	
RAW SURFACE GRADING	2686.55	3170.01	-483.46	
SECTION GRADING AD	IUSTMENT	S		
LEASE AREA (3"GRAVEL)	22.95		22.95	
RIPRAP CHANNEL	41.21		41.21	
ACCESS ROUTE/TURNAROUND (6" AGG BASE)	413.64		413.64	
TOWER FOUNDATION (2' CONC FOOTING)	50.07		50.07	
TOTAL	3214.43	3170.01	44.42	


(CUT/EXPORT)


DISTURBED AREA = 1.46 ACRES

SURVEY NOTE:


SEE TOPOGRAPHIC SURVEY SHEETS C-1 AND C-2 FOR GEOGRAPHIC COORDINATES, BASIS OF BEARINGS, AND BENCHMARKS.

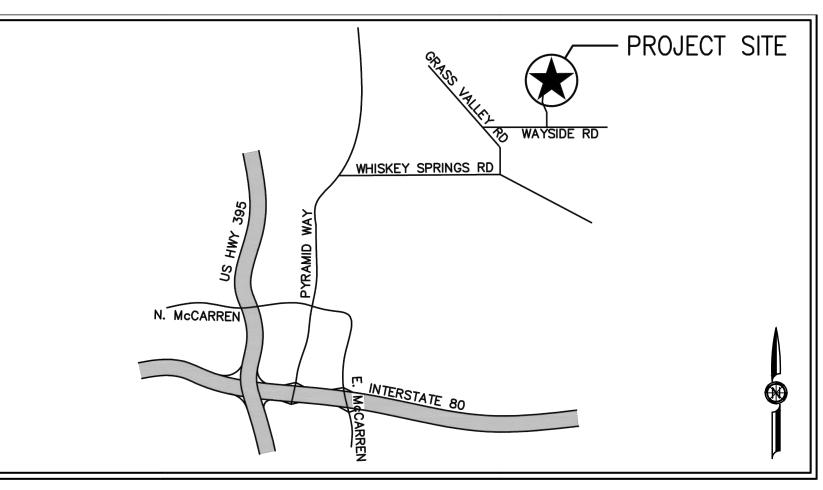


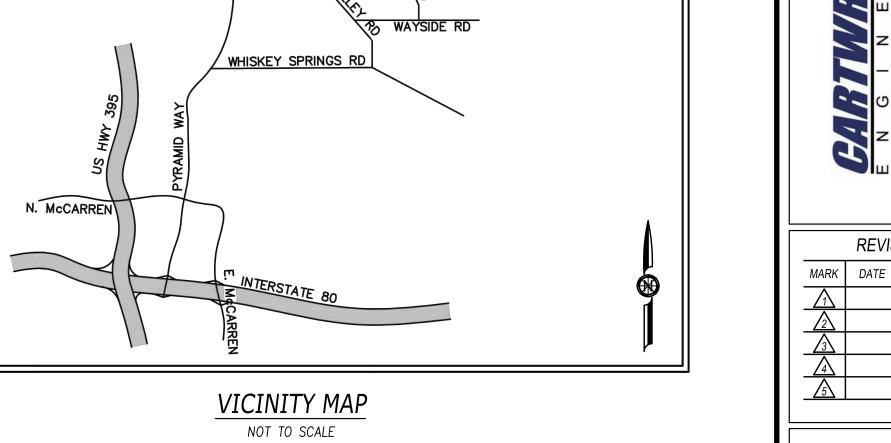

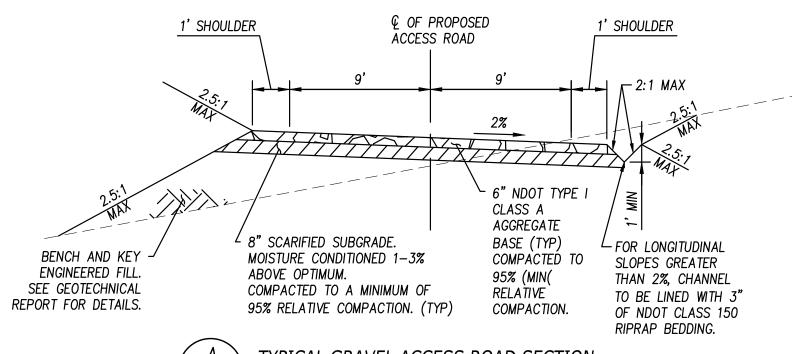

TYPICAL GRAVEL ACCESS ROAD SECTION C1.0 / STA 0+37.43 - 0+84.00 STA 1+36.49 - 6+85.00 STA 7+38.00 - 8+35.00 NOT TO SCALE

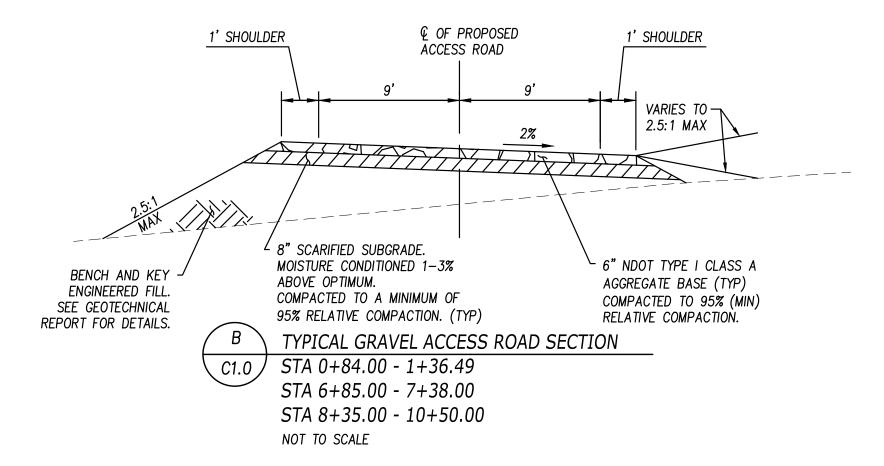


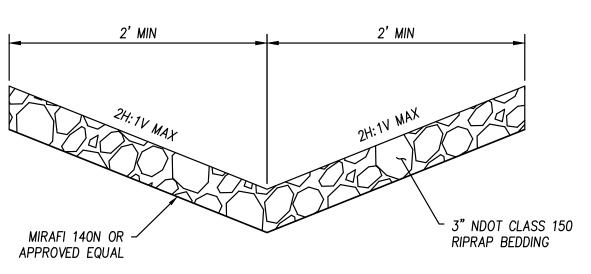

TYPICAL RIPRAP CHANNEL SECTION NOT TO SCALE

	S		
	œ	09	
2	ш	4180 Douglas Blvd, Suite 200 Granite Bay, California 95746 T (916) 978-4001 www.cartwrightengineers.com	
	ш	llvd, Su Ilifornië 78-40(engine	
	z	glas E ay, Ca 16) 9 vright	
	-) Doug ite Bi T (9	(
	ტ	418(Grar www	
	z		
9	ш		

REVISIONS MARK DATE DESCRIPTION A A A A A A					
MARK DATE DESCRIPTION A A A A A	REVISIONS				
<u>↑</u> <u>↑</u> <u>↑</u> <u>↑</u> <u>↑</u> <u>↑</u> <u>↑</u>	MARK	DATE	DESCRIPTION		
<u>↑</u>	Λ				
<u>\$</u>	2				
<u>\$</u>	<u>3</u>				
<u> </u>	<u>4</u>				
	<u> </u>				

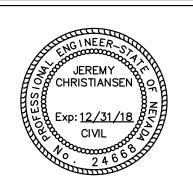

ROLLING THUNDER 5205 WAYSIDE ROAD RENO, NV 89510 APN: 077-350-01

PROJECT #: 217019


SCALE: NTS


07/21/2017 APPROVALS


DESIGNED BY: JDC DRAWN BY: CHECKED BY: JDC/SL


SHEET TITLE GENERAL NOTES AND ACCESS ROAD TYPICAL SECTIONS


SHEET NUMBER

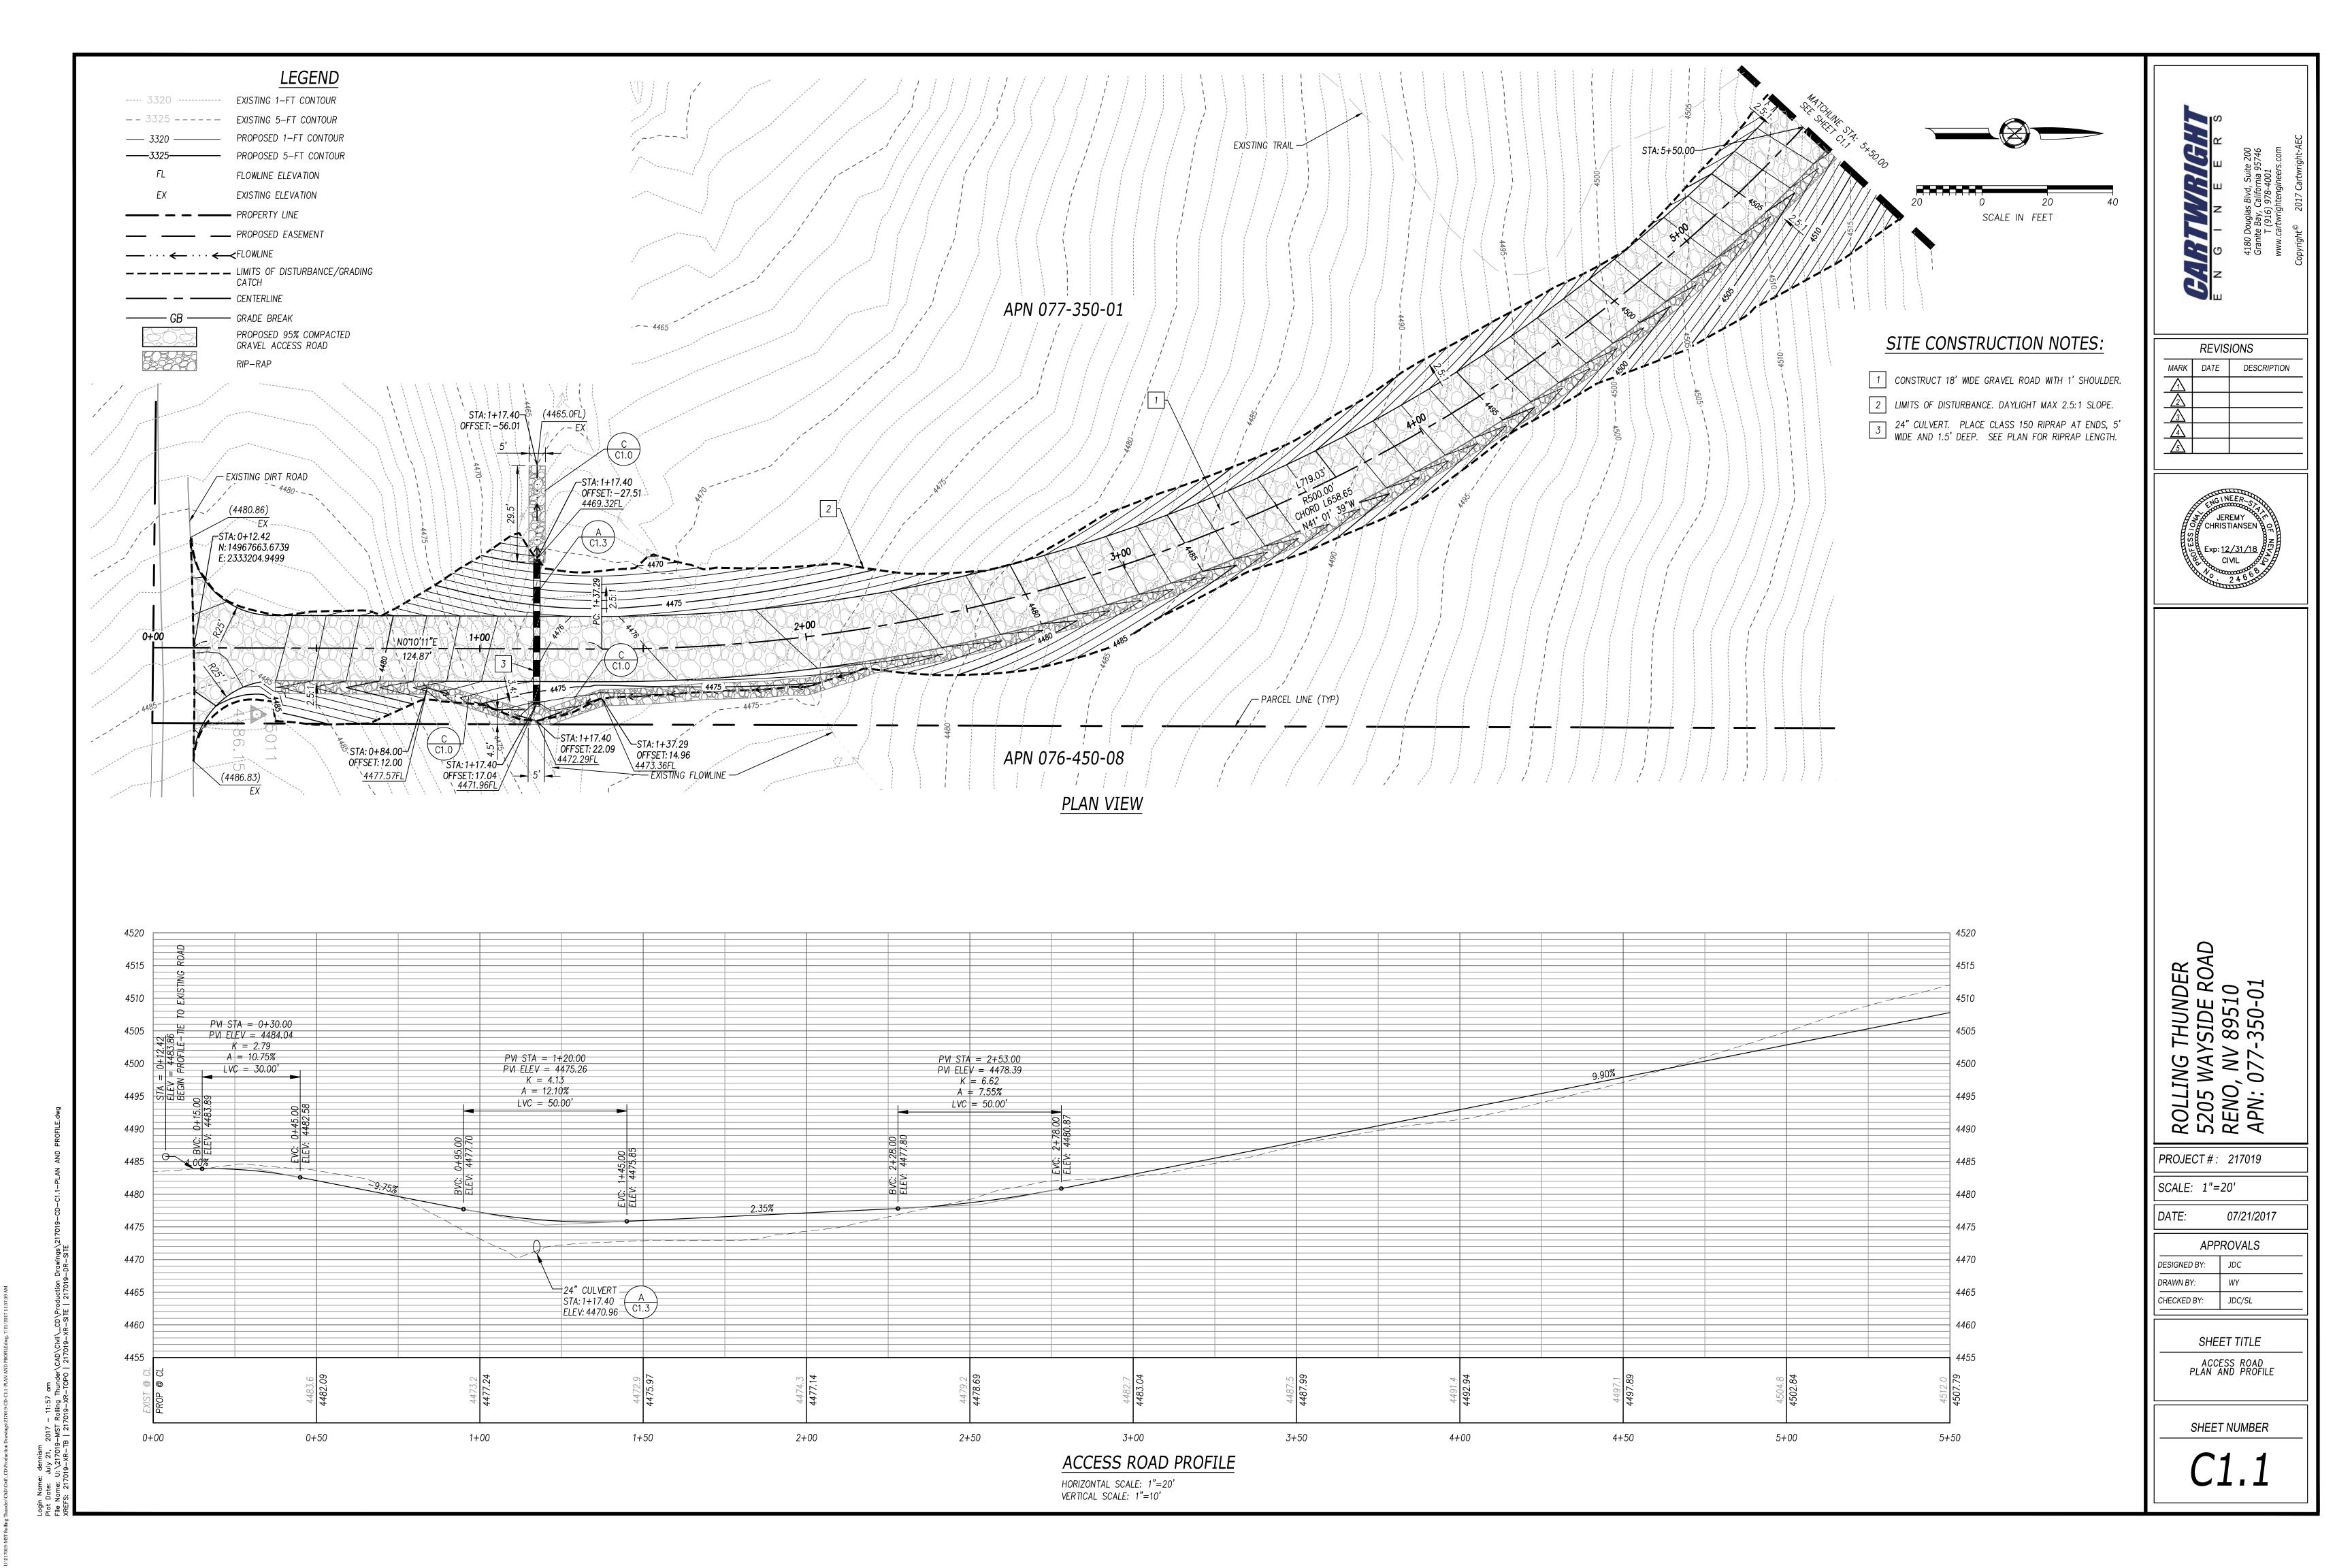


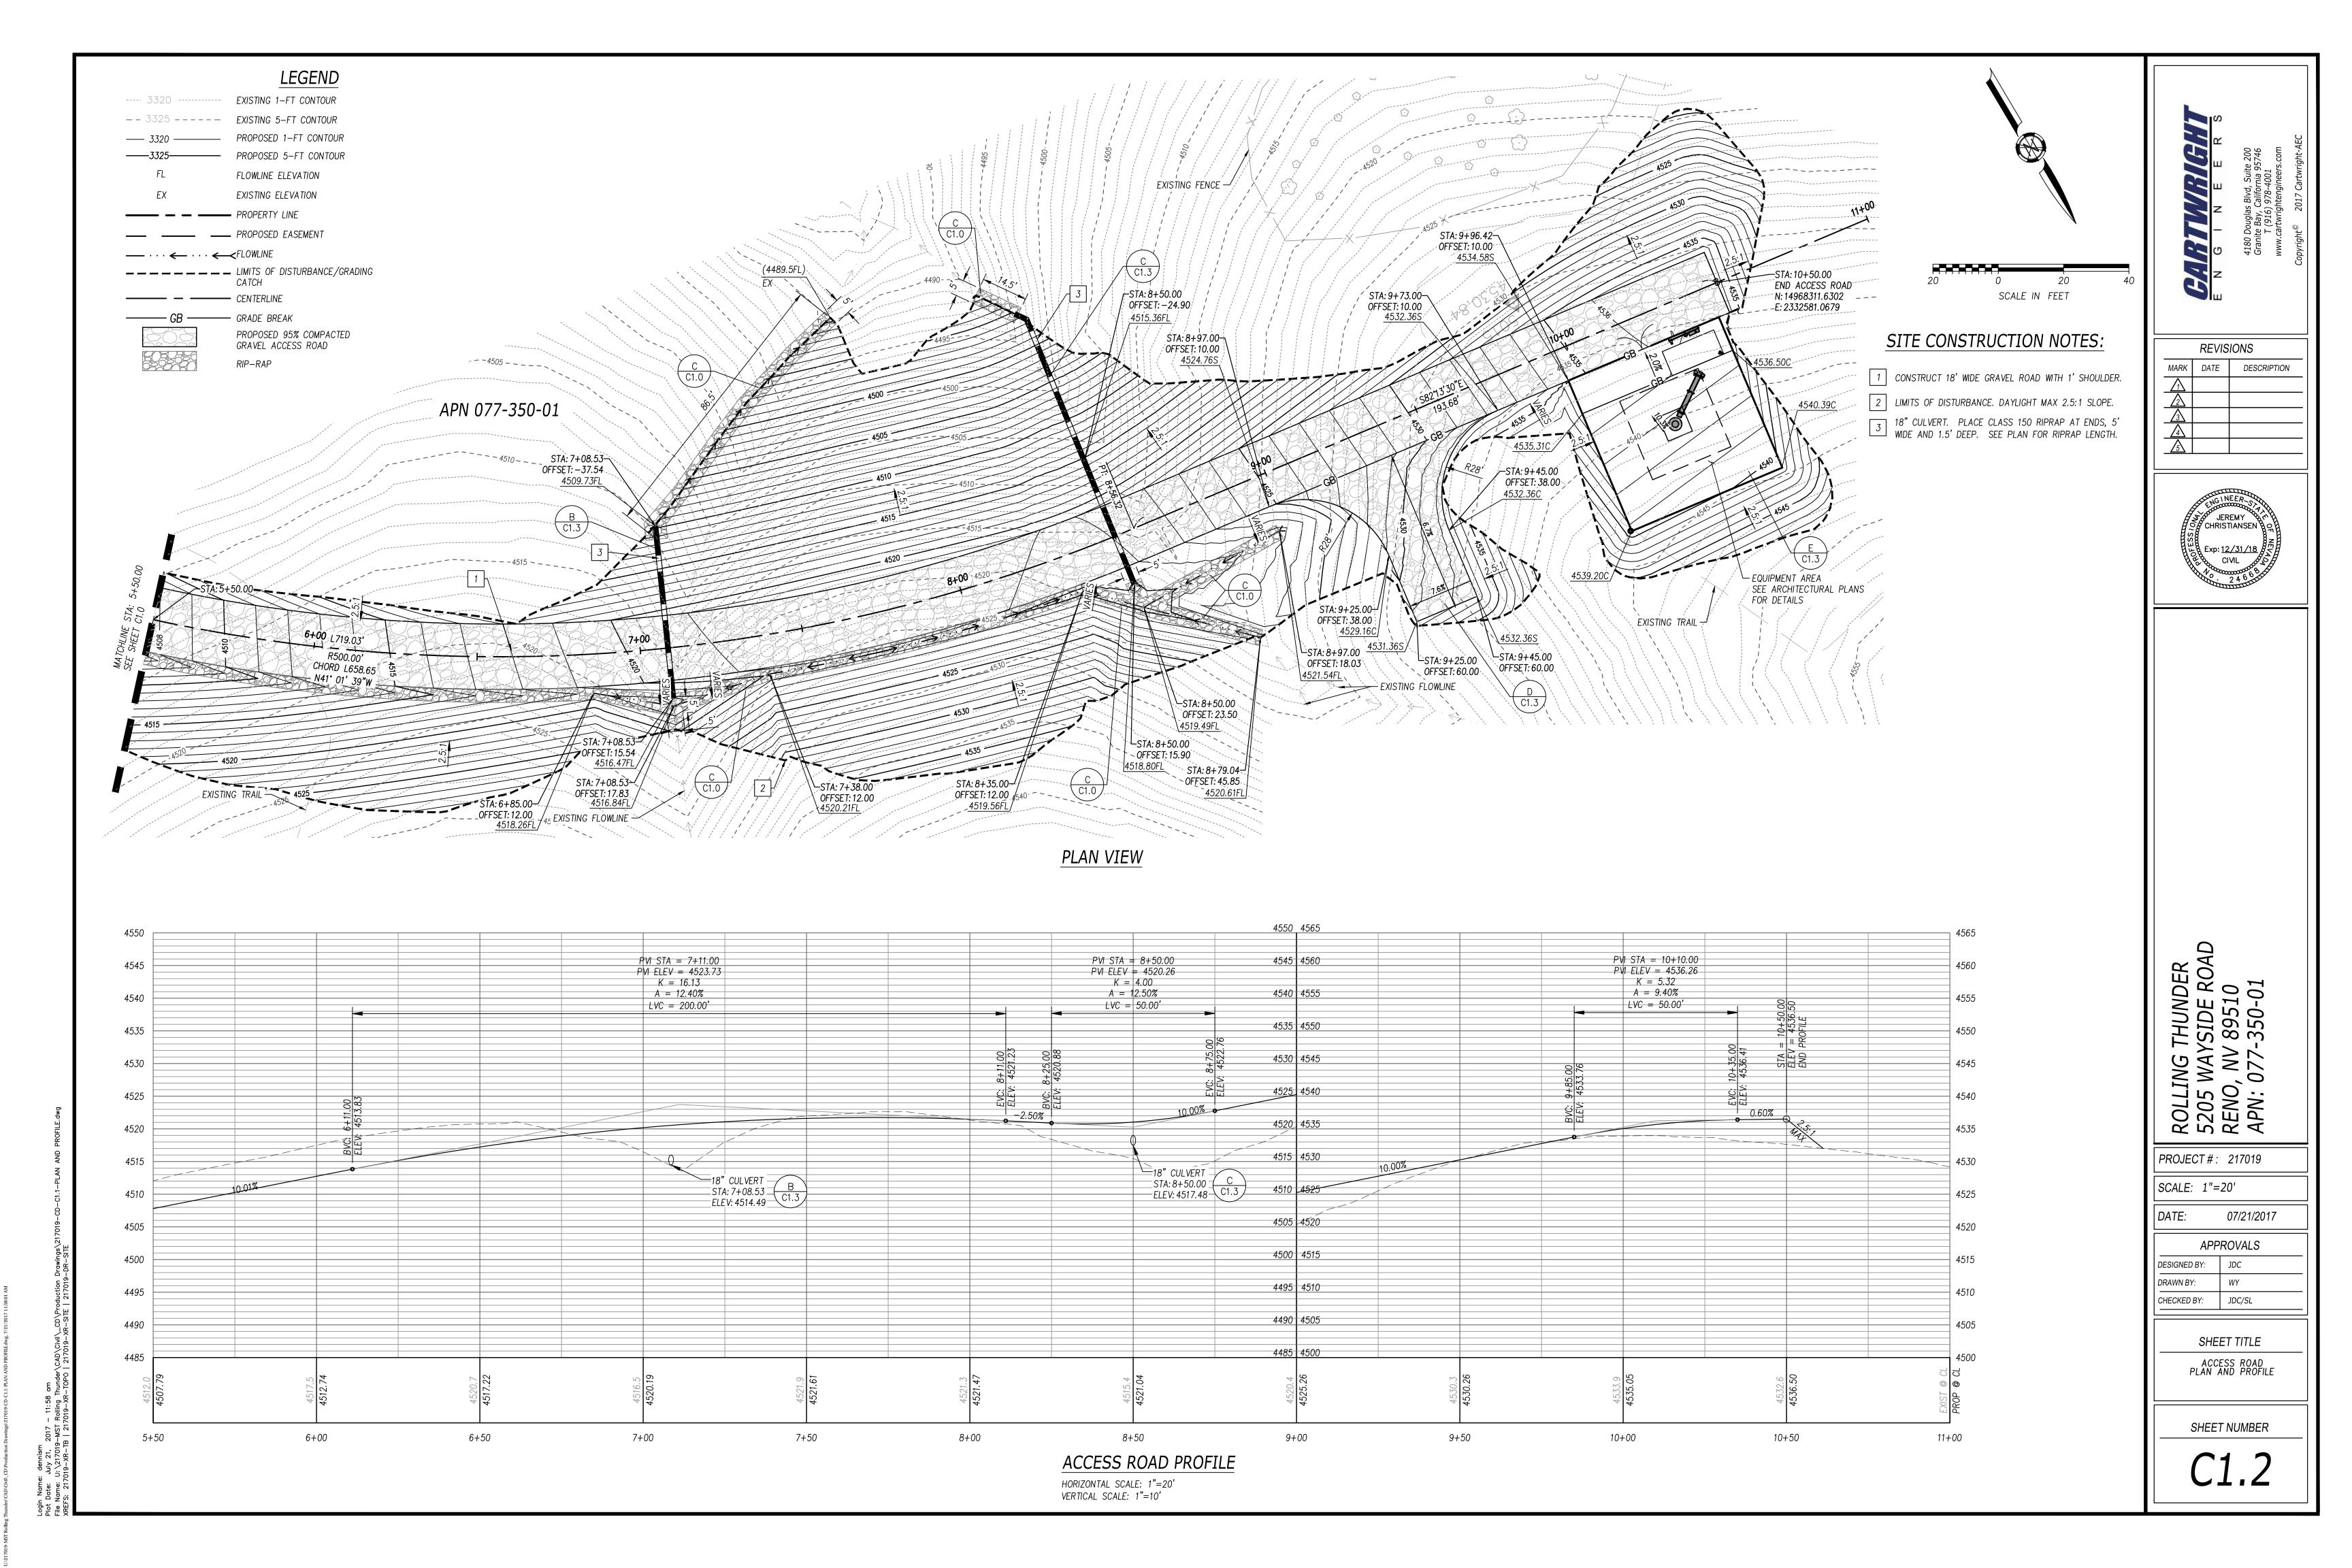


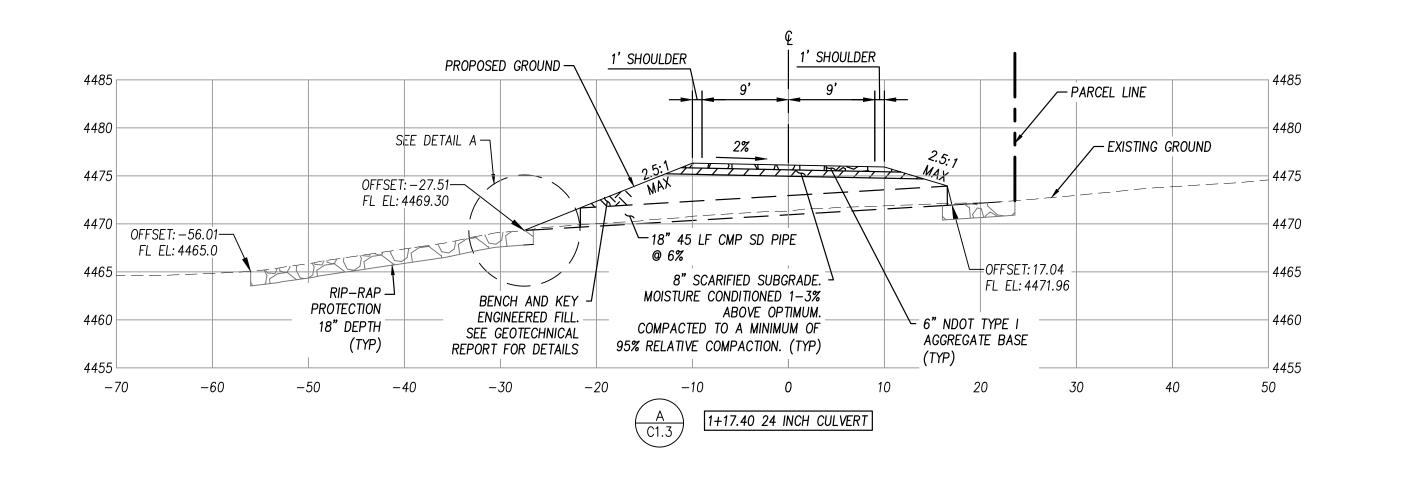


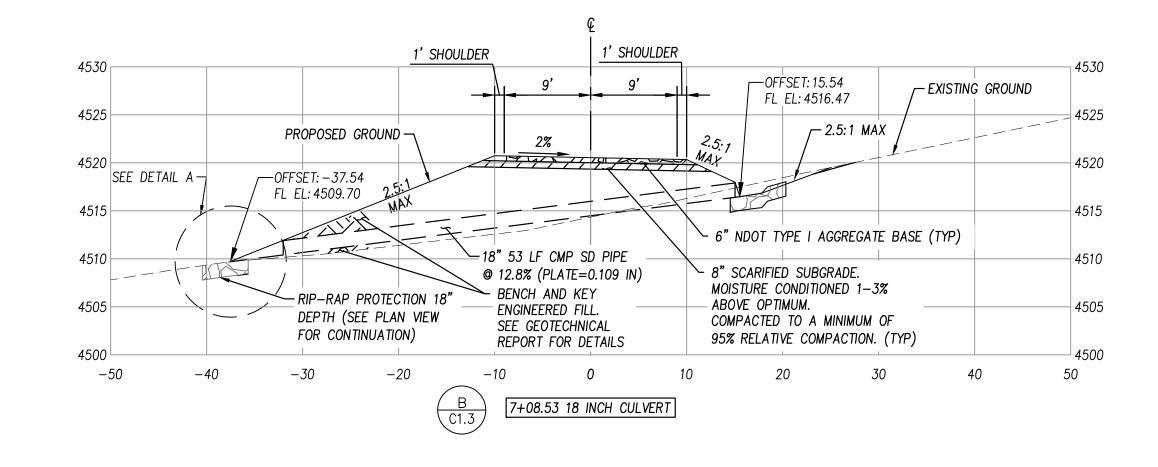

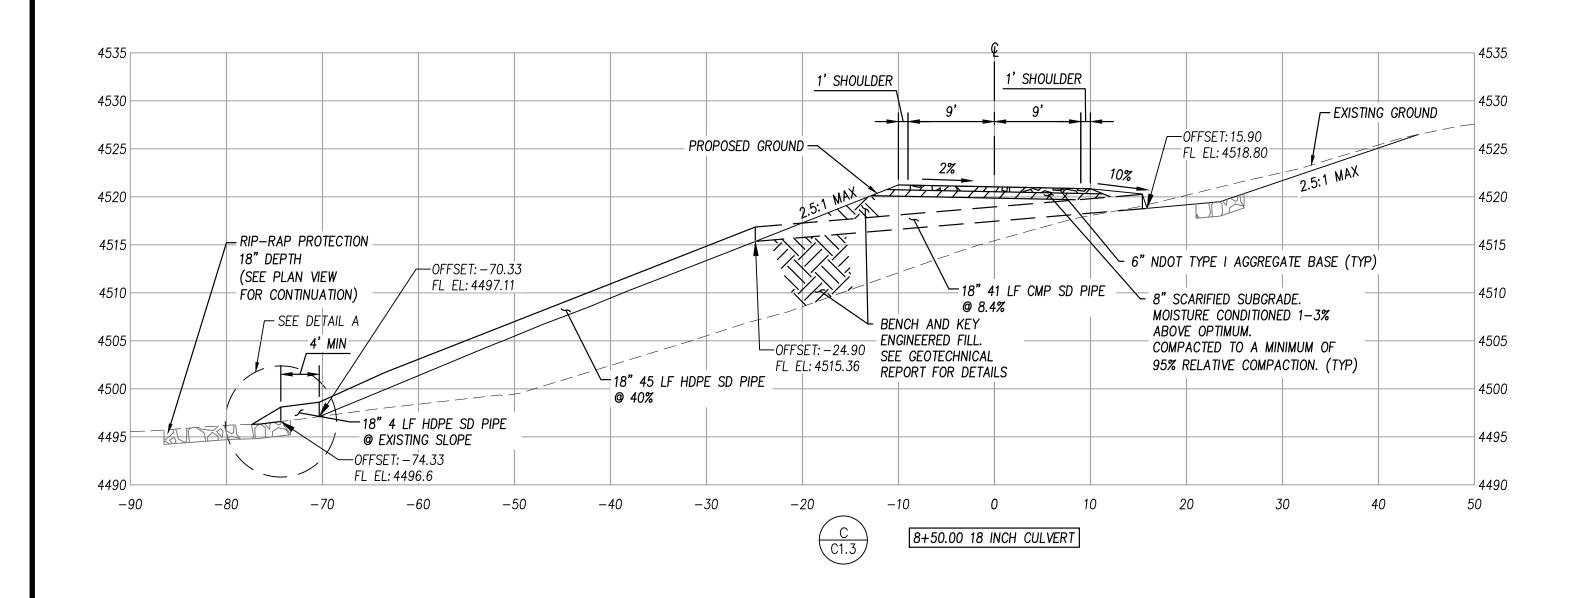

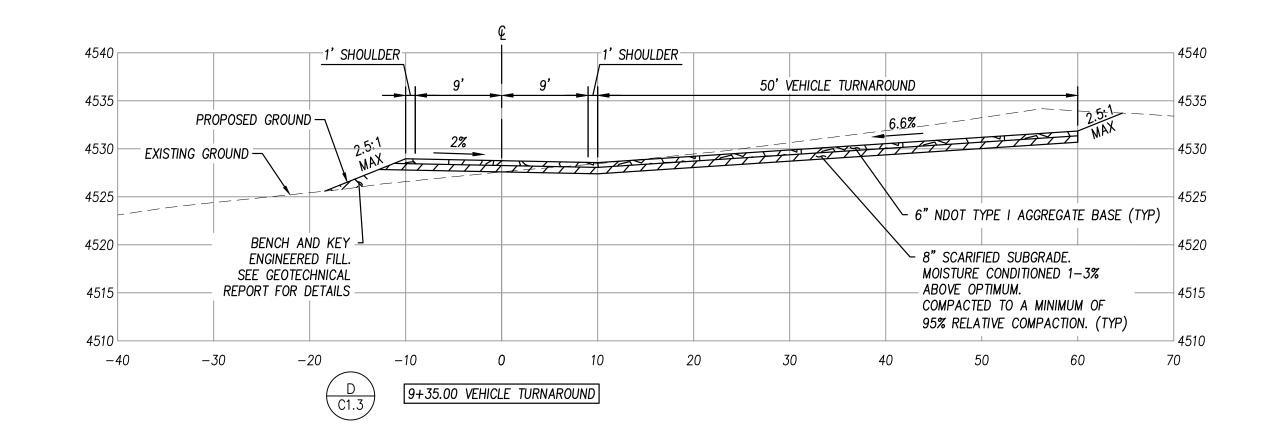

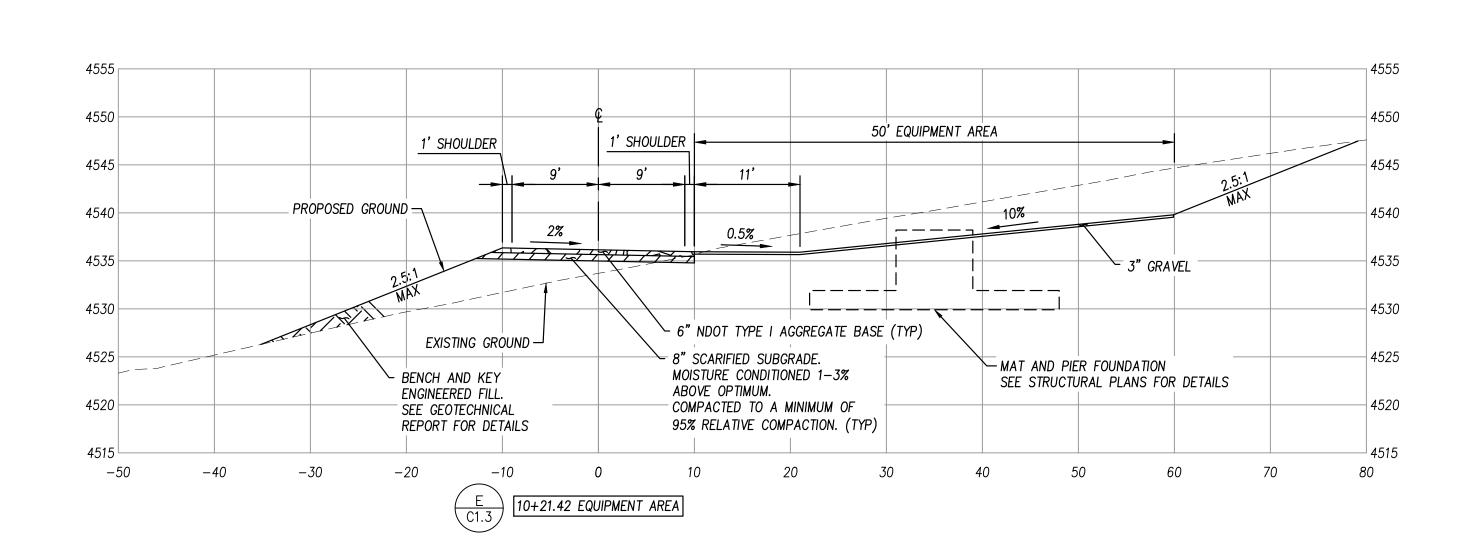

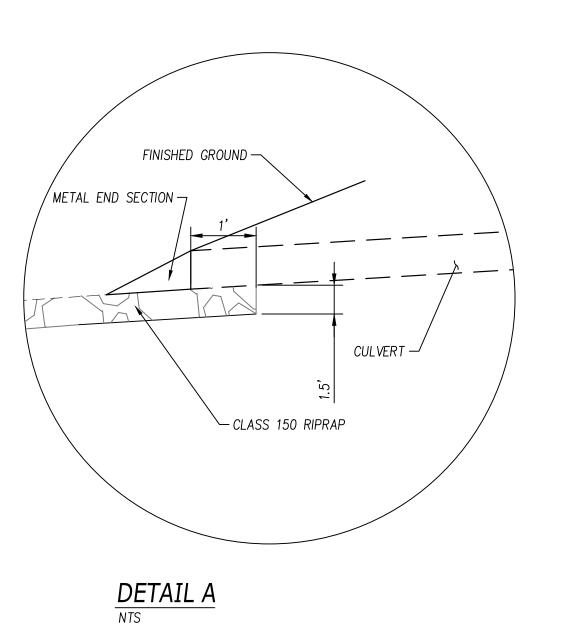


10 0 10 20 SCALE IN FEET

ENGINETIME EERS

4180 Douglas Blvd, Suite 200
Granite Bay, California 95746
T (916) 978-4001
www.cartwrightengineers.com

DE: //0/01/01			
REVISIONS			
MARK DATE DESCRIPTION			
\triangle			
<u>^</u>			
<u>3</u>			
<u> </u>			
<u>\$</u>			

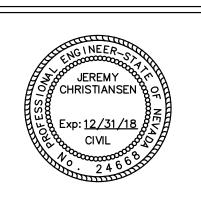

ROLLING THUNDER 5205 WAYSIDE ROAD RENO, NV 89510 APN: 077-350-01

PROJECT #: 217019

SCALE: 1"=10'

DATE: 07/21/2017

APPROVALS

APPROVALS

DESIGNED BY: JDC

DRAWN BY: WY


CHECKED BY: JDC/SL

SHEET TITLE

ACCESS ROAD
SECTIONS

SHEET NUMBER

C1.3

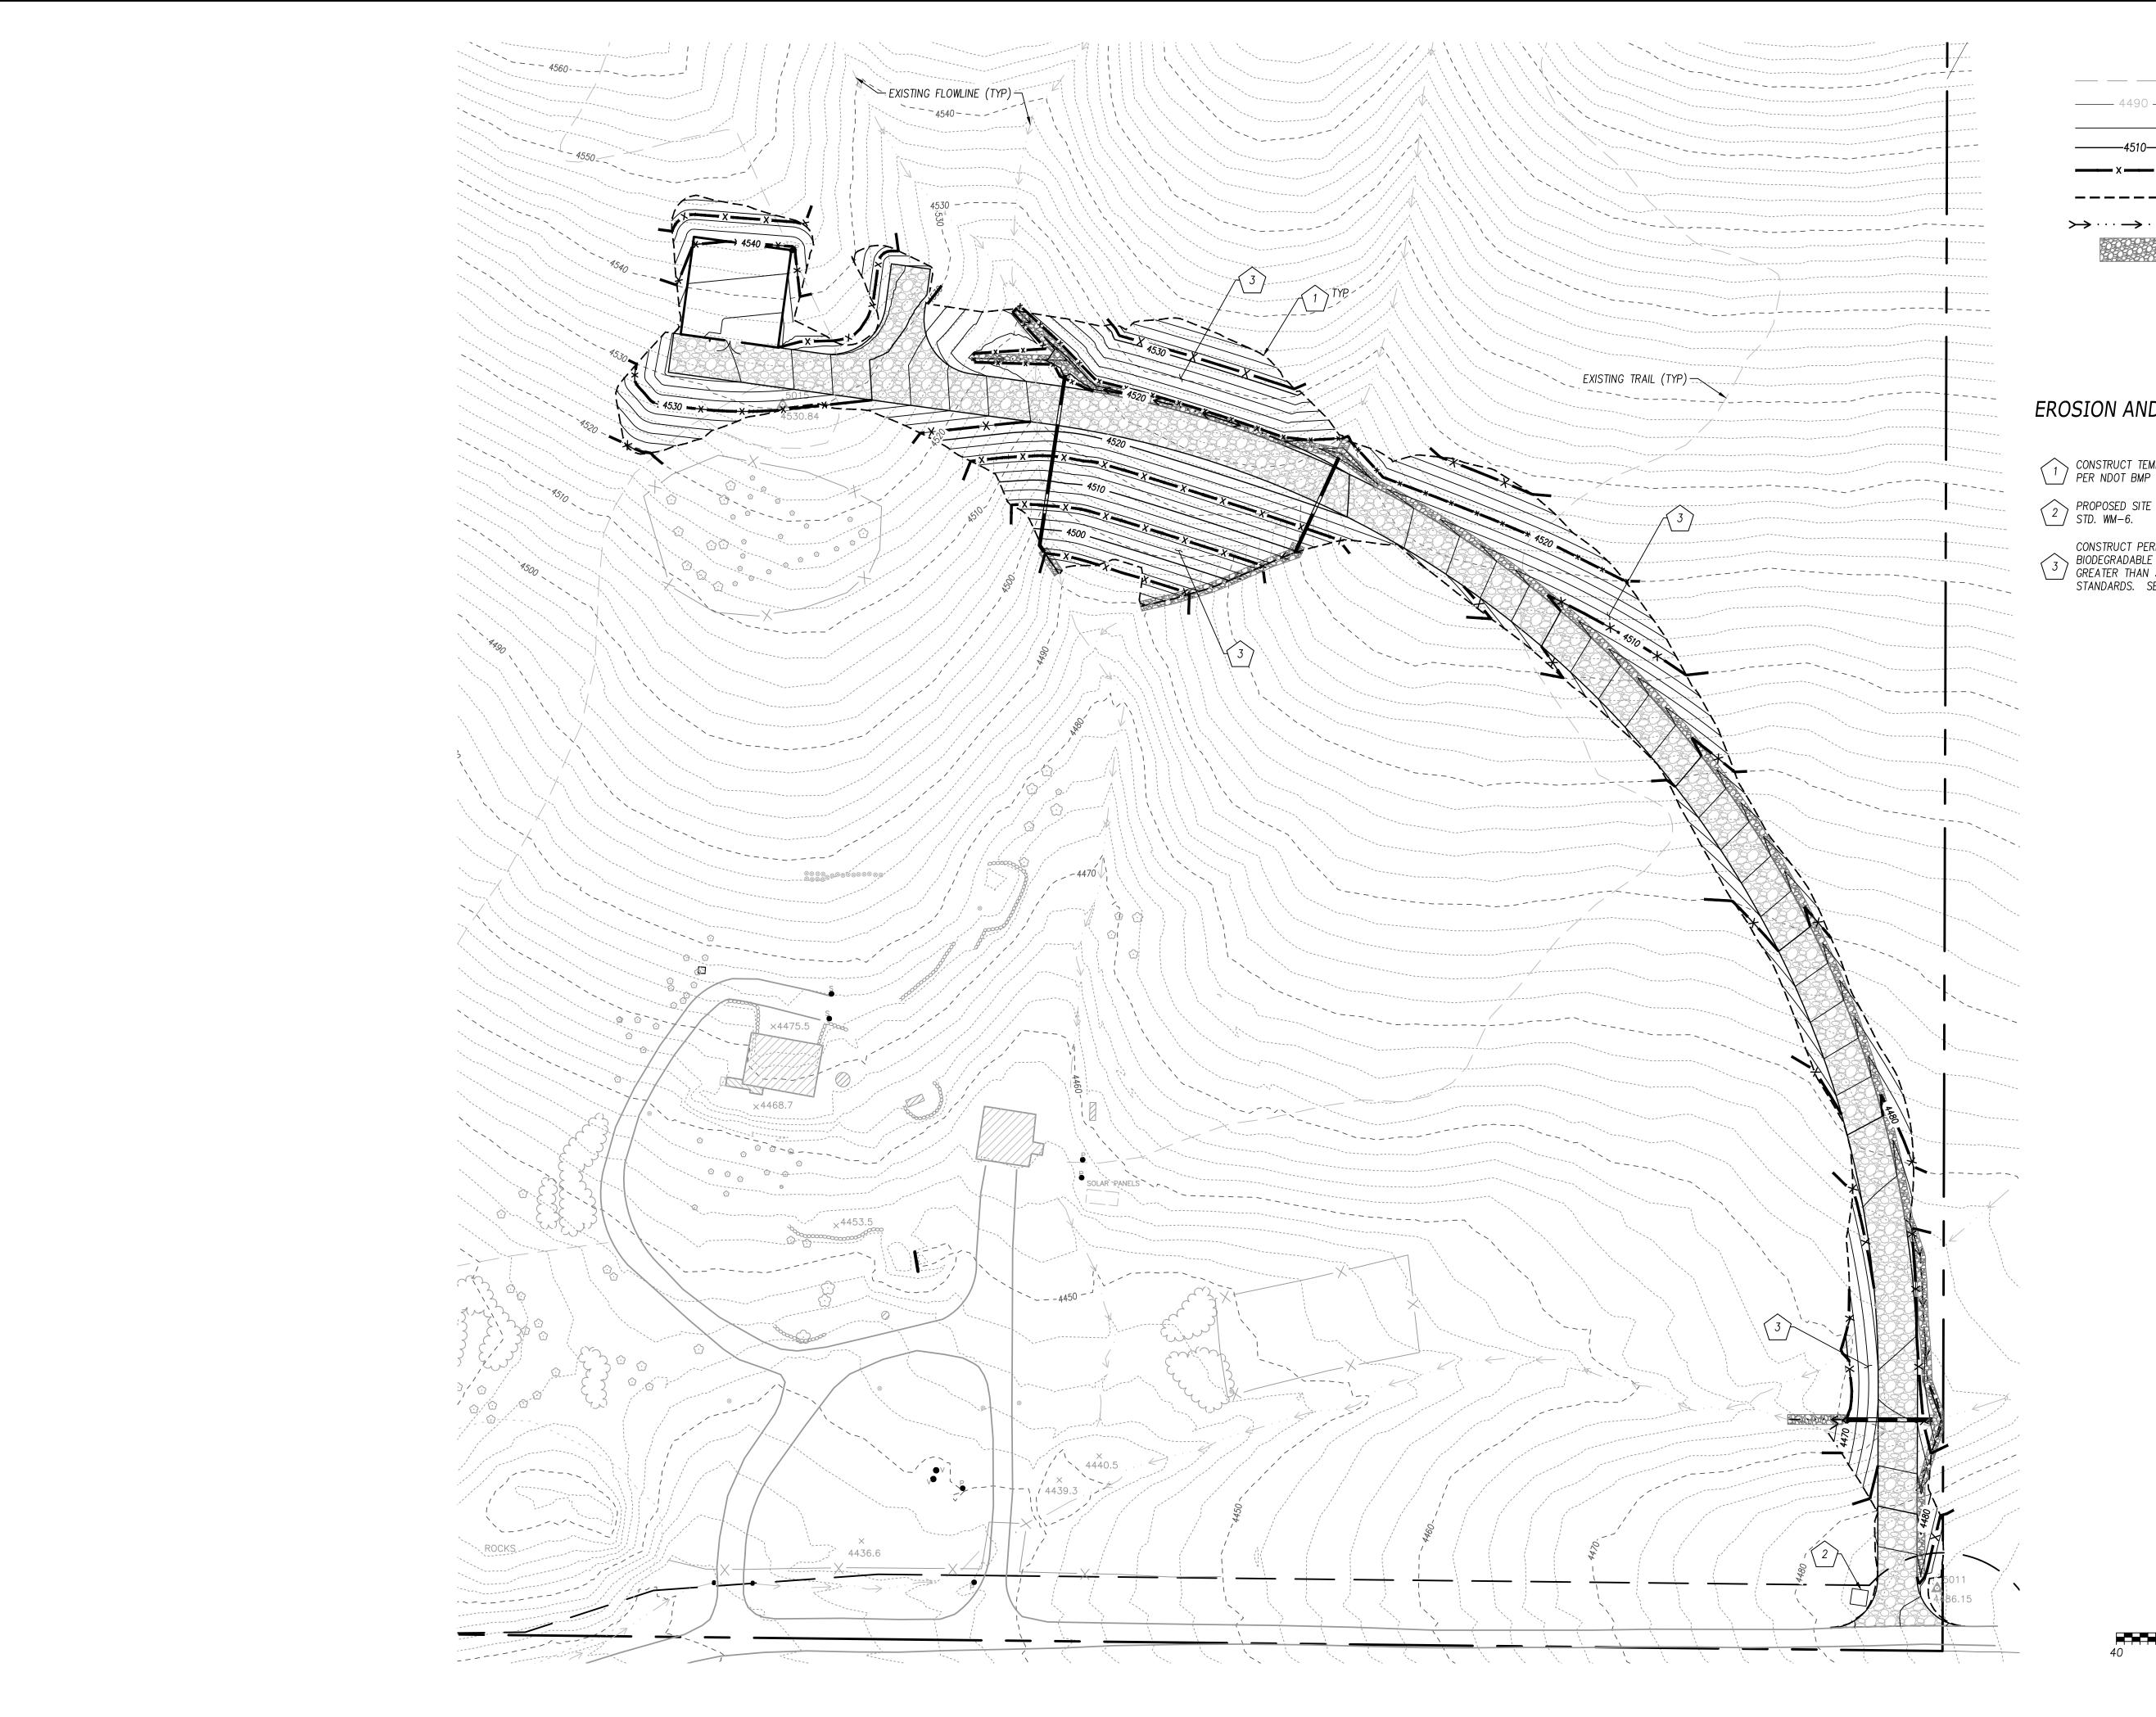

LEGEND

____ EXISTING 2-FT CONTOUR — 4490 — EXISTING 10-FT CONTOUR PROPOSED 2-FT CONTOUR

PROPOSED 10-FT CONTOUR SEDIMENT LOG PER NDOT BMP STD SC-5

LIMITS OF DISTURBANCE/GRADING CATCH


EROSION AND SEDIMENT CONTROL NOTES:

- CONSTRUCT TEMPORARY EROSION CONTROL UTILIZE SEDIMENT LOGS PER NDOT BMP STD. SC-5. SEE DETAIL ON SHEET C2.1.
- PROPOSED SITE CONCRETE WASTE MANAGEMENT AREA PER NDOT BMP STD. WM-6.
- CONSTRUCT PERMANENT EROSION CONTROL TRACKWALK AND INSTALL BIODEGRADABLE ROLLED EROSION CONTROL PRODUCT ON ALL SLOPES GREATER THAN 3H:1V. HYDROSEED WITH MIX MEETING WASHOE COUNTY STANDARDS. SEE NDOT BMP STD. SS—7.

SCALE IN FEET



REVISIONS			
ЛARK	DATE	DESCRIPTION	
Λ			
<u>^2</u>			
<u>/3</u>			
<u> </u>			
<u> </u>			

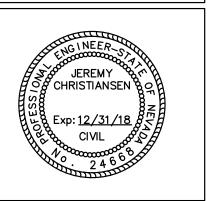

ROLLING THUNDER 5205 WAYSIDE ROAD RENO, NV 89510 APN: 077-350-01

PROJECT#: 217019


SCALE: 1"=40'


07/21/2017 APPROVALS


DESIGNED BY: JDC CHECKED BY: JDC/SL

> SHEET TITLE EROSION AND SEDIMENT CONTROL

SHEET NUMBER

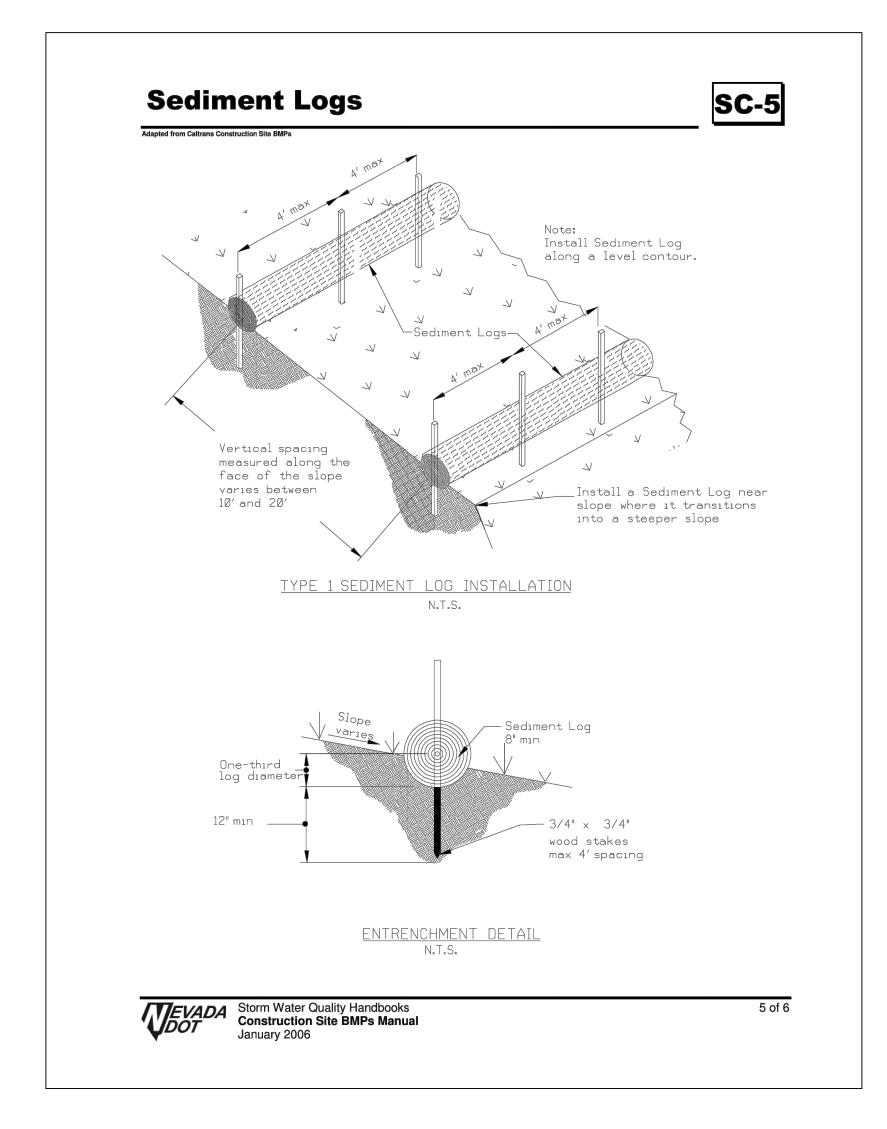


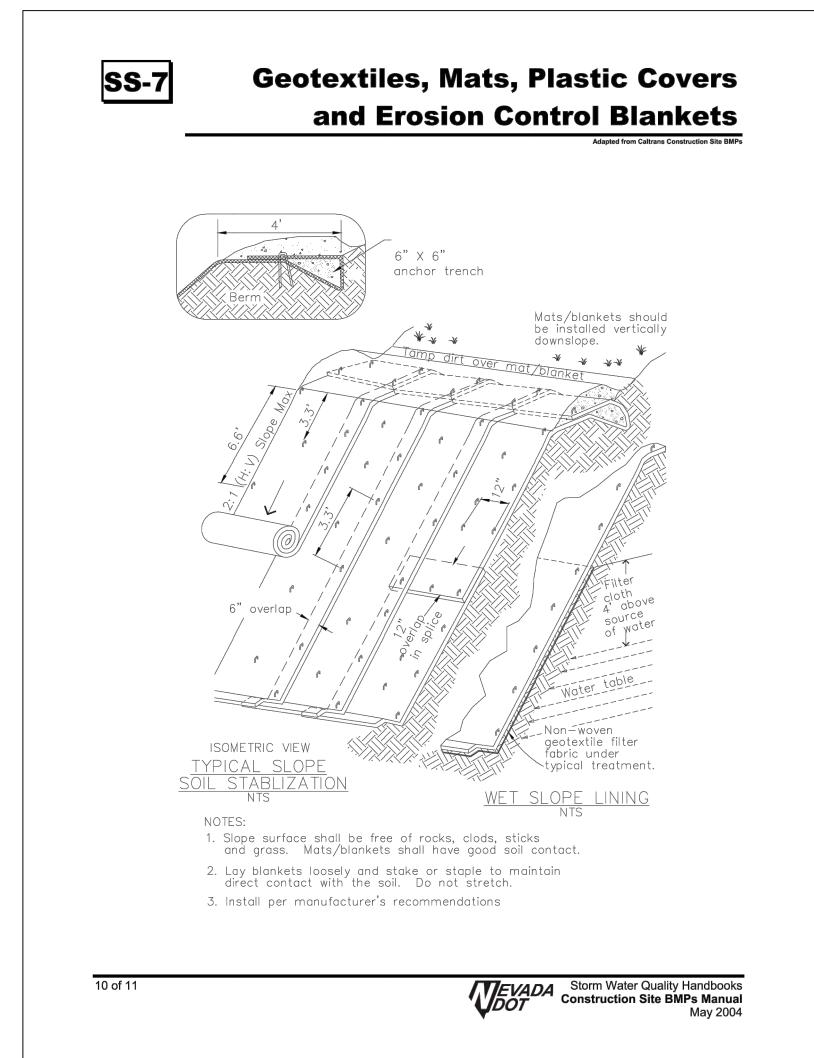

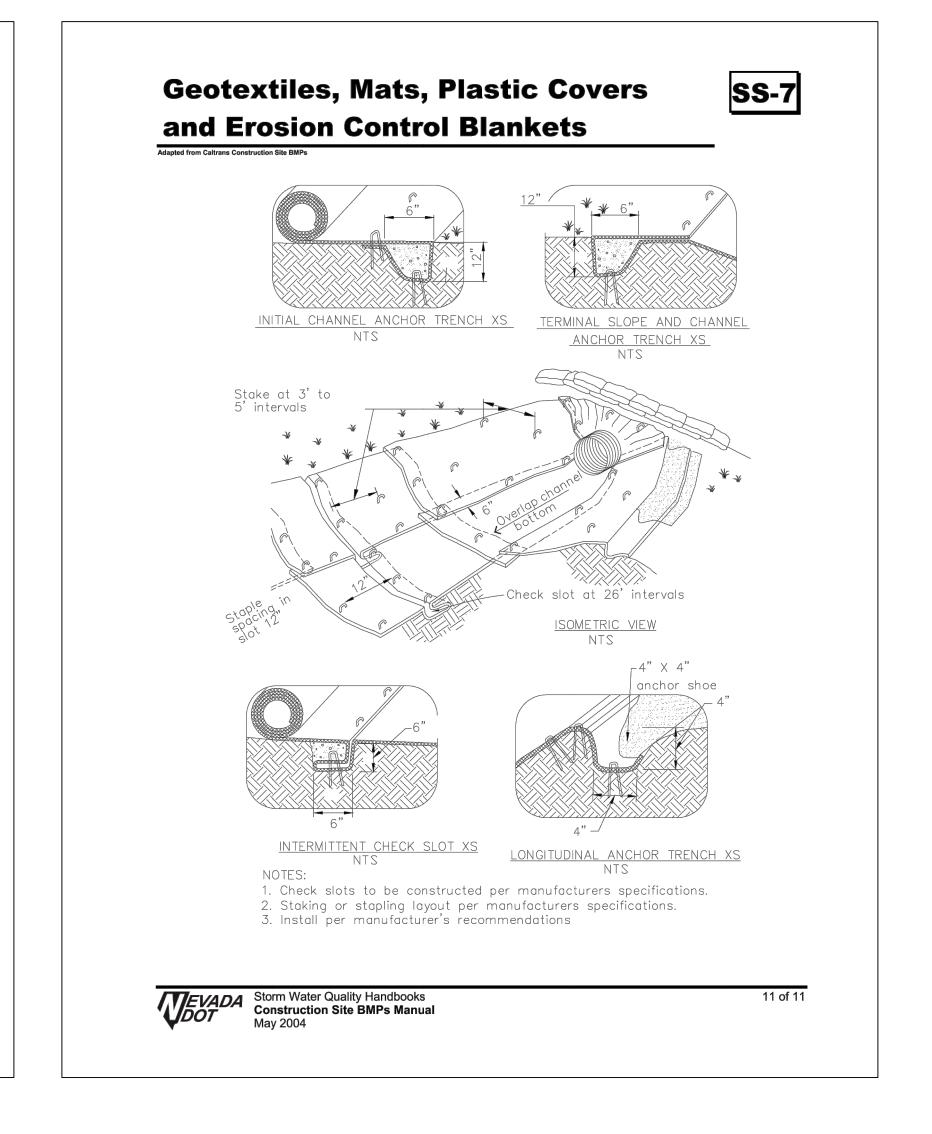



REVISIONS			
MARK	DATE	DESCRIPTION	
1			
2			
3			
4			

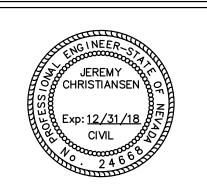

ROLLING THUNDER 5205 WAYSIDE ROAD RENO, NV 89510 APN: 077-350-01

PROJECT#: 217019

SCALE: N/A

DATE: 07/21/2017

APPROVALS

DESIGNED BY: JDC

DRAWN BY: WY


CHECKED BY: JDC/SL


SHEET TITLE

EROSION AND SEDIME

SHEET NUMBER

C2.1

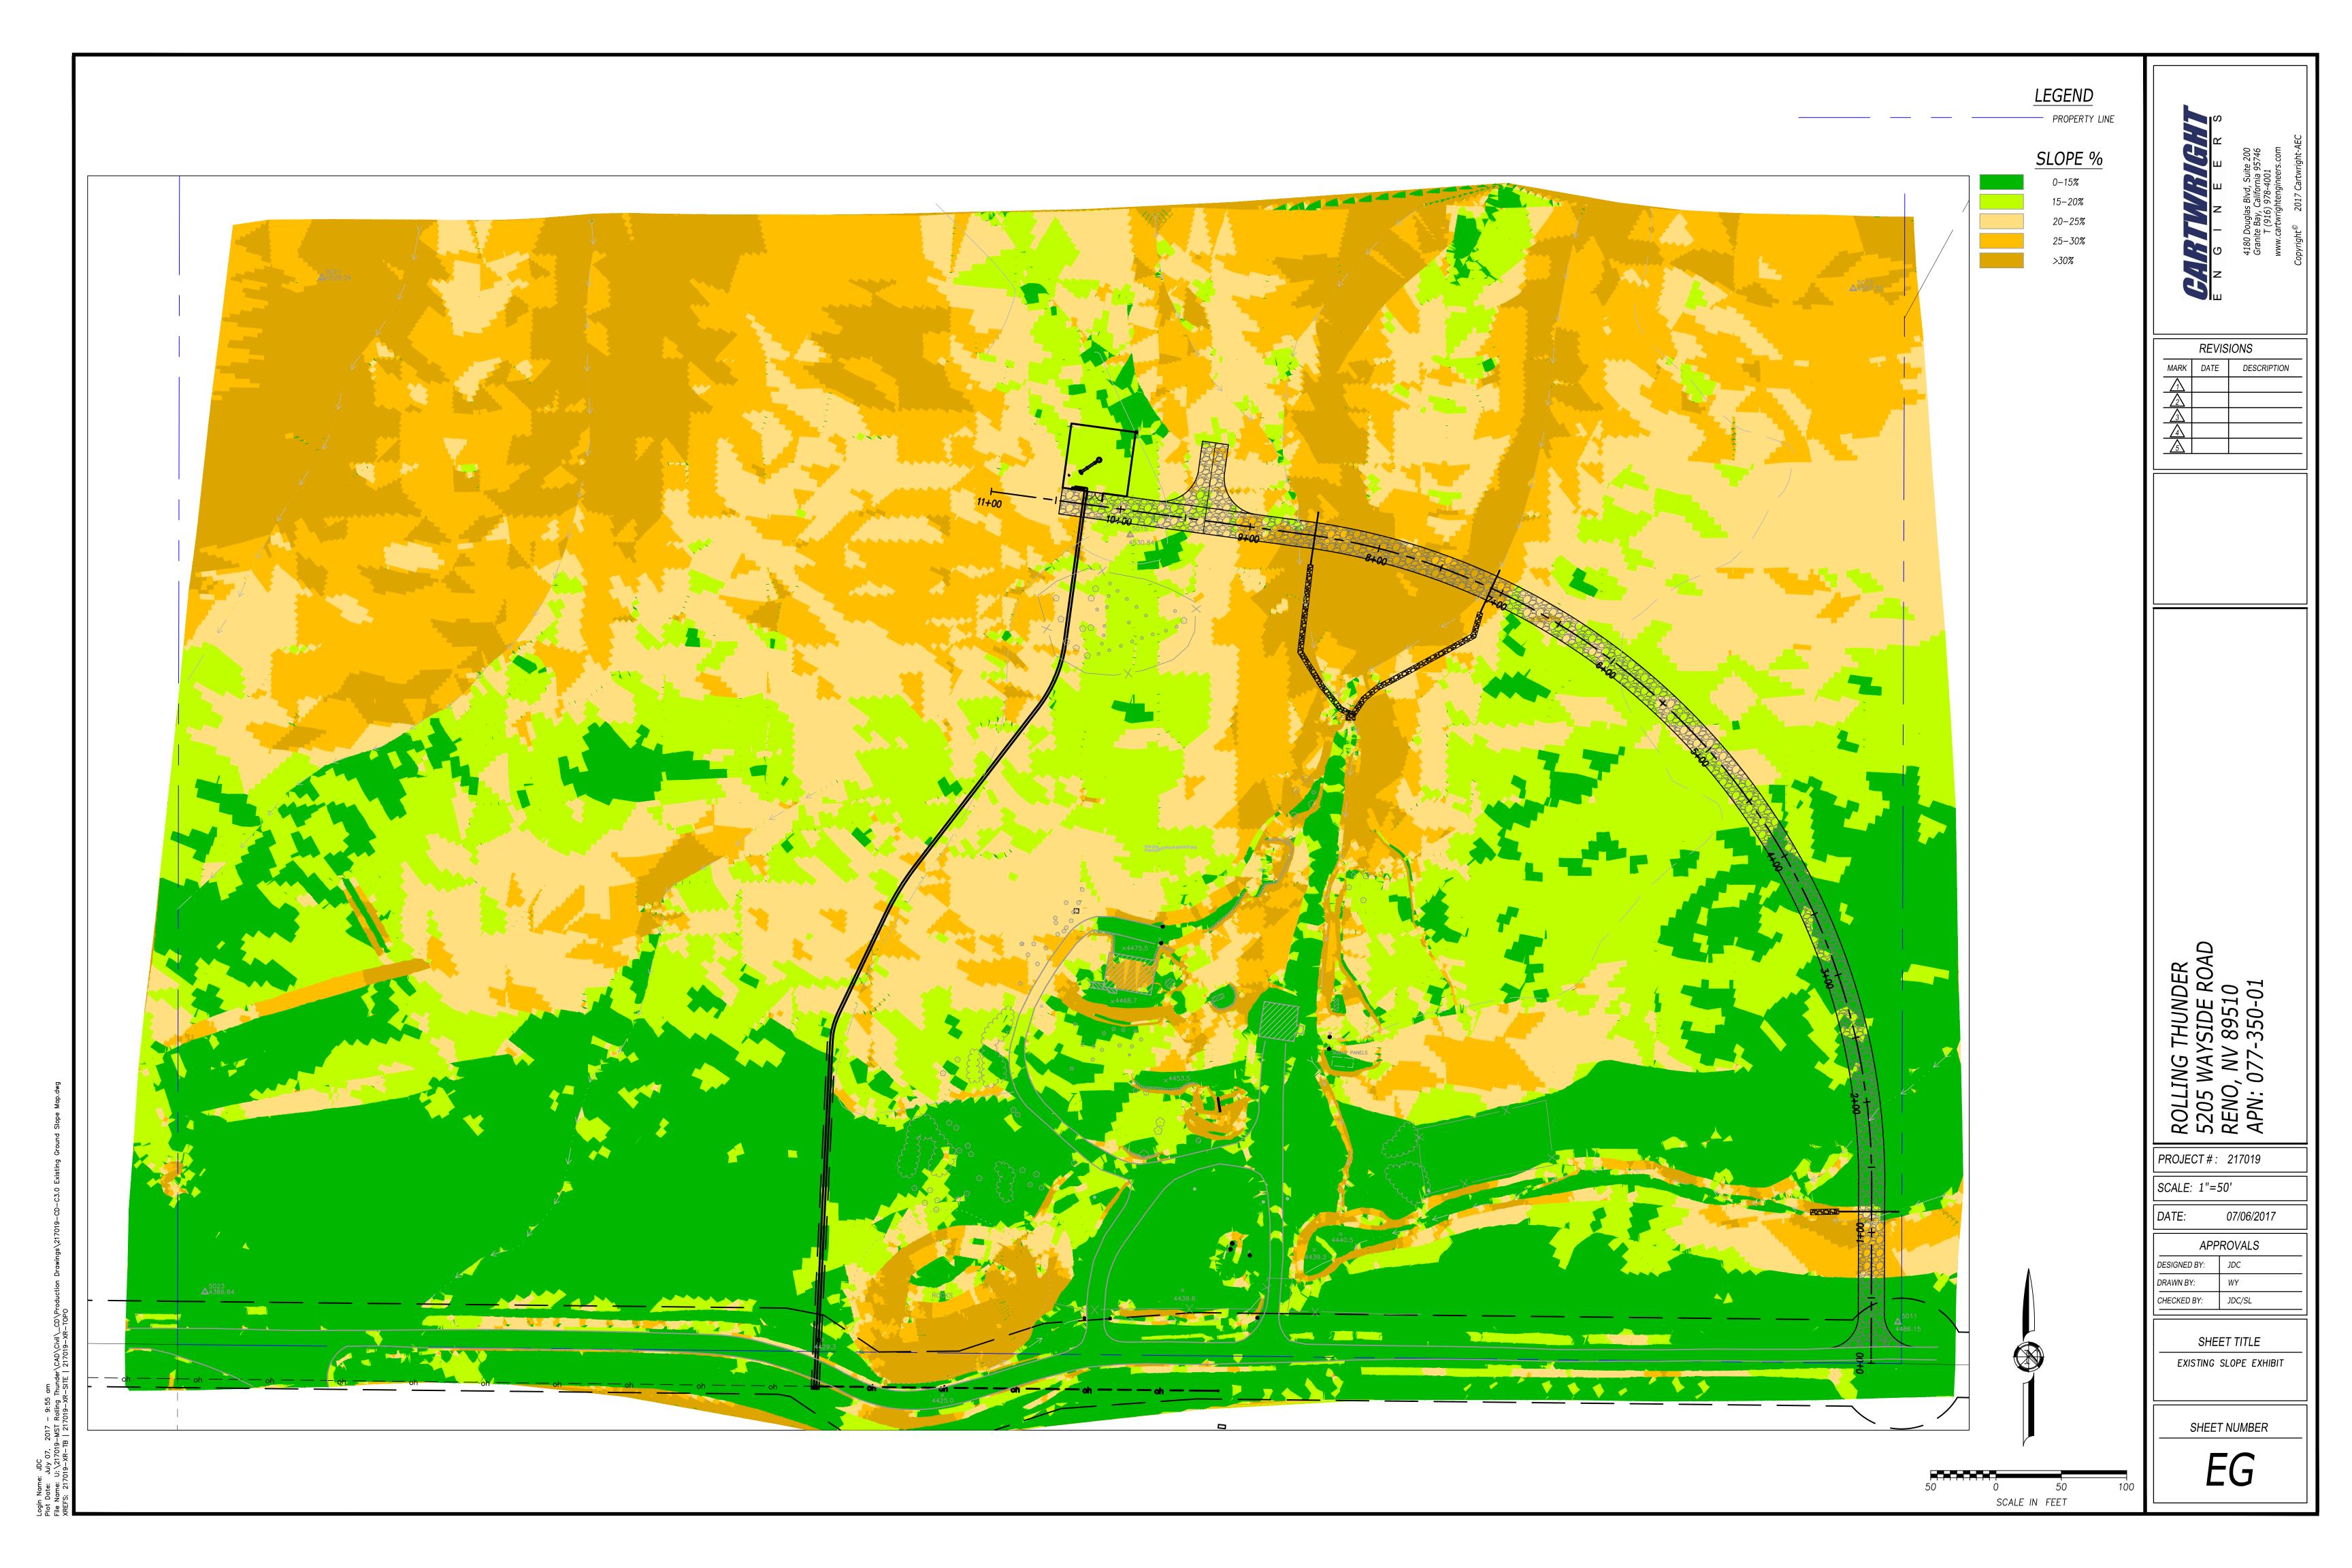

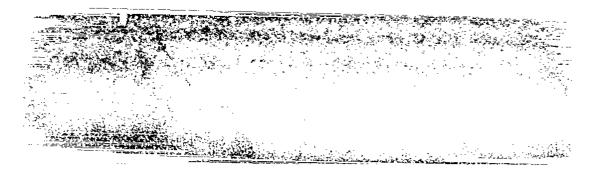

DECLARATION OF VALUE

if exemp	Full Value of Property Interest Conveyed Less Assumed Liens & Encumbrances Taxable Value (NRS 375.010) Real Property Transfer Tax Due st, state reason. NRS 375.090, Section	\$ 58000 \$ 58000 \$ 87 "
	INDIVIDUAL	ESCROW HOLDER
	enalty of perjury. I hereby declare that the above at are correct.	Under penalty of perjury, I hereby declare that the above statements are correct to the best of my knowledge based upon the information available to me in the documents occurained in the encrow file.
	Signature of Declarant	Christeleashenel
	Name (Please Print)	Chris Weather. V
	Address	Name (Pieuse Print) 88698-574
City	State Zip	Escrow Number

City

FIRST CHAT HAMAL TITLE CO. P.O. BOX 10538 RENO, NEW 105310

State

Zip

2252052

DEED

THIS INDENTURE WITNESSETH: That THONAS DONAHUE, an unmarried man, in consideration of the sum of Ten Dollars (\$10.00), the receipt of which is hereby acknowledged, does hereby Grant, Bargain, Sell and convey to BRIAN H. AKRE and MARIA M. AKRE, husband and wife, as joint tenants with right of survivorship, whose address is: ____ 8200 Offenhauser St., \$122-C, Reno, NV. 89511 , all that real property situate in the County of Washoe, State of Nevada, described as follows:

Parcel 33-3-1-8 as shown on Record of Survey map filed in the Office of the Washoe County Recorder, Washoe County, Nevada on November 10, 1976 under File No. 434698 and Division of Land Map filed in the Office of the Washoe County, Recorder, Washoe County, Nevada under File No. 434701 more particularly described as follows:

A portion of the Southeast 1/4 of Section 33, Township 23 North, Range 21 East, M.D.B&M., in the County of Washoe, State of Nevada, being more particularly described as follows:

Commencing at the Northwest corner of Section 33; thence South 89'01'05" East, 5,304.30 feet; thence South 00'10'11" West, 3,841.54 feet to the True Point of Beginning; thence South 00'10'11" West, 1,399.87 feet: thence North 89'21'10" West 1,319.24 feet; thence North 00°05'46" East, 1,402.15 feet; thence South 89°15'17" East, 1,321.07 feet to the True Point of Beginning.

TOGETHER WITH all and singular the tenements, hereditaments and appurtenances thereunto belonging or in anywise appertaining.


DATED October 2 , 1998.

STATE OF NEVADA

38

This instrument was acknowledged before me on Od. 3,1998 1998, by THOMAS DONAHUE.

Notary Public

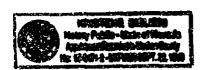

OFFICIAL RECORDS WASHOE COUNTY, NEV. RECORD REQUESTED BY FIRST CENTENNIAL TITLE CO. OF NEVADA

COUNTY RECORDER FL: 70 00 GS

e Pope

COUNTY OF WASHOE

2262052

Account Detail

Back to Account Detail

Change of Address

Print this Page

Washoe County Parcel Information			
Parcel ID	Status	Last Update	
07735001	Active	7/10/2017 2:09:40 AM	
Current Owner:	SITUS:		

AKRE, BRIAN M & MARIA M

5205 WAYSIDE RD WCTY NV

PO BOX 7710 RENO, NV 89510

Taxing District Geo CD:

Legal Description

Range 21 Section 33 SubdivisionName _UNSPECIFIED Township 23

Tax Bill (Click on desired tax year for due dates and further details)					
Tax Year	Net Tax	Total Paid	Penalty/Fees	Interest	Balance Due
2017	\$1,593.10	\$0.00	\$0.00	\$0.00	\$1,593.10
2016	\$1,552.73	\$1,552.73	\$0.00	\$0.00	\$0.00
2015	\$1,549.63	\$1,549.63	\$0.00	\$0.00	\$0.00
2014	\$1,504.50	\$1,504.50	\$0.00	\$0.00	\$0.00
2013	\$1,460.68	\$1,460.68	\$0.00	\$0.00	\$0.00
				Total	\$1,593.10

Important Payment Information

- ALERTS: If your real property taxes are delinquent, the search results displayed may not reflect the correct amount owing. Please contact our office for the current amount due.
- For your convenience, online payment is available on this site. E-check payments are accepted without a fee. However, a service fee does apply for online credit card payments. See Payment Information for details.

Pay Online			
Payments will be applied to the oldest charge first.			
Select a payment option:			
Total DueOldest DuePartial	\$1,593.10 \$398.28		
ADD TO CART			



Pay By Check

Please make checks payable to: WASHOE COUNTY TREASURER

Mailing Address: P.O. Box 30039 Reno, NV 89520-3039

Overnight Address: 1001 E. Ninth St., Ste D140 Reno, NV 89512-2845









The Washoe County Treasurer's Office makes every effort to produce and publish the most current and accurate information possible. No warranties, expressed or implied, are provided for the data herein, its use, or its interpretation. If you have any questions, please contact us at (775) 328-2510 or tax@washoecounty.us